


111 UPGRADE POOL LOCKER ROOMS
PROJECT NO.: 695-14-114

CAMPUS MAP

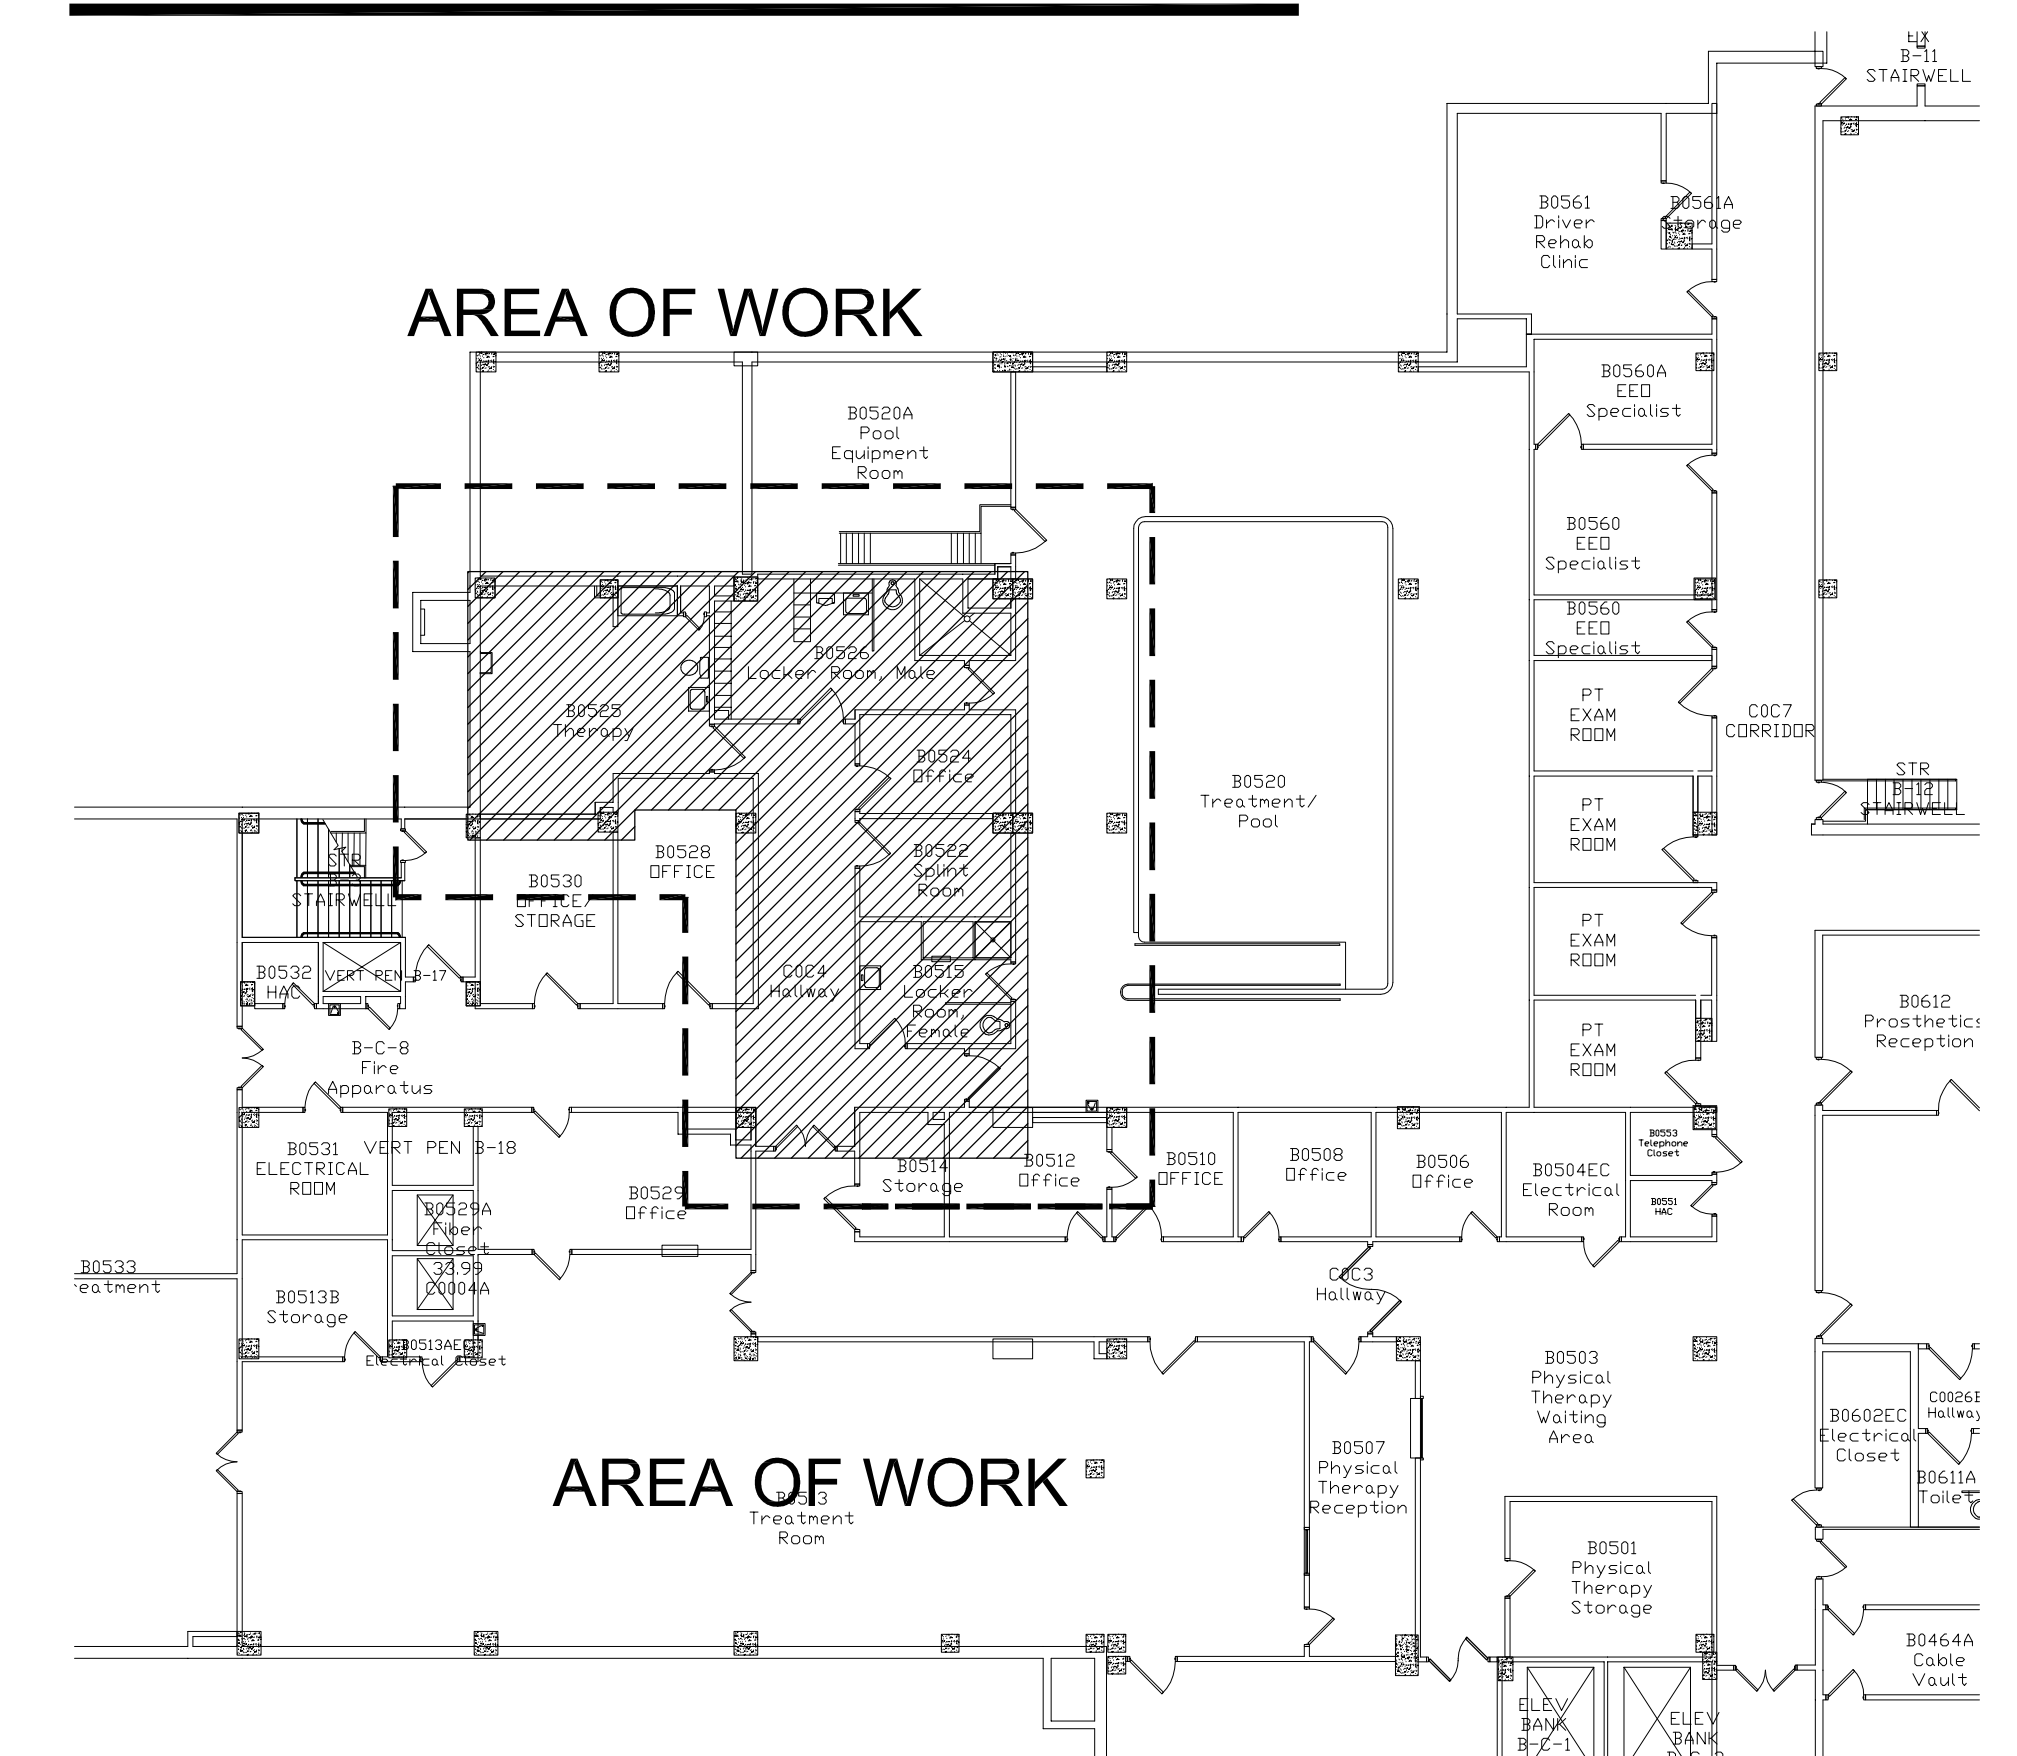

Available Drawings


VA FORM 08-6231




| | | |
|-----------|---|---|
| CLASS II | <p>1. Execute work by methods to minimize raising dust from construction operations.</p> <p>2. Immediately replace a ceiling tile displaced for visual inspection</p> | |
| CLASS II | <p>1. Provide active means to prevent airborne dust from entering into atmosphere.</p> <p>2. Water mist work surfaces to control dust while cutting.</p> <p>3. Seal unused doors with dust tape.</p> <p>4. Block off and seal air vents.</p> <p>5. Place dust mat at entrance and exit of work area</p> <p>* Remove or isolate HVAC system in areas where work is being performed.</p> <p>1. *Remove or isolate HVAC system in area where work is being done to prevent contamination of dust system</p> <p>2. Complete all critical barriers i.e. sheetrock, plywood, plastic, to seal area from non-work area or implement control cable method (cart with plastic covering and sealed connection to work site with HEPA vacuum for vacuuming prior to exit) before construction begins.</p> <p>3. Maintain negative air pressure within work site utilizing HEPA equipped air filtration units.</p> <p>4. Contain construction waste before transport in tightly covered containers.</p> <p>5. Cover transport receptacles or carts. Tape covering unless solid lid.</p> <p>* Use windows for negative HEPA air exhaust when accessible. Obtain V.A. resident engineer approval for exhausting in existing exhaust ductwork.</p> | <p>1. Wipe work surfaces with disinfectant.</p> <p>2. Contain construction waste before transport in tightly covered containers.</p> <p>3. Wet mop and/or vacuum with HEPA filtered vacuum before leaving work area.</p> <p>4. Remove isolation of HVAC system in areas where work is being performed.</p> |
| CLASS III | <p>1. *Remove or isolate HVAC system in area where work is being done to prevent contamination of dust system</p> <p>2. Complete all critical barriers i.e. sheetrock, plywood, plastic, to seal area from non-work area or implement control cable method (cart with plastic covering and sealed connection to work site with HEPA vacuum for vacuuming prior to exit) before construction begins.</p> <p>3. Maintain negative air pressure within work site utilizing HEPA equipped air filtration units.</p> <p>4. Contain construction waste before transport in tightly covered containers.</p> <p>5. Cover transport receptacles or carts. Tape covering unless solid lid.</p> <p>* Use windows for negative HEPA air exhaust when accessible. Obtain V.A. resident engineer approval for exhausting in existing exhaust ductwork.</p> | <p>1. Do not remove barriers from work area until completed project is inspected by the owner's Safety Department and Infection Control Department and thoroughly cleaned by the owner's Environmental Services Department.</p> <p>2. Remove barrier materials carefully to minimize spreading of dirt and debris associated with construction.</p> <p>3. Vacuum work area with HEPA filtered vacuums.</p> <p>4. Wet mop with disinfectant.</p> <p>5. Remove isolation of HVAC system in areas where work is being performed.</p> |
| CLASS IV | <p>1. Isolate HVAC system in area where work is being done to prevent contamination of dust system</p> <p>2. Complete all critical barriers i.e. sheetrock, plywood, plastic, to seal area from non-work area or implement control cable method (cart with plastic covering and sealed connection to work site with HEPA vacuum for vacuuming prior to exit) before construction begins.</p> <p>3. Maintain negative air pressure within work site utilizing HEPA equipped air filtration units.</p> <p>4. Seal holes, pipes, conduits, and punctures appropriately.</p> <p>5. Construct anteroom and require all personnel to pass through this room so they can be vacuumed using a HEPA vacuum cleaner before entering work site or they can wear cloth or paper coveralls that are removed each time they leave the work site.</p> <p>6. All personnel entering work site are required to wear shoe covers. Shoe covers must be changed each time the worker exits the work area.</p> <p>7. Do not remove barriers from work area until completed project is inspected by the owner's Safety Department and Infection Control Department and thoroughly cleaned by the owner's Environmental Services Department.</p> | <p>1. Remove barrier material carefully to minimize spreading of dirt and debris associated with construction.</p> <p>2. Contain construction waste before transport in tightly covered containers or carts. Tape covering unless solid lid.</p> <p>4. Vacuum work area with HEPA filtered vacuums.</p> <p>5. Wet mop area with disinfectant.</p> <p>6. Remove isolation of HVAC system in areas where work is being performed.</p> |

A map of the United Kingdom with a blue outline. A small rectangular area in the north-west corner is shaded in light grey, indicating the location of the study area.


three inches = one foot
one and one half inches = one foot
one inch = one foot
three quarters inch = one foot
one half inch = one foot
three eighths inch = one foot
one quarter inch = one foot
one eighth inch = one foot

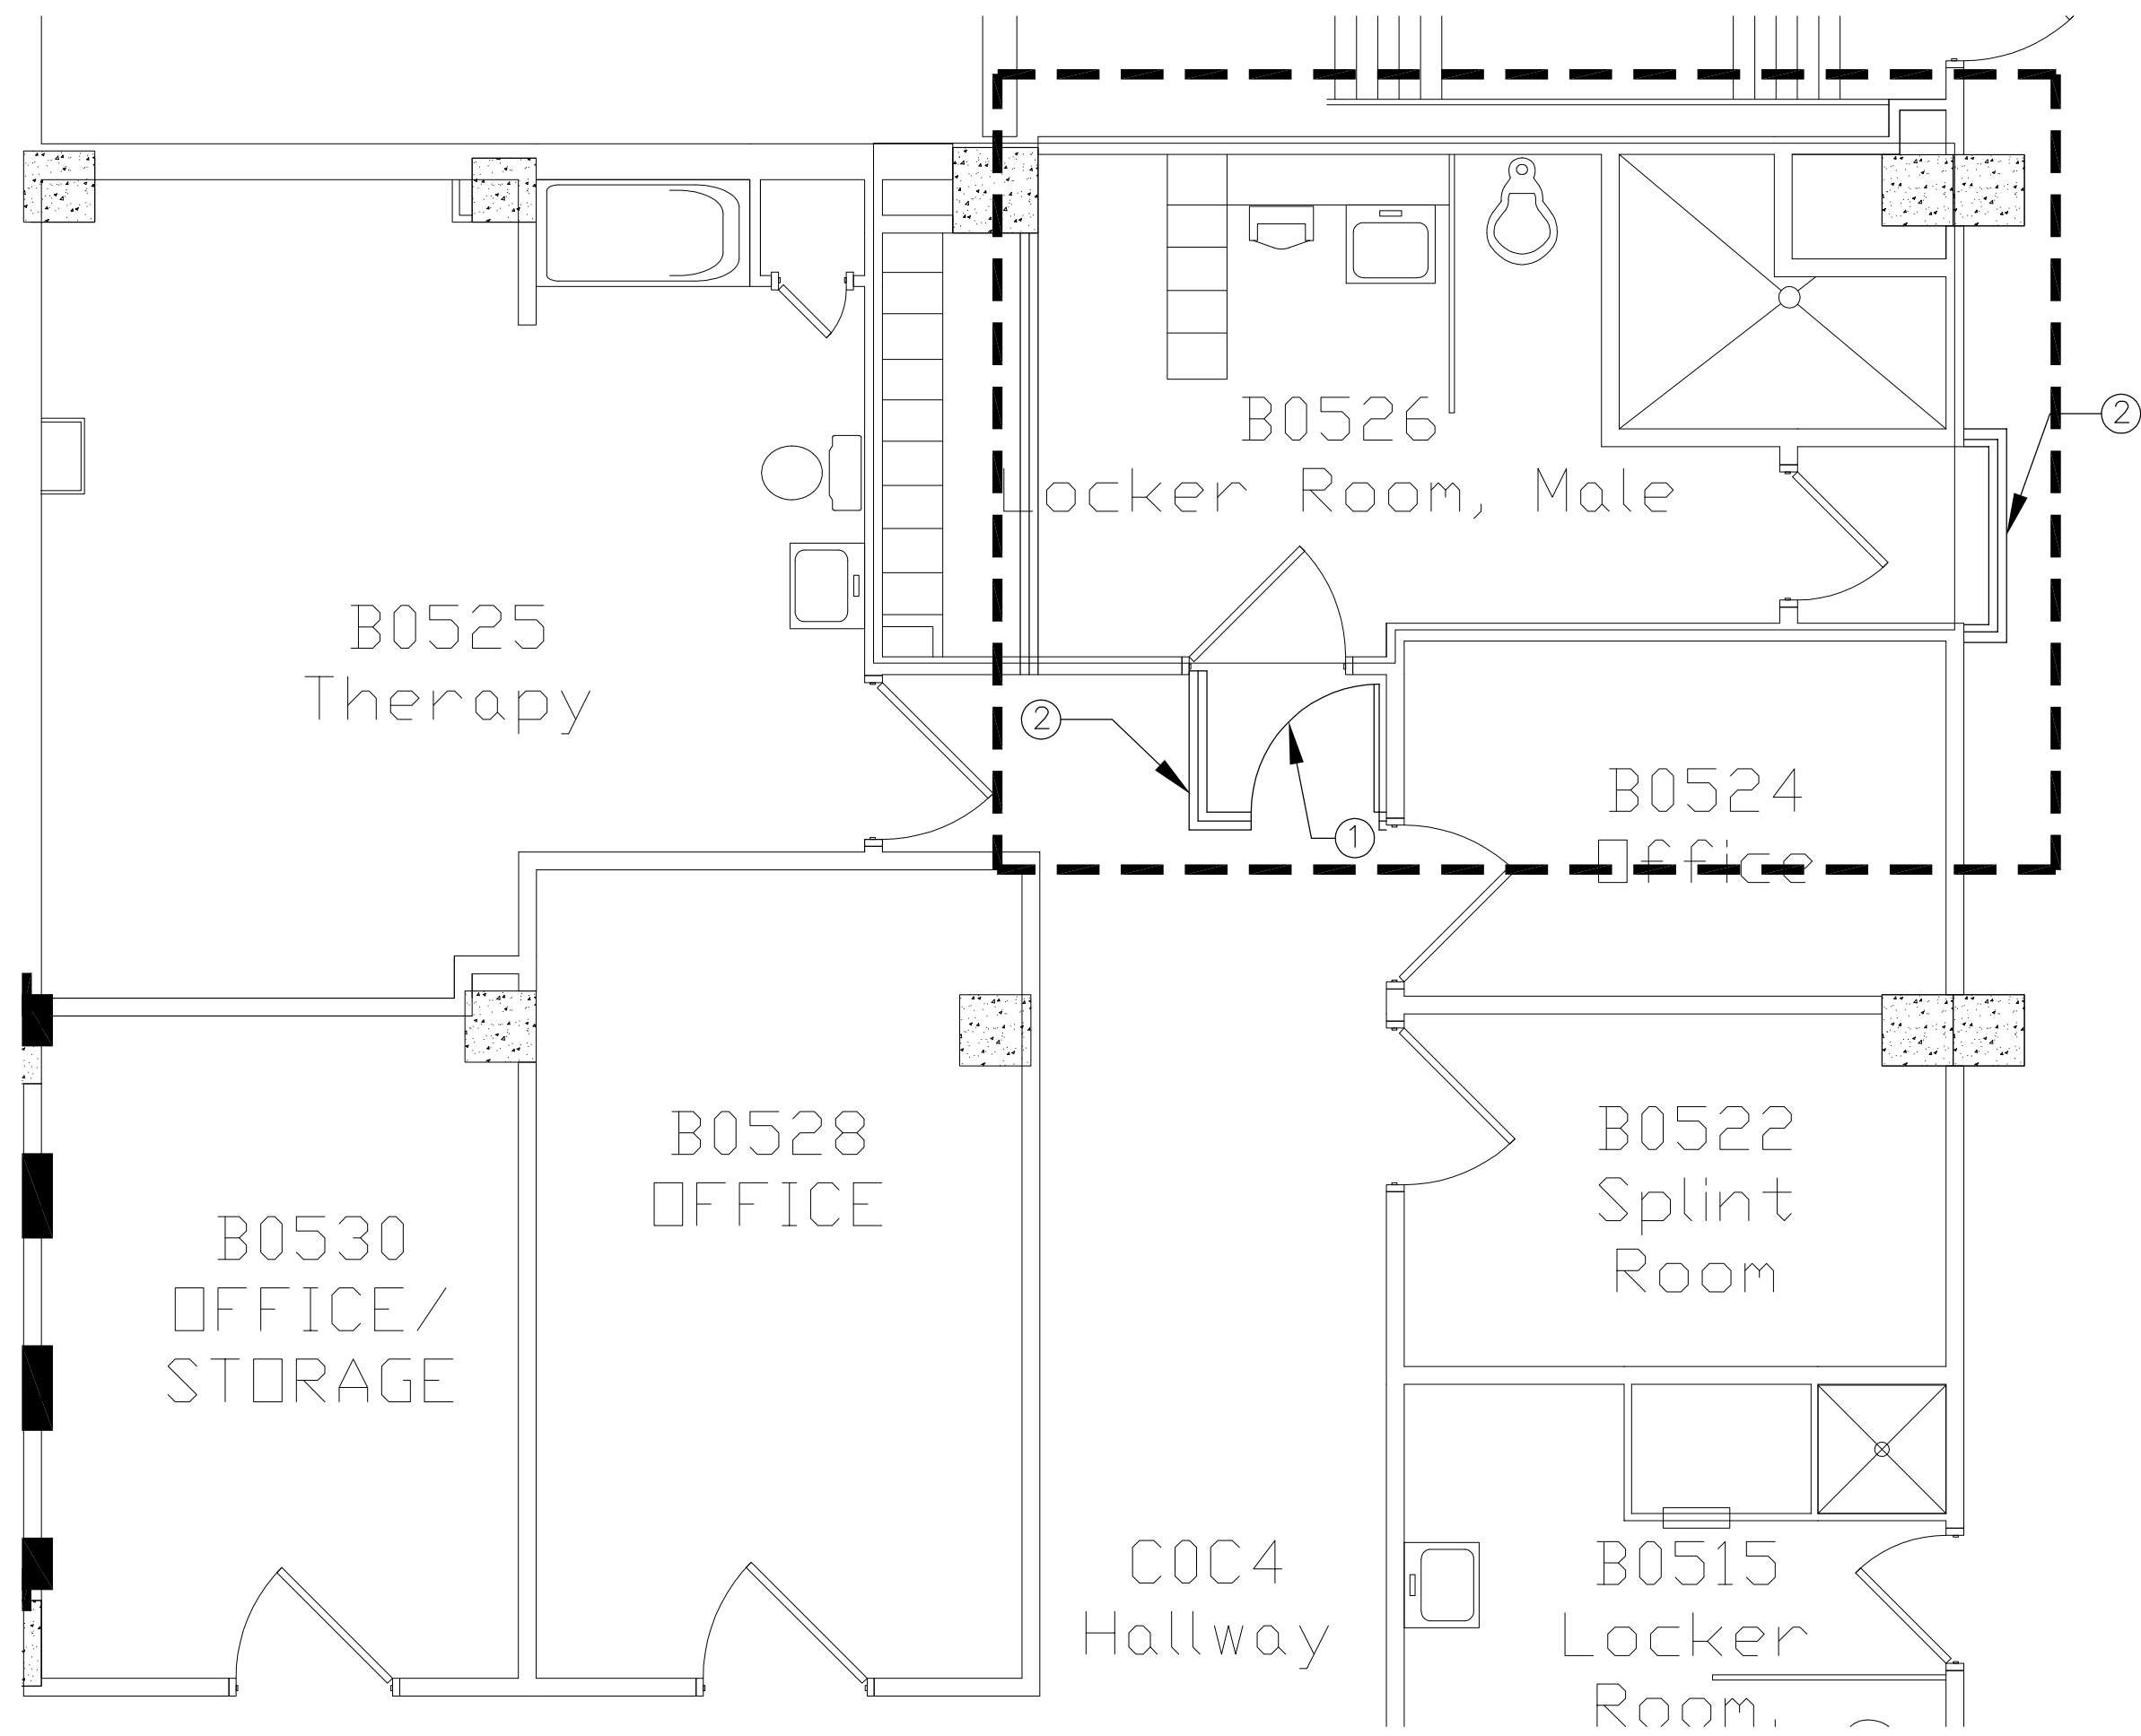

3 PHASE 3 - MENS LOCKER ROOM WITH INFECTION CONTROL / CONSTRUCTION BARRIER
G-002 1/4" = 1'-0"

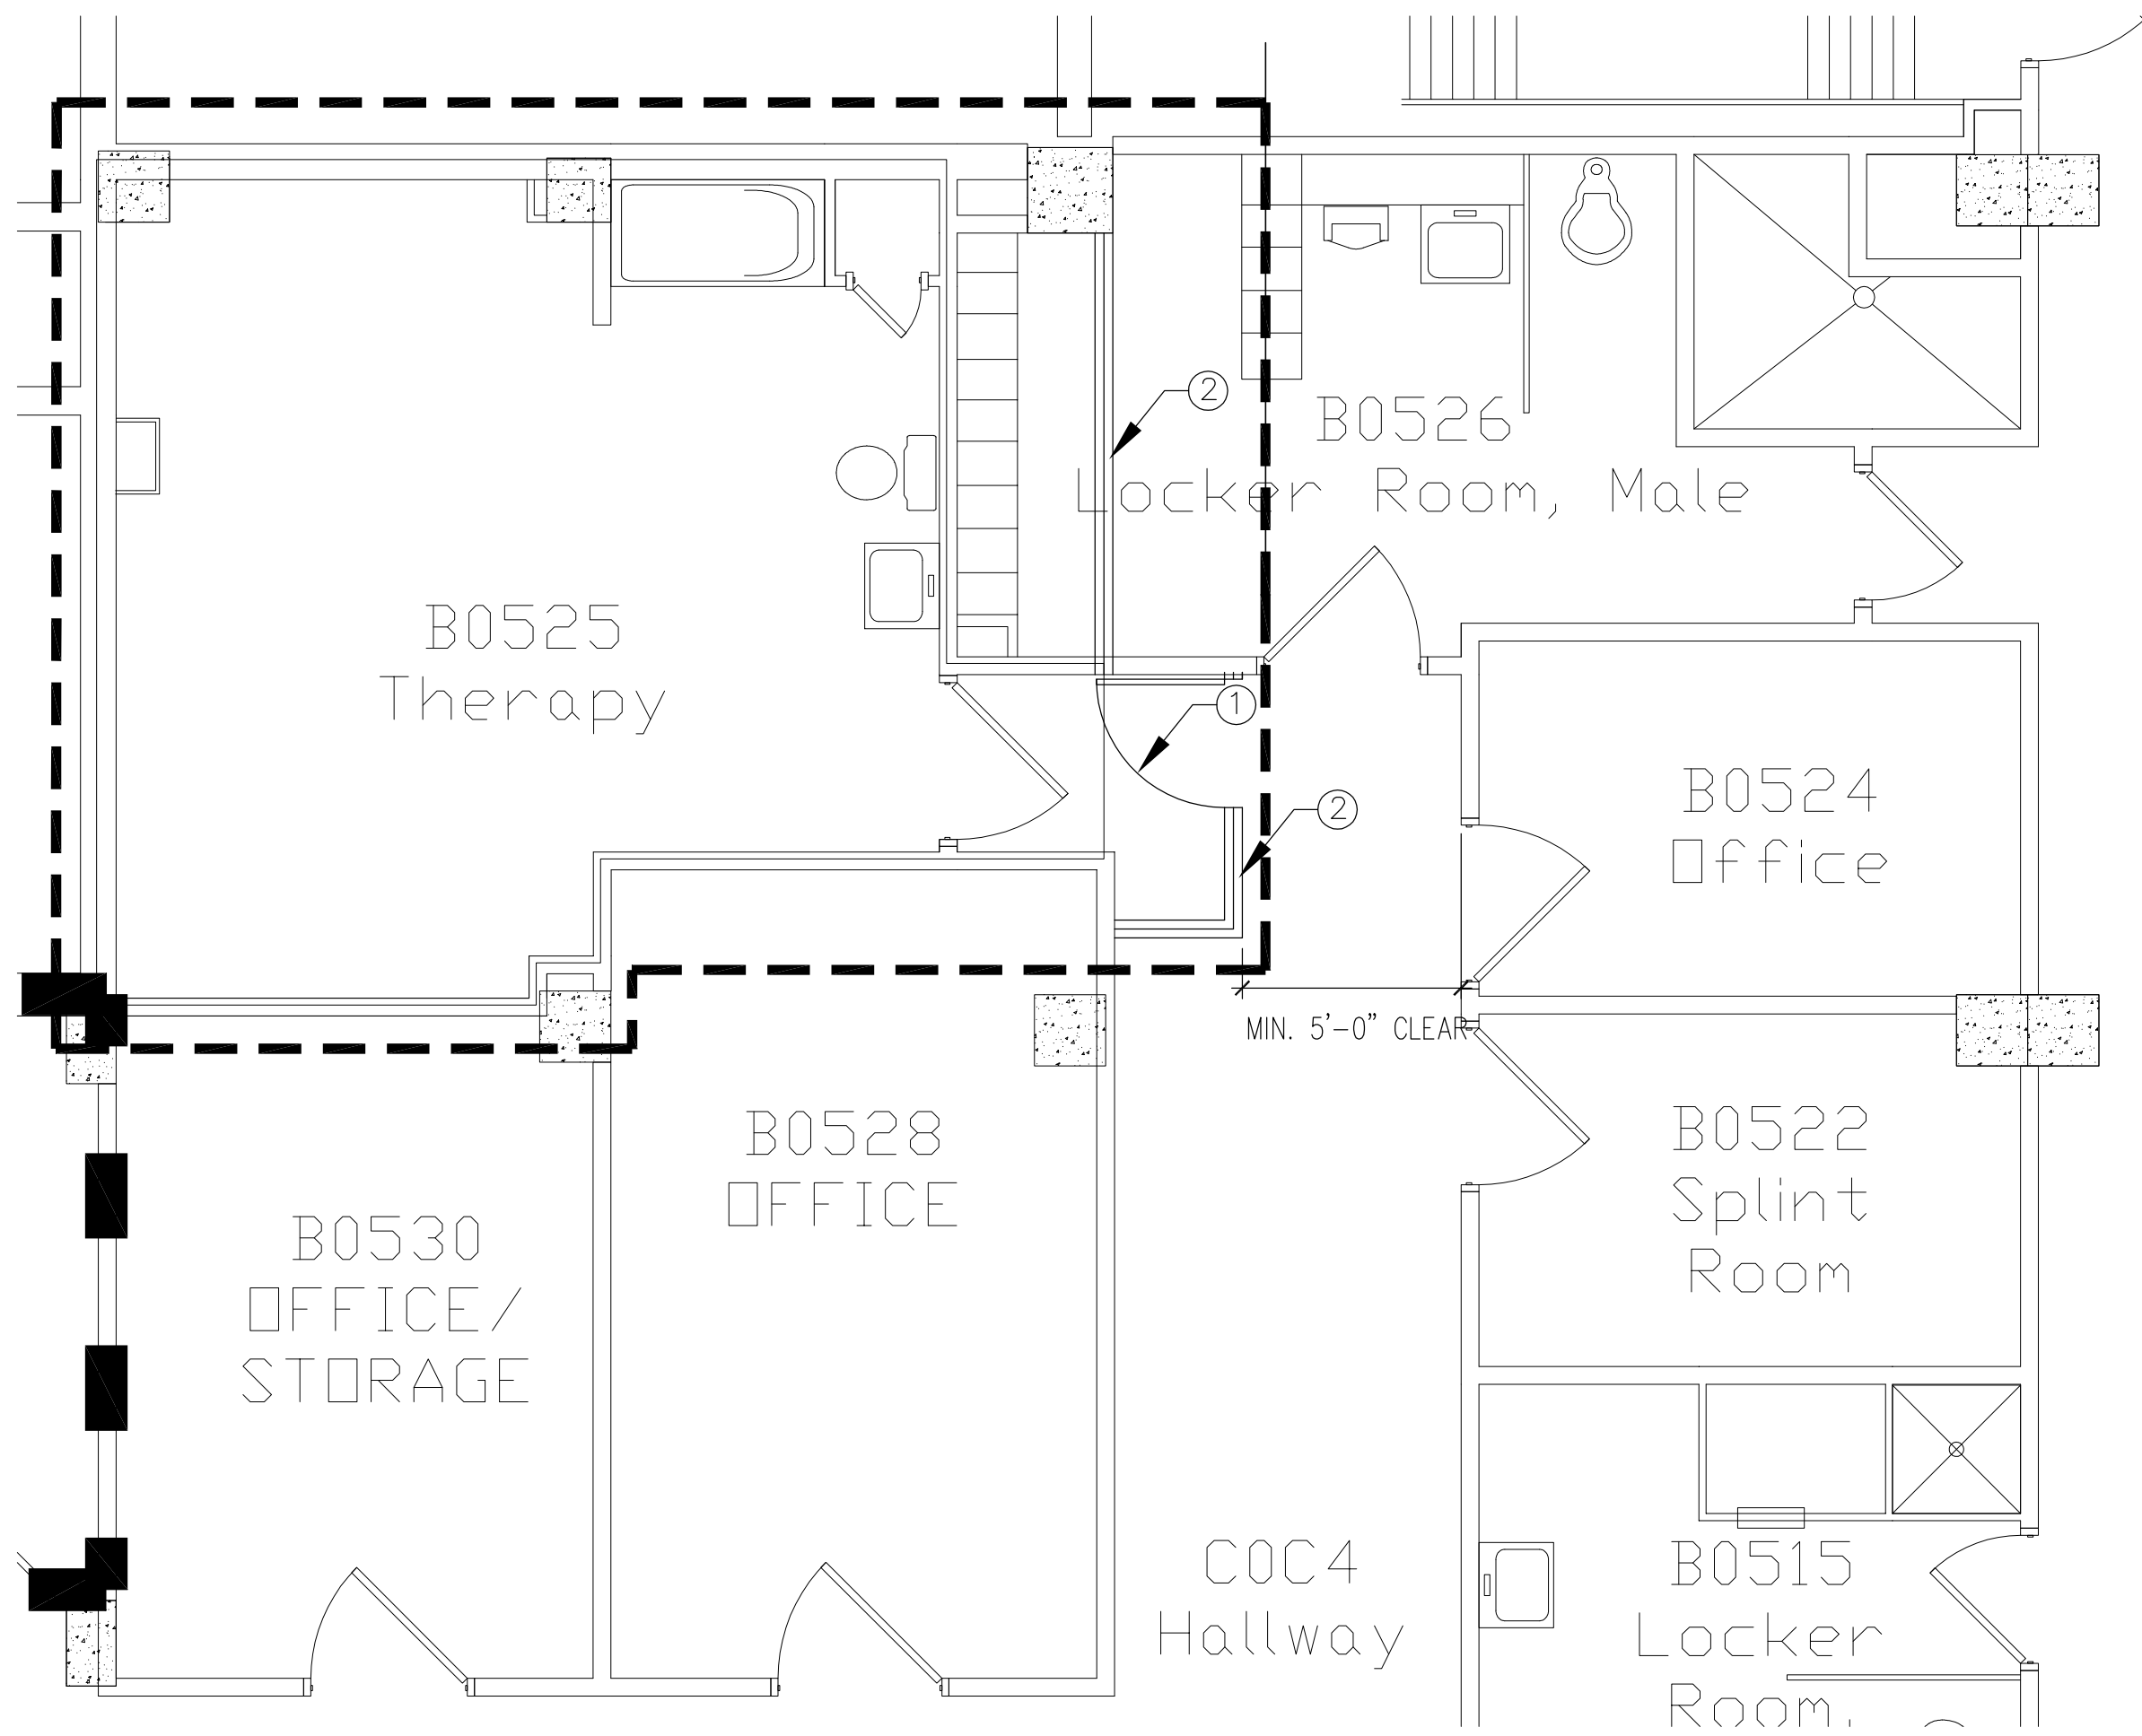

1 PHASE 1 - MENS BATHROOM WITH INFECTION CONTROL / CONSTRUCTION BARRIER
G-002 1/4" = 1'-0"

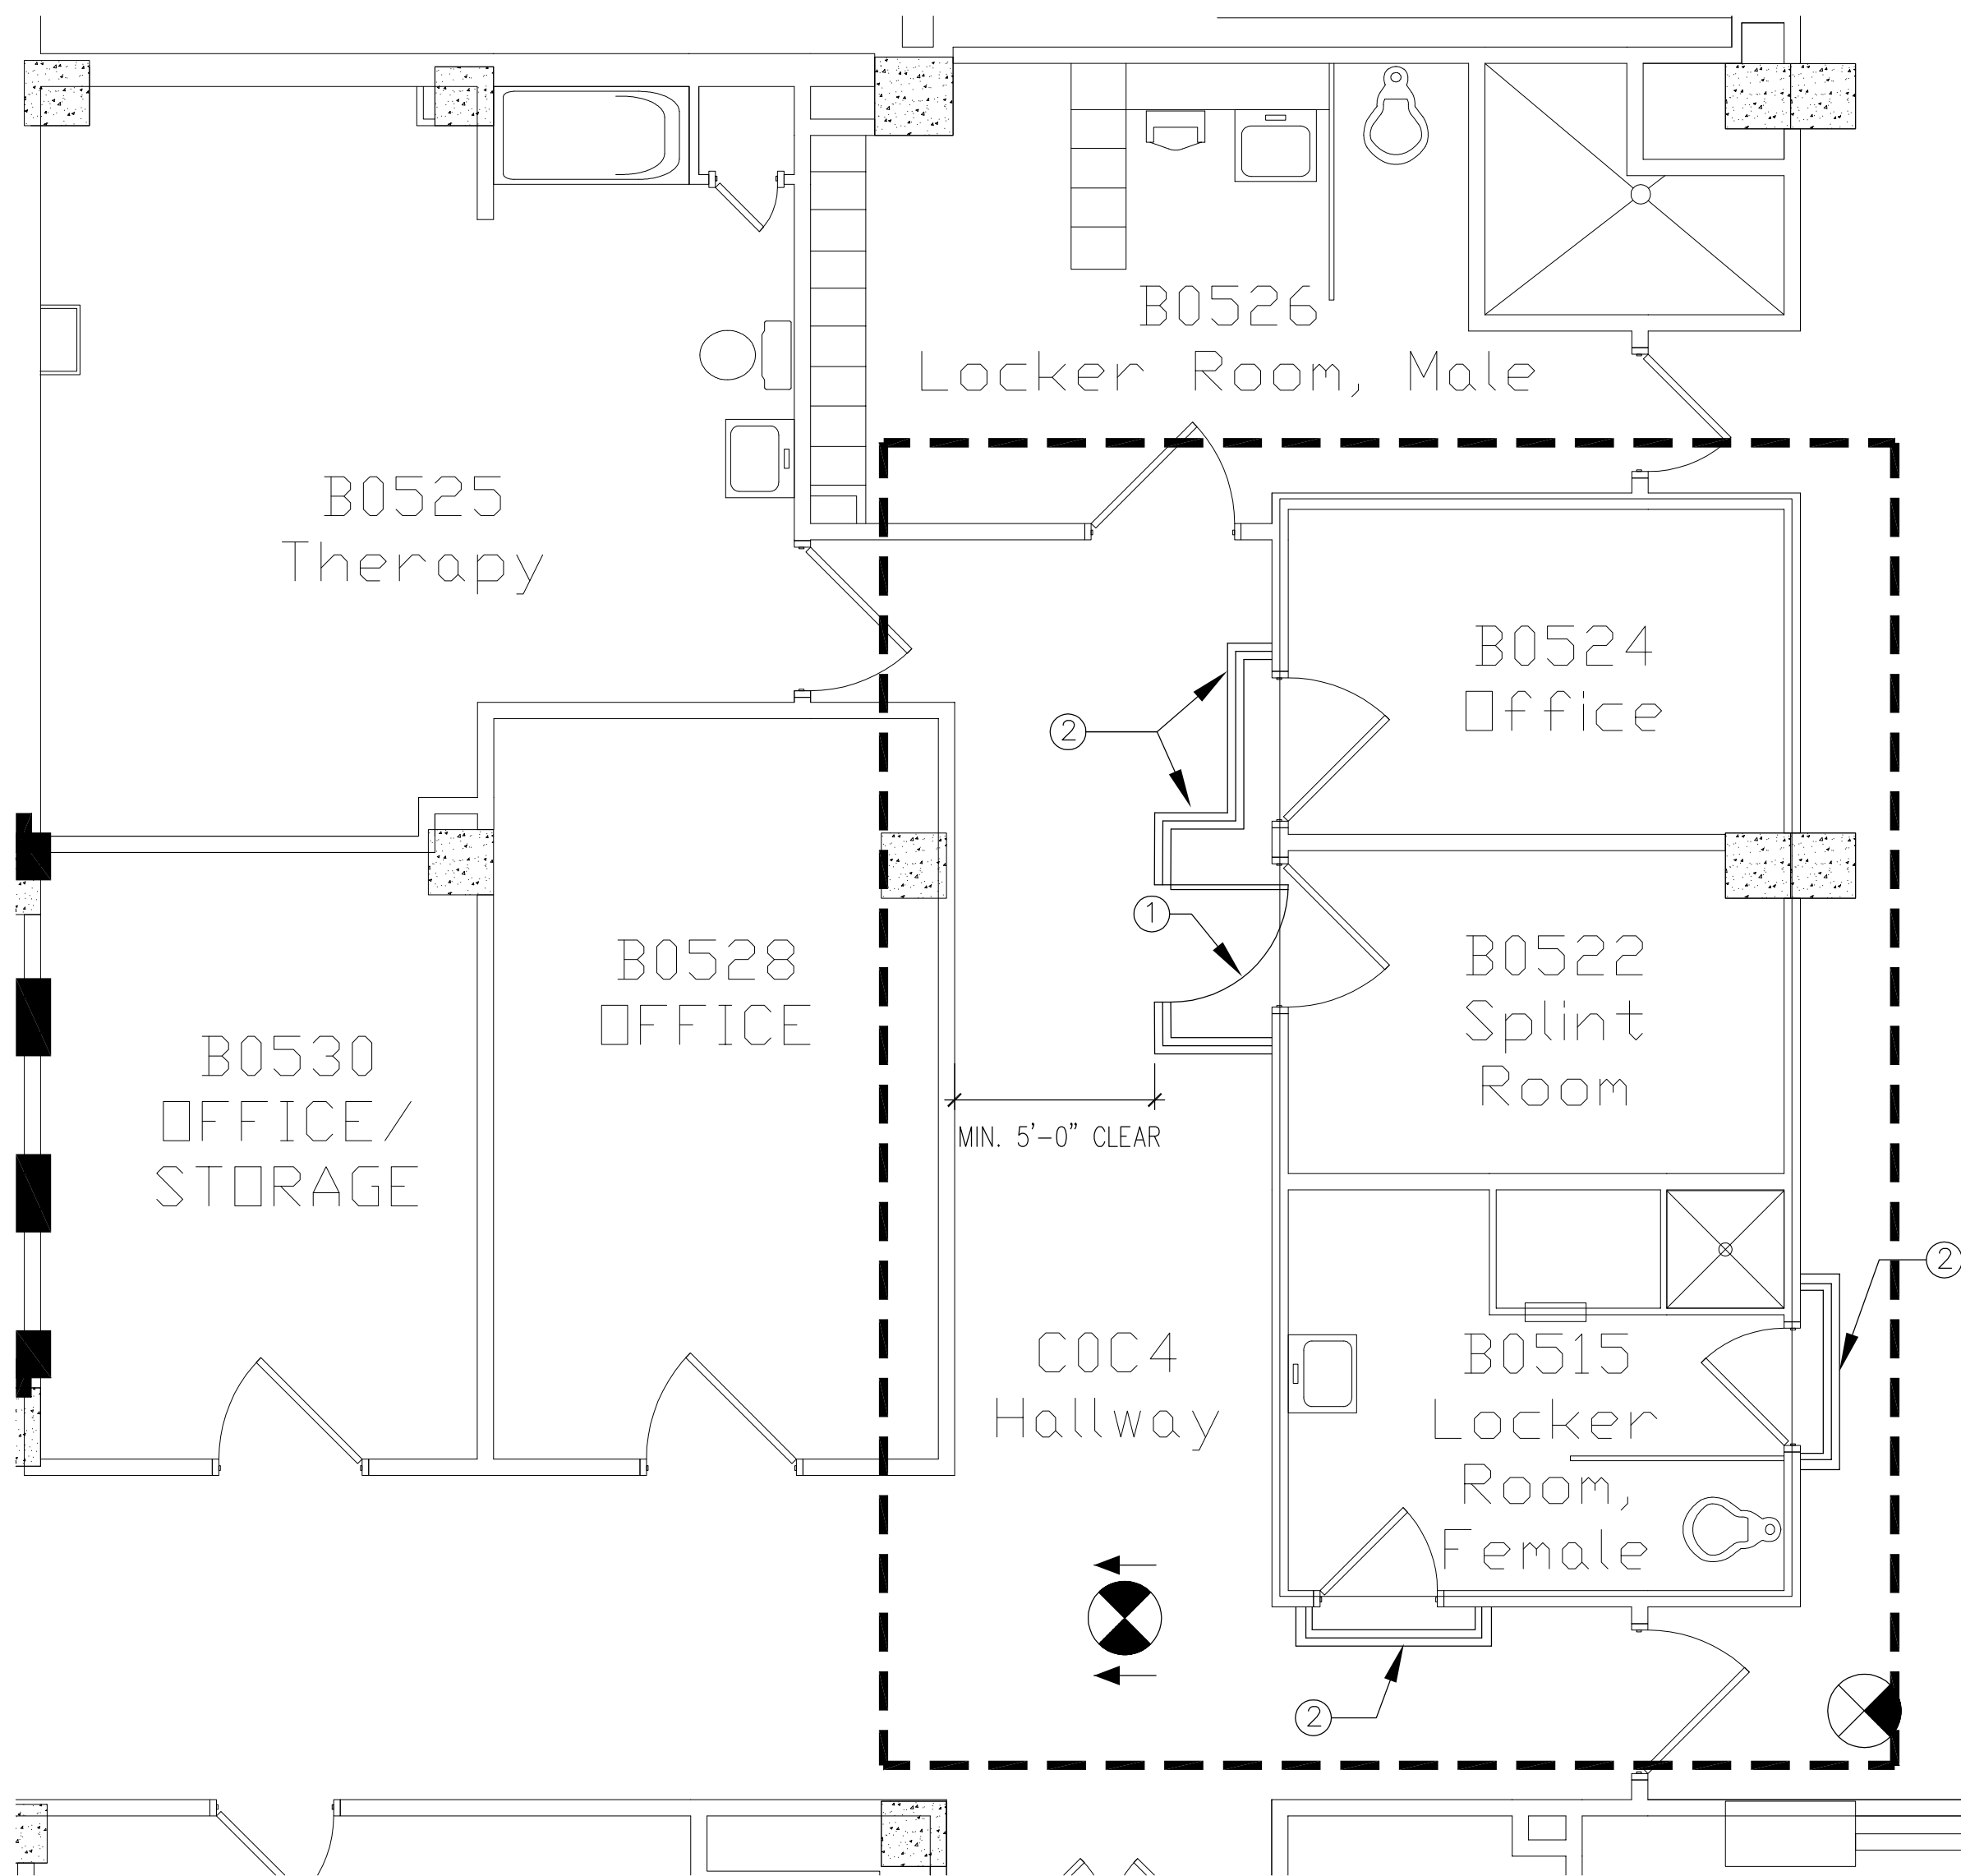

2 PHASE 2 - WOMANS LOCKER ROOM WITH INFECTION CONTROL / CONSTRUCTION BARRIER
G-002 1/4" = 1'-0"

GRAPHIC LEGEND

ONE HOUR FIRE RESISTIVE CONSTRUCTION


PHASING PLAN GENERAL NOTES

- A. CONTRACTOR IS RESPONSIBLE FOR COORDINATION AND SEQUENCING OF CONSTRUCTION PHASING WITH THE VA'S SCHEDULE, INFECTION CONTROL, AND INTERM LIFE SAFETY REQUIREMENTS.
- B. PROVIDE SUB-PHASING AS NEEDED TO COMPLETE WORK BETWEEN PHASES. REFER TO SECTION 010000 ITEM 1.6G FOR OTHER GENERAL PHASING REQUIREMENTS.
- C. PROVIDE A MINIMUM OF A 1 HOUR RATED WALL SEPARATION BETWEEN OCCUPIED SPACES AND CONSTRUCTION AREA AT ALL PHASES. EXISTING WALLS BEING USED AS PART OF THE CONSTRUCTION SEPARATION SHALL BE UPGRADED TO COMPLY WITH A 1 HOUR UL DESIGN FIRE RATED WALL.
- D. SEE DETAILS ON SHEET G-001 FOR CONSTRUCTION BARRIER WALL DETAILS.
- E. MAINTAIN EGRESS TO ALL STAIRWELLS AT ALL TIMES.
- F. MAINTAIN PUBLIC ACCESS TO ELEVATORS AT ALL TIMES.
- G. SEE DOOR SCHEDULE FOR TYPICAL TEMPORARY CONSTRUCTION DOORS. CONTRACTOR TO SALVAGE AND RETURN THESE DOORS TO THE VA AFTER PROJECT COMPLETION AS DIRECTED BY THE VA.
- H. SEE SHEET 2/G-001 FOR INFECTION CONTROL BARRIER (IFC) DETAIL AND IFC GENERAL NOTES.
- I. PORTION OF CORRIDOR MAY BE USED AS PART INFECTION CONTROL AREA. HOWEVER, A MINIMUM OF 5FT MUST BE MAINTAINED OPEN FOR MOVEMENT OF VA PERSONNEL. CORRIDORS SHALL NOT BE CLOSED OFF.
- J. CONTRACTOR IS TO FIRESTOP AND SEAL ALL FLOOR AND WALL PENETRATIONS AT THE END OF EACH WORK SHIFT. IF FIRE STOPPING CANNOT BE PERFORMED AT THE END OF EACH WORK SHIFT, THE HOLE NEEDS TO BE PACKED WITH MINERAL WOOL INSULATION AND TAGGED WITH AN ORANGE ILSM TAG INDICATING: PROJECT NAME, PRIME CONTRACTOR NAME AND PHONE NUMBER, CONTRACTOR PERFORMING CORING, DATE HOLE IS MADE, AND DATE HOLE WILL BE FIRE STOPPED (MAXIMUM OF 30 DAYS).
- K. ADJUST PERIMETER OF PHASE AREA AS REQUIRED TO INCLUDE ANY REQUIRED M.E.P. & F.P. WORK AND DEMOLITION.
- L. CONTRACTOR TO CONSTRUCT ALL REQUIRED CONSTRUCTION & INFECTION CONTROL BARRIERS PRIOR TO WORK IN PHASED AREAS.
- M. ALL CONSTRUCTION OF CONSTRUCTION & INFECTION CONTROL BARRIERS TO BE CONSTRUCTED OFF HOURS WITH PRIOR APPROVAL FROM VA.


KEY NOTES

- 1 1 HR RATED CONSTRUCTION BARRIER DOOR WITH KEY CARD ACCESS READER
- 2 INFECTION CONTROL / CONSTRUCTION BARRIER WALL. SEE SHEET G-001/2 FOR DETAIL OF INFECTION CONTROL/CONSTRUCTION BARRIER DETAIL.

KEY PLAN

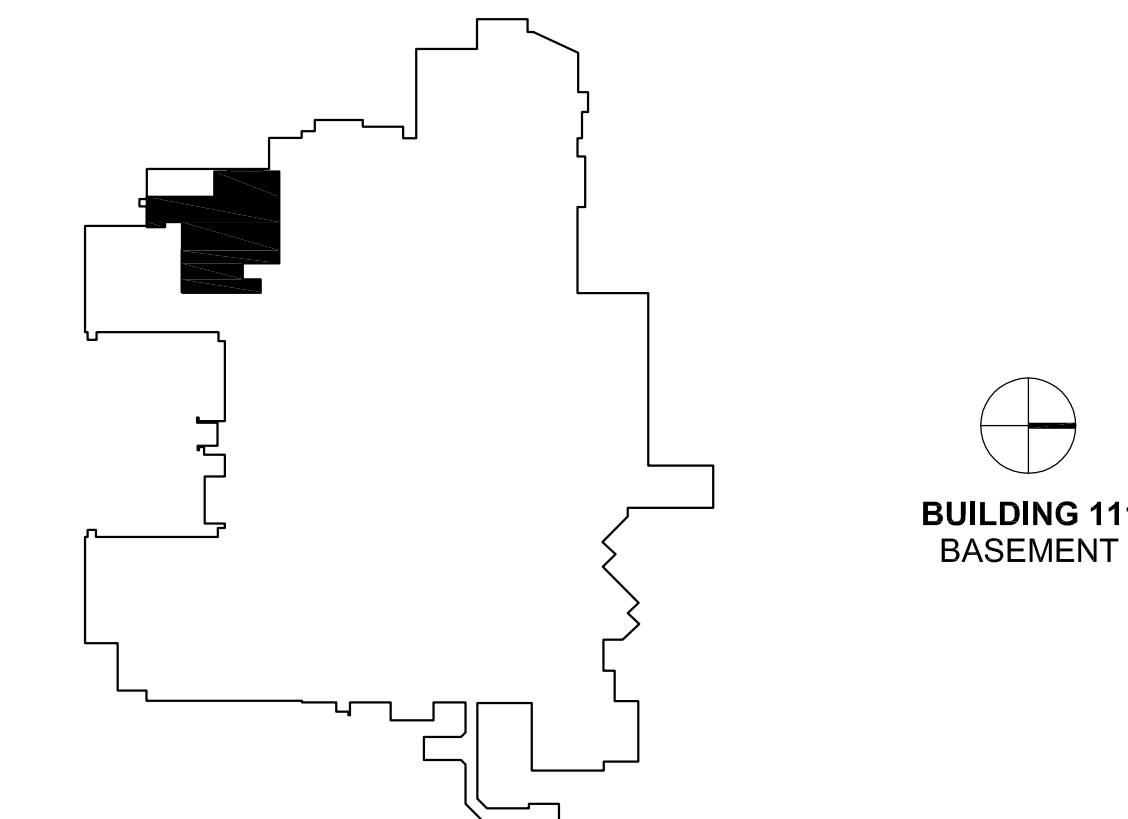

BUILDING 111
BASEMENT

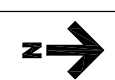

ARCHITECT:
CLEMENT J. ZABLOCKI VA MEDICAL CENTER
OFFICE OF CONSTRUCTION AND FACILITIES MANAGEMENT

Drawing Title
PHASING AND INFECTION CONTROL
CONSTRUCTION BARRIER PLANS
Approved: Project Director
Troy Martinson, PE

Project Title
111 Upgrade Pool Locker
Rooms
Location
VA Medical Center, Milwaukee, WI
Date
August 28, 2015
Checked
Drawn
AJ

Project Number
695-14-114
Building Number
Building 111
Drawing Number
G-002

Office of
Construction
and Facilities
Management
Department of
Veterans Affairs

GYPSUM BOARD PARTITION SCHEDULE

3" SOUND CONTROL BATT INSULATION (EXCEPT AS NOTED BELOW) AT ACOUSTIC RATED PARTITIONS
ONE LAYER 5/8" GYPSUM BOARD - EACH SIDE
20 GAUGE METAL STUDS @ 1'-4" OC


| PARTITION TYPE | STUD WIDTH | PARTITION WIDTH | 1HR CONSTRUCTION TESTS | W/O INS | W/INS | NOTES | NOMINAL DIMENSION |
|----------------|------------|-----------------|-------------------------------------|---------|-------|--|--------------------|
| A5 | 3 5/8" | 4 7/8" | GA FILE NO WP1200 UL DES NO U465 | 40-44 | 49 | STORAGE AREAS NO INSULATION, ALL OTHER 3 5/8" GLASS FIBER BATT INS | 5' |
| A6 | 6" | 7 1/4" | GA FILE NO WP1200 UL DES NO U465 | 40-44 | 49 | | VARIES - SEE A-101 |

7 WALL TYPES
N.T.S.



Identification signs for Normal Power System equipment shall be laminated black phenolic resin with a white core with engraved lettering. Identification signs for Essential Electrical System (EES) equipment, as defined in the NEC, shall be laminated red phenolic resin with a white core with engraved lettering. Lettering shall be a minimum of 12 mm (1/2 inch) high. Identification signs shall indicate equipment designation, rated bus amperage, voltage, number of phases, number of wires, and type of EES power branch as applicable. Secure nameplates with screws.

6 ELECTRICAL OUTLET LABELING
N.T.S.

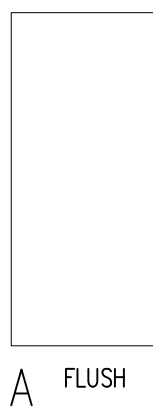


5 DOOR TYPES/NOTES
N.T.S.

- GENERAL DOOR NOTES
- Door number is identical to number of room in which door occurs.
 - In cases of multiple doors in one room, suffixes are added to door number.
 - All doors are 1-3/4" thick, unless noted otherwise.

1 NOT USED
N/A

2 TYPICAL MAGNETIC SIGNAGE
1/8" = 1'-0"


- Contractor to provide Signage, VA will be responsible to relocate magnetic signs based on program schedule

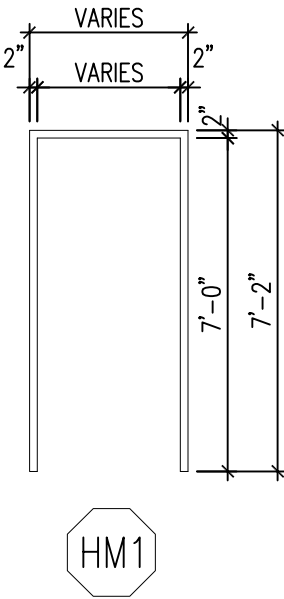

3 STEEL FRAME ELEVATION
N.T.S.


| DOOR SCHEDULE | | | | | | | | | | | | | |
|--|----------|----------------------|------------------|------|------|--------|-------|------|--------|------------|-------------|------------------------|--|
| Project Title: 111 Upgrade Pool Locker Rooms | | | | | | | | | | | | | |
| DOOR NO. | ROOM NO. | ROOM NAME | Size (W x H) | Type | Matl | Finish | Glass | Matl | Finish | Howe Group | Assy Rating | Project No. 695-14-114 | |
| B0528A | B0528 | MENS LOCKER ROOM | 3'-6" x 7'-0" | A | MTL | PA-2 | -- | HM1 | PA-2 | 1 | 45 MN | - | |
| B0528B | B0528 | MENS LOCKER ROOM | 3'-6" x 7'-0" | A | MTL | PA-2 | -- | HM1 | PA-2 | 4 | 45 MN | 5 | |
| B0515A | B0515 | WOMENS LOCKER ROOM | 3'-6" x 7'-0" | A | MTL | PA-2 | -- | HM1 | PA-2 | 1 | 45 MN | - | |
| B0515B | B0515 | WOMENS LOCKER ROOM | 3'-6" x 7'-0" | A | MTL | PA-2 | -- | HM1 | PA-2 | 4 | 45 MN | 5 | |
| B0520 | B0520 | POOL | MEASURE EXISTING | A | MTL | PA-2 | -- | HM1 | PA-2 | 2 | 45 MN | - | |
| IFCIB-1 | IFCIB-1 | TEMPORARY IFCIB DOOR | 3'-0" x 7'-0" | A | MTL | -- | -- | HM1 | -- | | 45 MN | 1,2,3 | |
| IFCIB-2 | IFCIB-2 | TEMPORARY IFCIB DOOR | 3'-0" x 7'-0" | A | MTL | -- | -- | HM1 | -- | | 45 MN | 1,2,3 | |
| NOTES: ALL DOORS TO BE ROTARY OUT BIRCH WITH CLEAR STAIN TO MATCH EXISTING UNLESS NOTED OTHERWISE | | | | | | | | | | | | | |
| ALL HARDWARE PREP DONE PRIOR TO PREFINISHING | | | | | | | | | | | | | |
| 1 ACROVYN 45 MIN RATED RED DOOR. | | | | | | | | | | | | | |
| 2 DOOR TO BE REUSED FOR EACH PHASE | | | | | | | | | | | | | |
| 3 PROVIDE TEMPORARY CARD READER FOR IFCIB DOOR. | | | | | | | | | | | | | |
| 4 EXISTING HARDWARE TO REMAIN, CONTRACTOR TO PAINT DOOR AND FRAME ON BOTH SIDES | | | | | | | | | | | | | |
| 5 CONTRACTOR TO PROVIDE AND MOUNT A PERMANENT 12"x18" PHOTO LUMINESCENT POOL - NOT AN EXIT SIGNAGE ON THE LOCKER ROOM SIDE OF THE DOOR | | | | | | | | | | | | | |

| HARDWARE GROUP SCHEDULE | | | | | | | | | | | | | |
|---|------------------------------------|------------------------|--|--|--|--|--|--|--|-------|----|--|--|
| Group 1 | | | | | | | | | | | | | |
| Doors: | B0528A, B0515A | | | | | | | | | | | | |
| 3 | Hinge | BB1168 4-1/2" x 4-1/2" | | | | | | | | US28D | HA | | |
| 1 | Classroom Lock | 45H7R15J626 | | | | | | | | 626AM | BE | | |
| 1 | Wall Stop | 406 | | | | | | | | US32D | RO | | |
| 1 | Armoplate | 8400 Series 35" x 40" | | | | | | | | US32D | IV | | |
| 1 | 1E Series Mortise Cylinder | 406 | | | | | | | | 626AM | BE | | |
| 1 | Universal Strike Package | | | | | | | | | 626AM | BE | | |
| 1 | Super HD Automatic Door Operator | 1301 | | | | | | | | US32D | TO | | |
| 2 | Wall Mounted Actuator | 8310-866T | | | | | | | | US32D | LC | | |
| 2 | Flush Mount Box | 8310-868F | | | | | | | | US32D | LC | | |
| 2 | Superscan | 10SS142 | | | | | | | | N/A | BA | | |
| Group 2 | | | | | | | | | | | | | |
| Doors: | B0520 | | | | | | | | | | | | |
| 3 | Hinge | BB1168 4-1/2" x 4-1/2" | | | | | | | | US28D | HA | | |
| 1 | Storeroom Lock | 45H7D15J626 | | | | | | | | 626AM | BE | | |
| 1 | Wall Stop | 406 | | | | | | | | US32D | RO | | |
| 1 | Armoplate | 8400 Series 35" x 40" | | | | | | | | US32D | IV | | |
| 1 | 1E Series Mortise Cylinder | 406 | | | | | | | | 626AM | BE | | |
| 1 | Universal Strike Package | | | | | | | | | 626AM | BE | | |
| 1 | Super HD Automatic Door Operator | 1301 | | | | | | | | US32D | TO | | |
| 2 | Wall Mounted Actuator | 8310-866T | | | | | | | | US32D | LC | | |
| 1 | Surface Mount Box - Pool Side | 8310-868S | | | | | | | | US32D | LC | | |
| 1 | Flush Mount Box - Locker Room Side | 8310-868F | | | | | | | | US32D | LC | | |
| 1 | Weather Ring - Pool Side | 8310-800 | | | | | | | | N/A | LC | | |
| 2 | Transmitter | 8310-844 | | | | | | | | US32D | LC | | |
| 1 | Receiver | 8310-865 | | | | | | | | US32D | LC | | |
| 2 | Superscan | 10SS142 | | | | | | | | N/A | BA | | |
| Group 3 | | | | | | | | | | | | | |
| Doors: | NOT USED | | | | | | | | | | | | |
| Group 4 | | | | | | | | | | | | | |
| Doors: | B0528B, B0515B | | | | | | | | | | | | |
| 3 | Hinge | BB1168 4-1/2" x 4-1/2" | | | | | | | | US28D | HA | | |
| 1 | Communicating Lock | 45H7S15J626 | | | | | | | | 626AM | BE | | |
| 1 | Wall Stop | 406 | | | | | | | | US32D | RO | | |
| 1 | Armoplate | 8400 Series 35" x 40" | | | | | | | | US32D | IV | | |
| 1 | 1E Series Mortise Cylinder | 406 | | | | | | | | 626AM | BE | | |
| 1 | Universal Strike Package | | | | | | | | | 626AM | BE | | |
| 1 | Super HD Automatic Door Operator | 1301 | | | | | | | | US32D | TO | | |
| 2 | Wall Mounted Actuator | 8310-866T | | | | | | | | US32D | LC | | |
| 1 | Surface Mount Box - Pool Side | 8310-868S | | | | | | | | US32D | LC | | |
| 1 | Flush Mount Box - Locker Room Side | 8310-868F | | | | | | | | US32D | LC | | |
| 1 | Weather Ring - Pool Side | 8310-800 | | | | | | | | N/A | LC | | |
| 2 | Transmitter | 8310-844 | | | | | | | | US32D | LC | | |
| 1 | Receiver | 8310-865 | | | | | | | | US32D | LC | | |
| 2 | Superscan | 10SS142 | | | | | | | | N/A | BA | | |
| 1. HA - Hager 2. HS - HES 3. RO - Rockwood 4. BE - Stanley Security Solutions Inc (BE) | | | | | | | | | | | | | |
| 5. VD - Von Duprin 6. HD - HID 7. LC - LCN Closers 8. SC - Schlage | | | | | | | | | | | | | |
| 9. JC - JCI 10. TO - Tomrax 11. BA - BEA | | | | | | | | | | | | | |

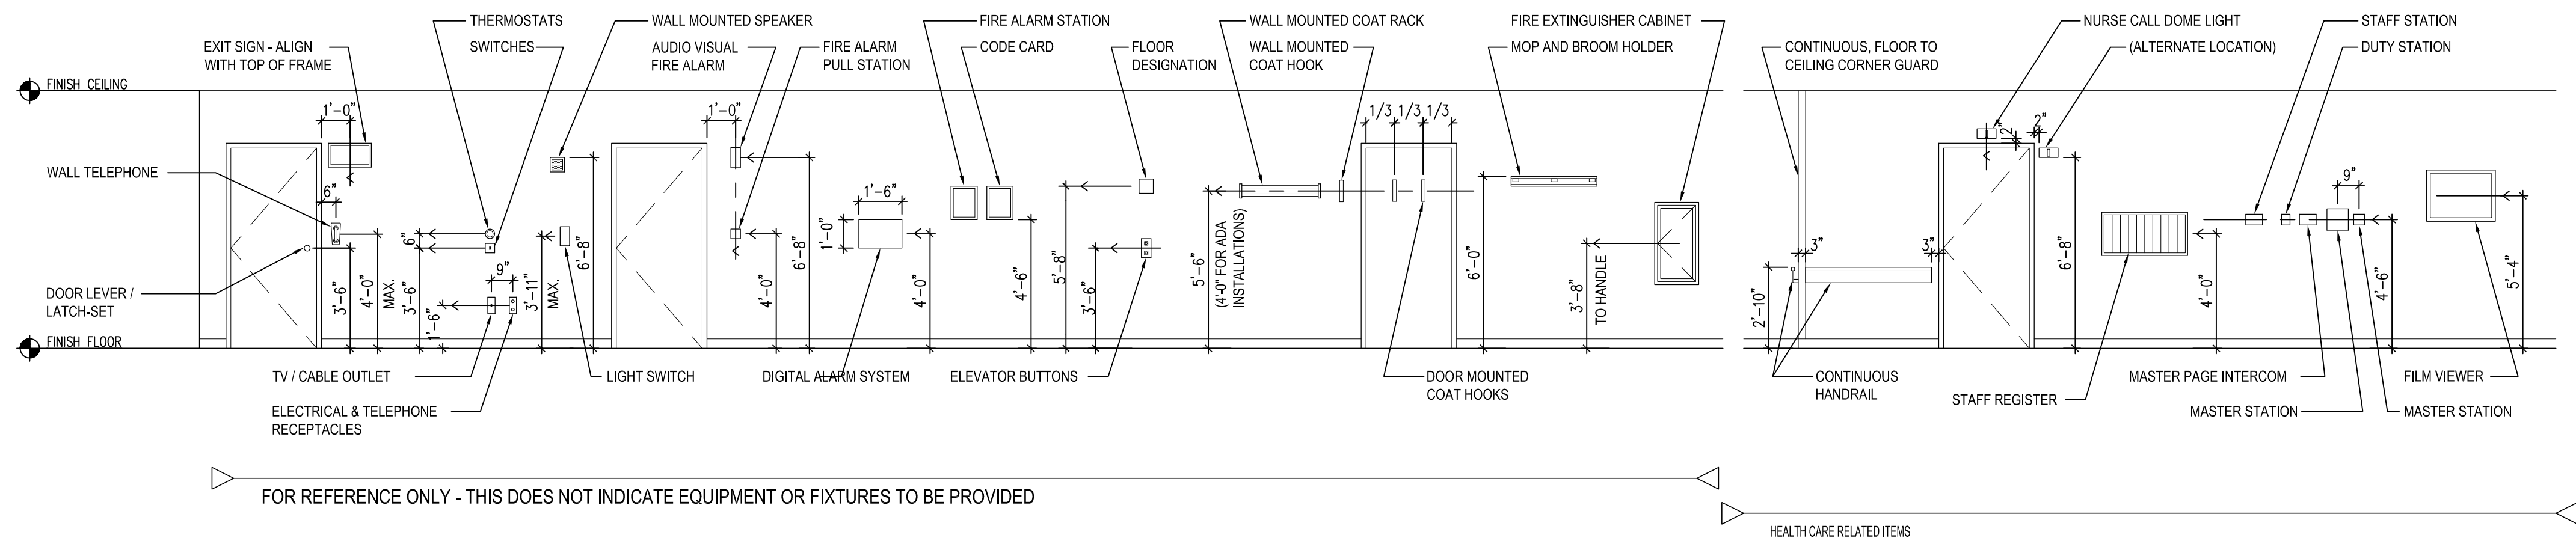


4 TYPICAL MOUNTING HEIGHTS
N.T.S.


KEY PLAN

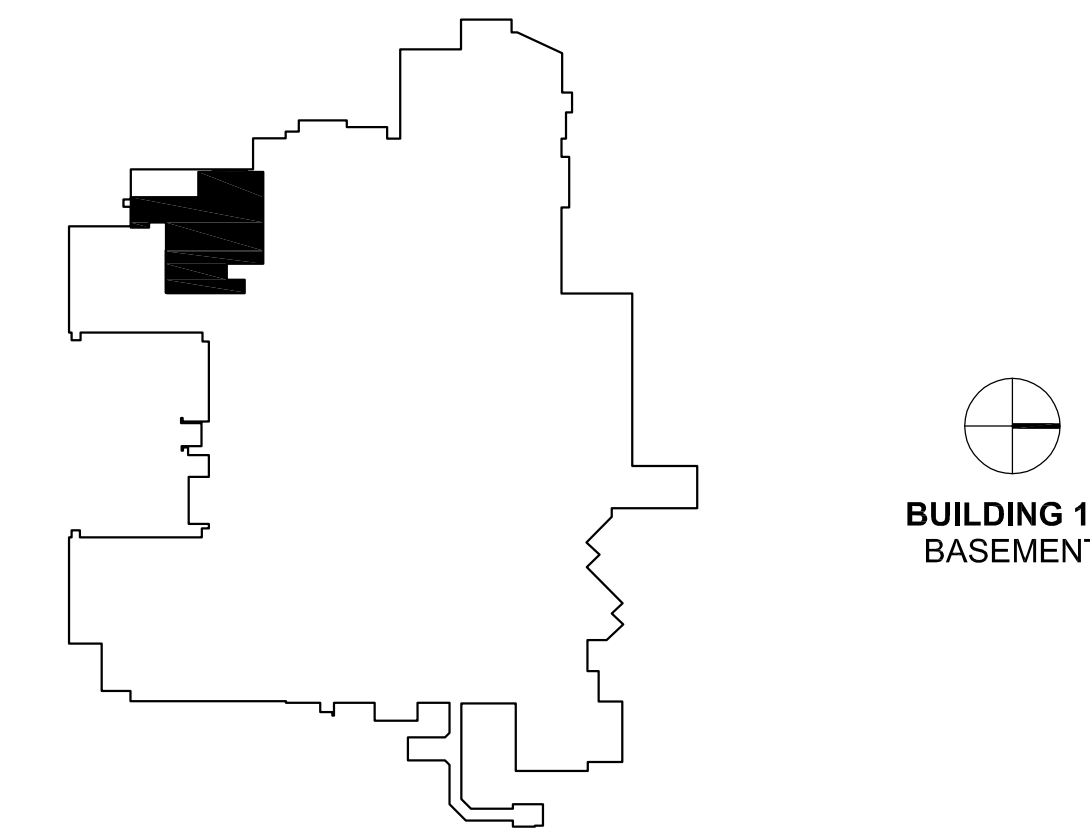


| | | | | | | | | |
|-----------|------|---|---|---|---|------------------------------|---------------------------------|---|
| Revisions | Date | Dept. of Veterans Affairs Medical Center 5000 W. National Avenue Milwaukee, WI | ARCHITECT: CLEMENT J. ZABLOCKI VA MEDICAL CENTER OFFICE OF CONSTRUCTION AND FACILITIES MANAGEMENT | Drawing Title SCHEDULES AND GENERAL DETAILS | Project Title 111 Upgrade Pool Locker Rooms | Project Number 695-14-114 | Building Number Building 111 | Office of Construction and Facilities Management |
| | | | | Approved: Project Director Troy Martinson, PE | Location VA Medical Center, Milwaukee, WI | Checked August 28, 2015 | Drawn AJ | Department of Veterans Affairs |

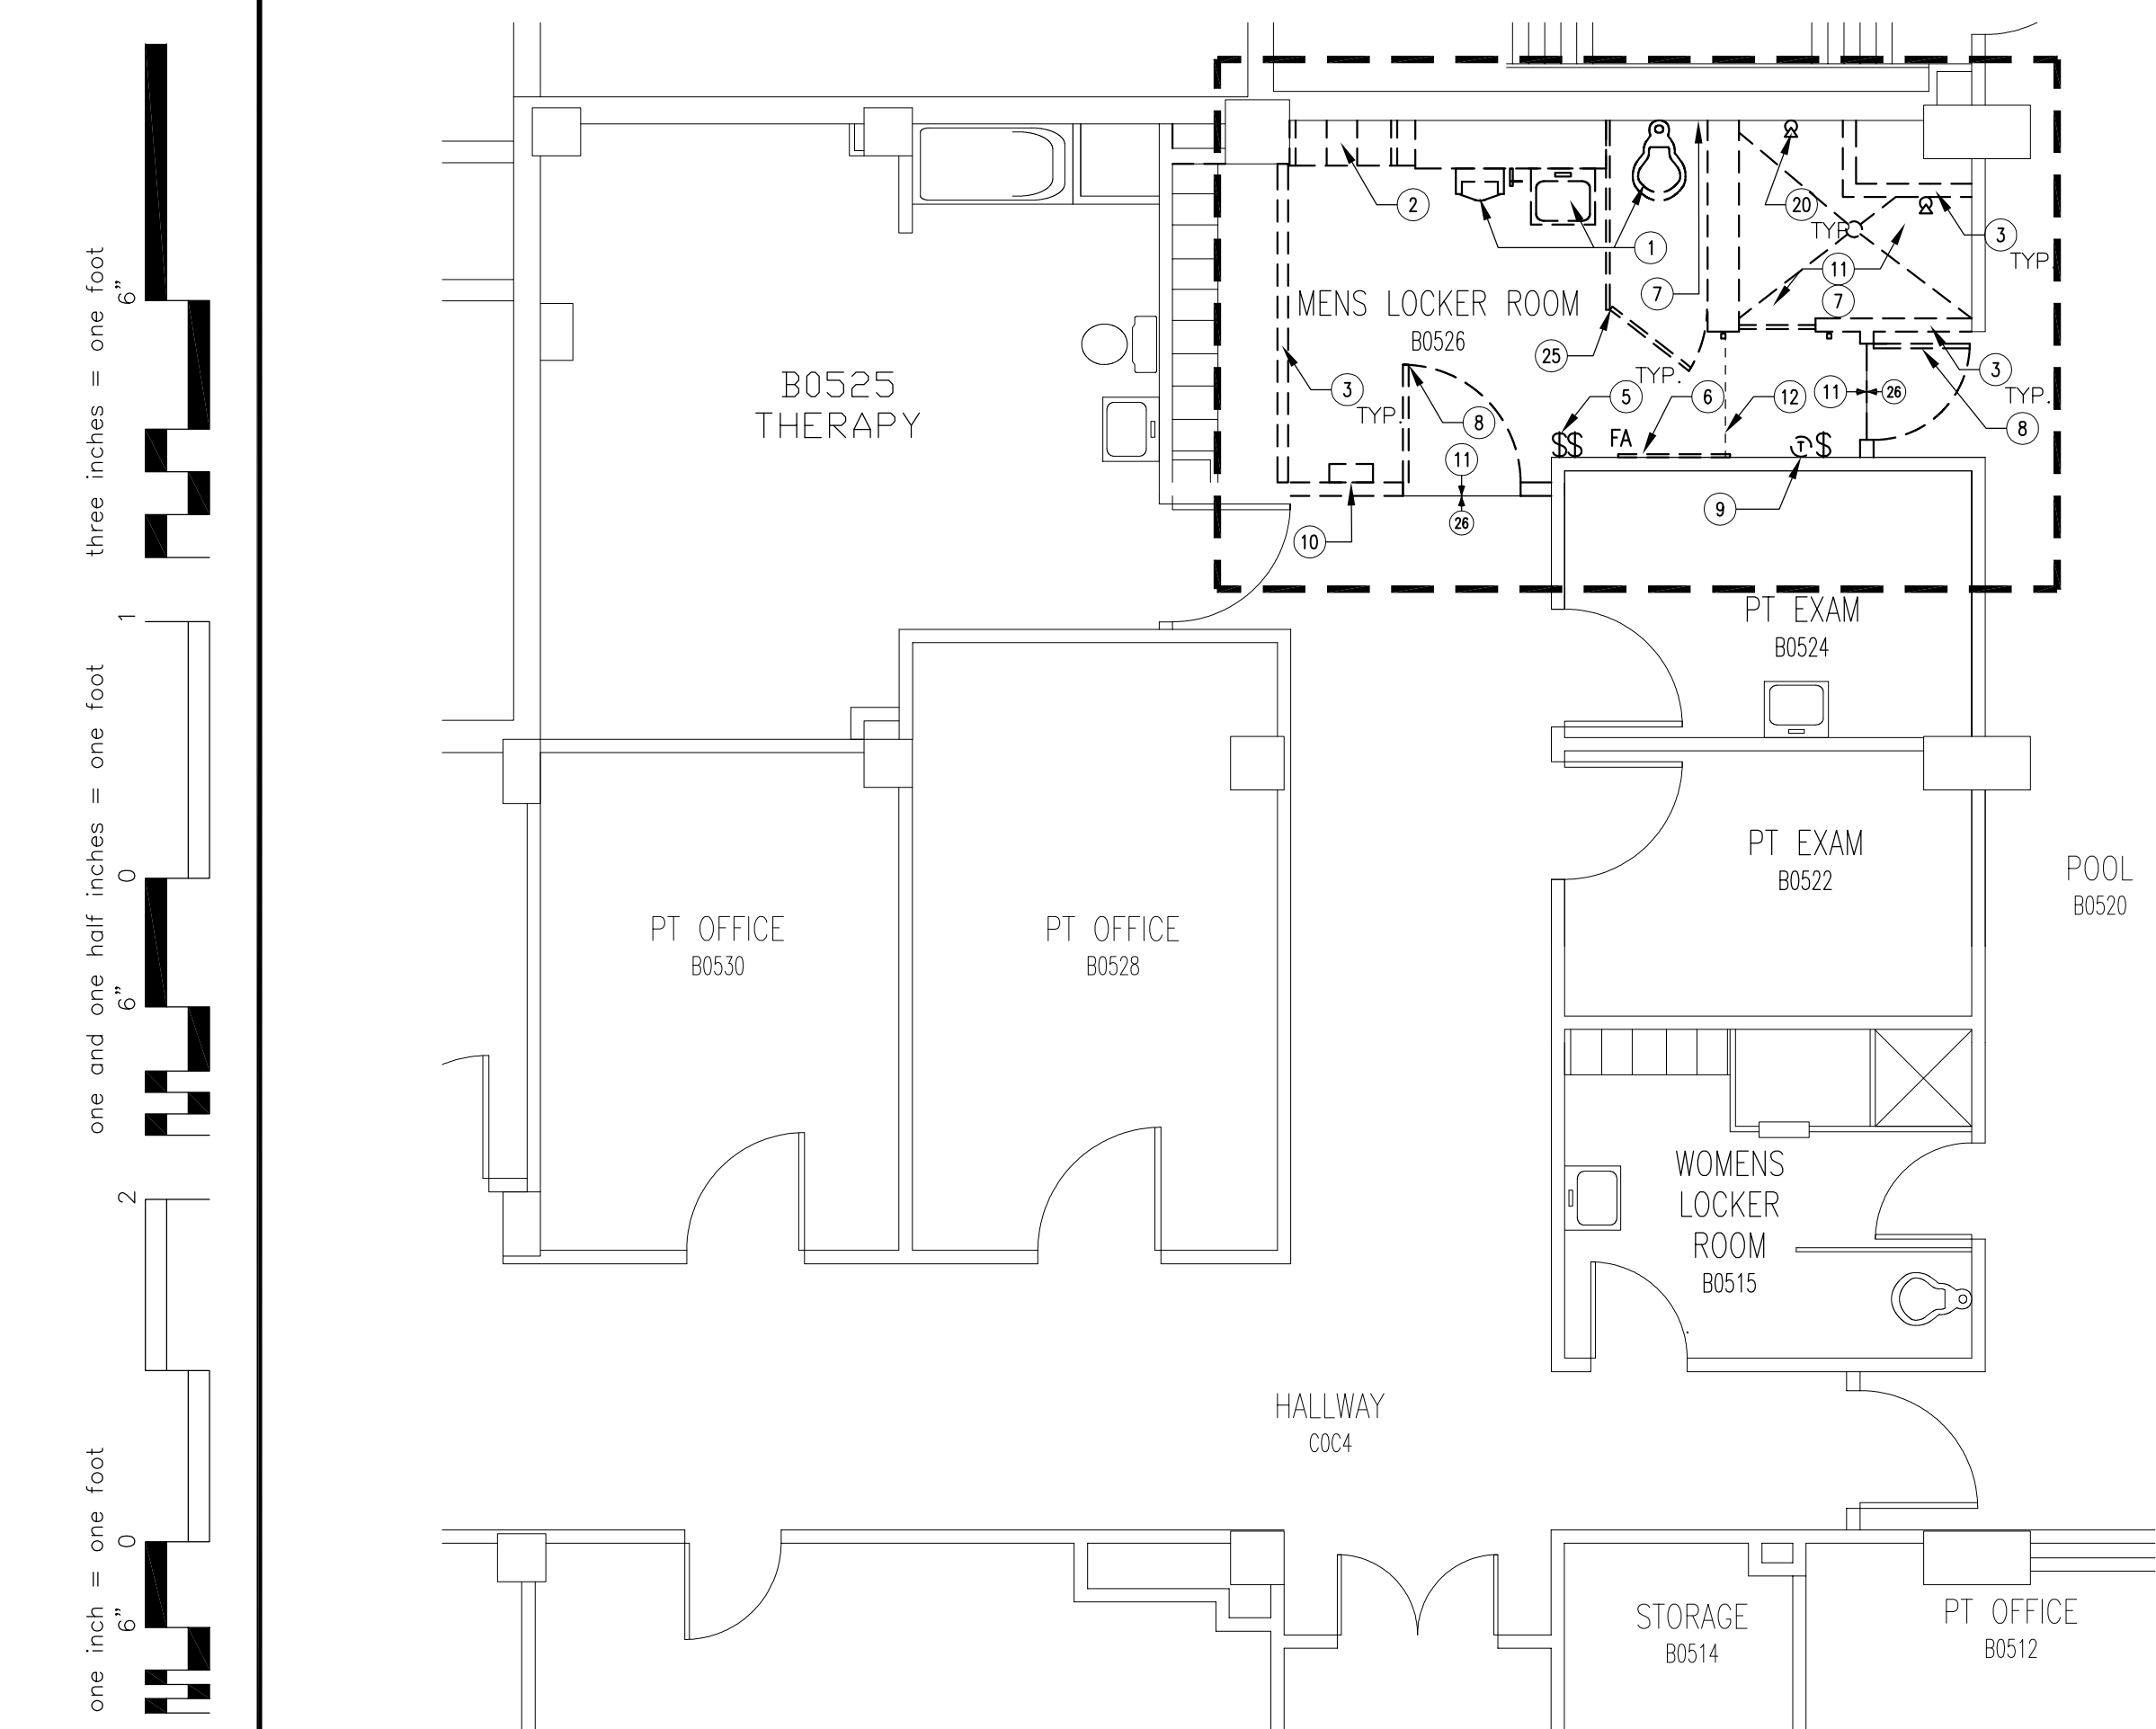

3 DEMOLITION PLAN - PHASE 3
3/16" = 1'-0"

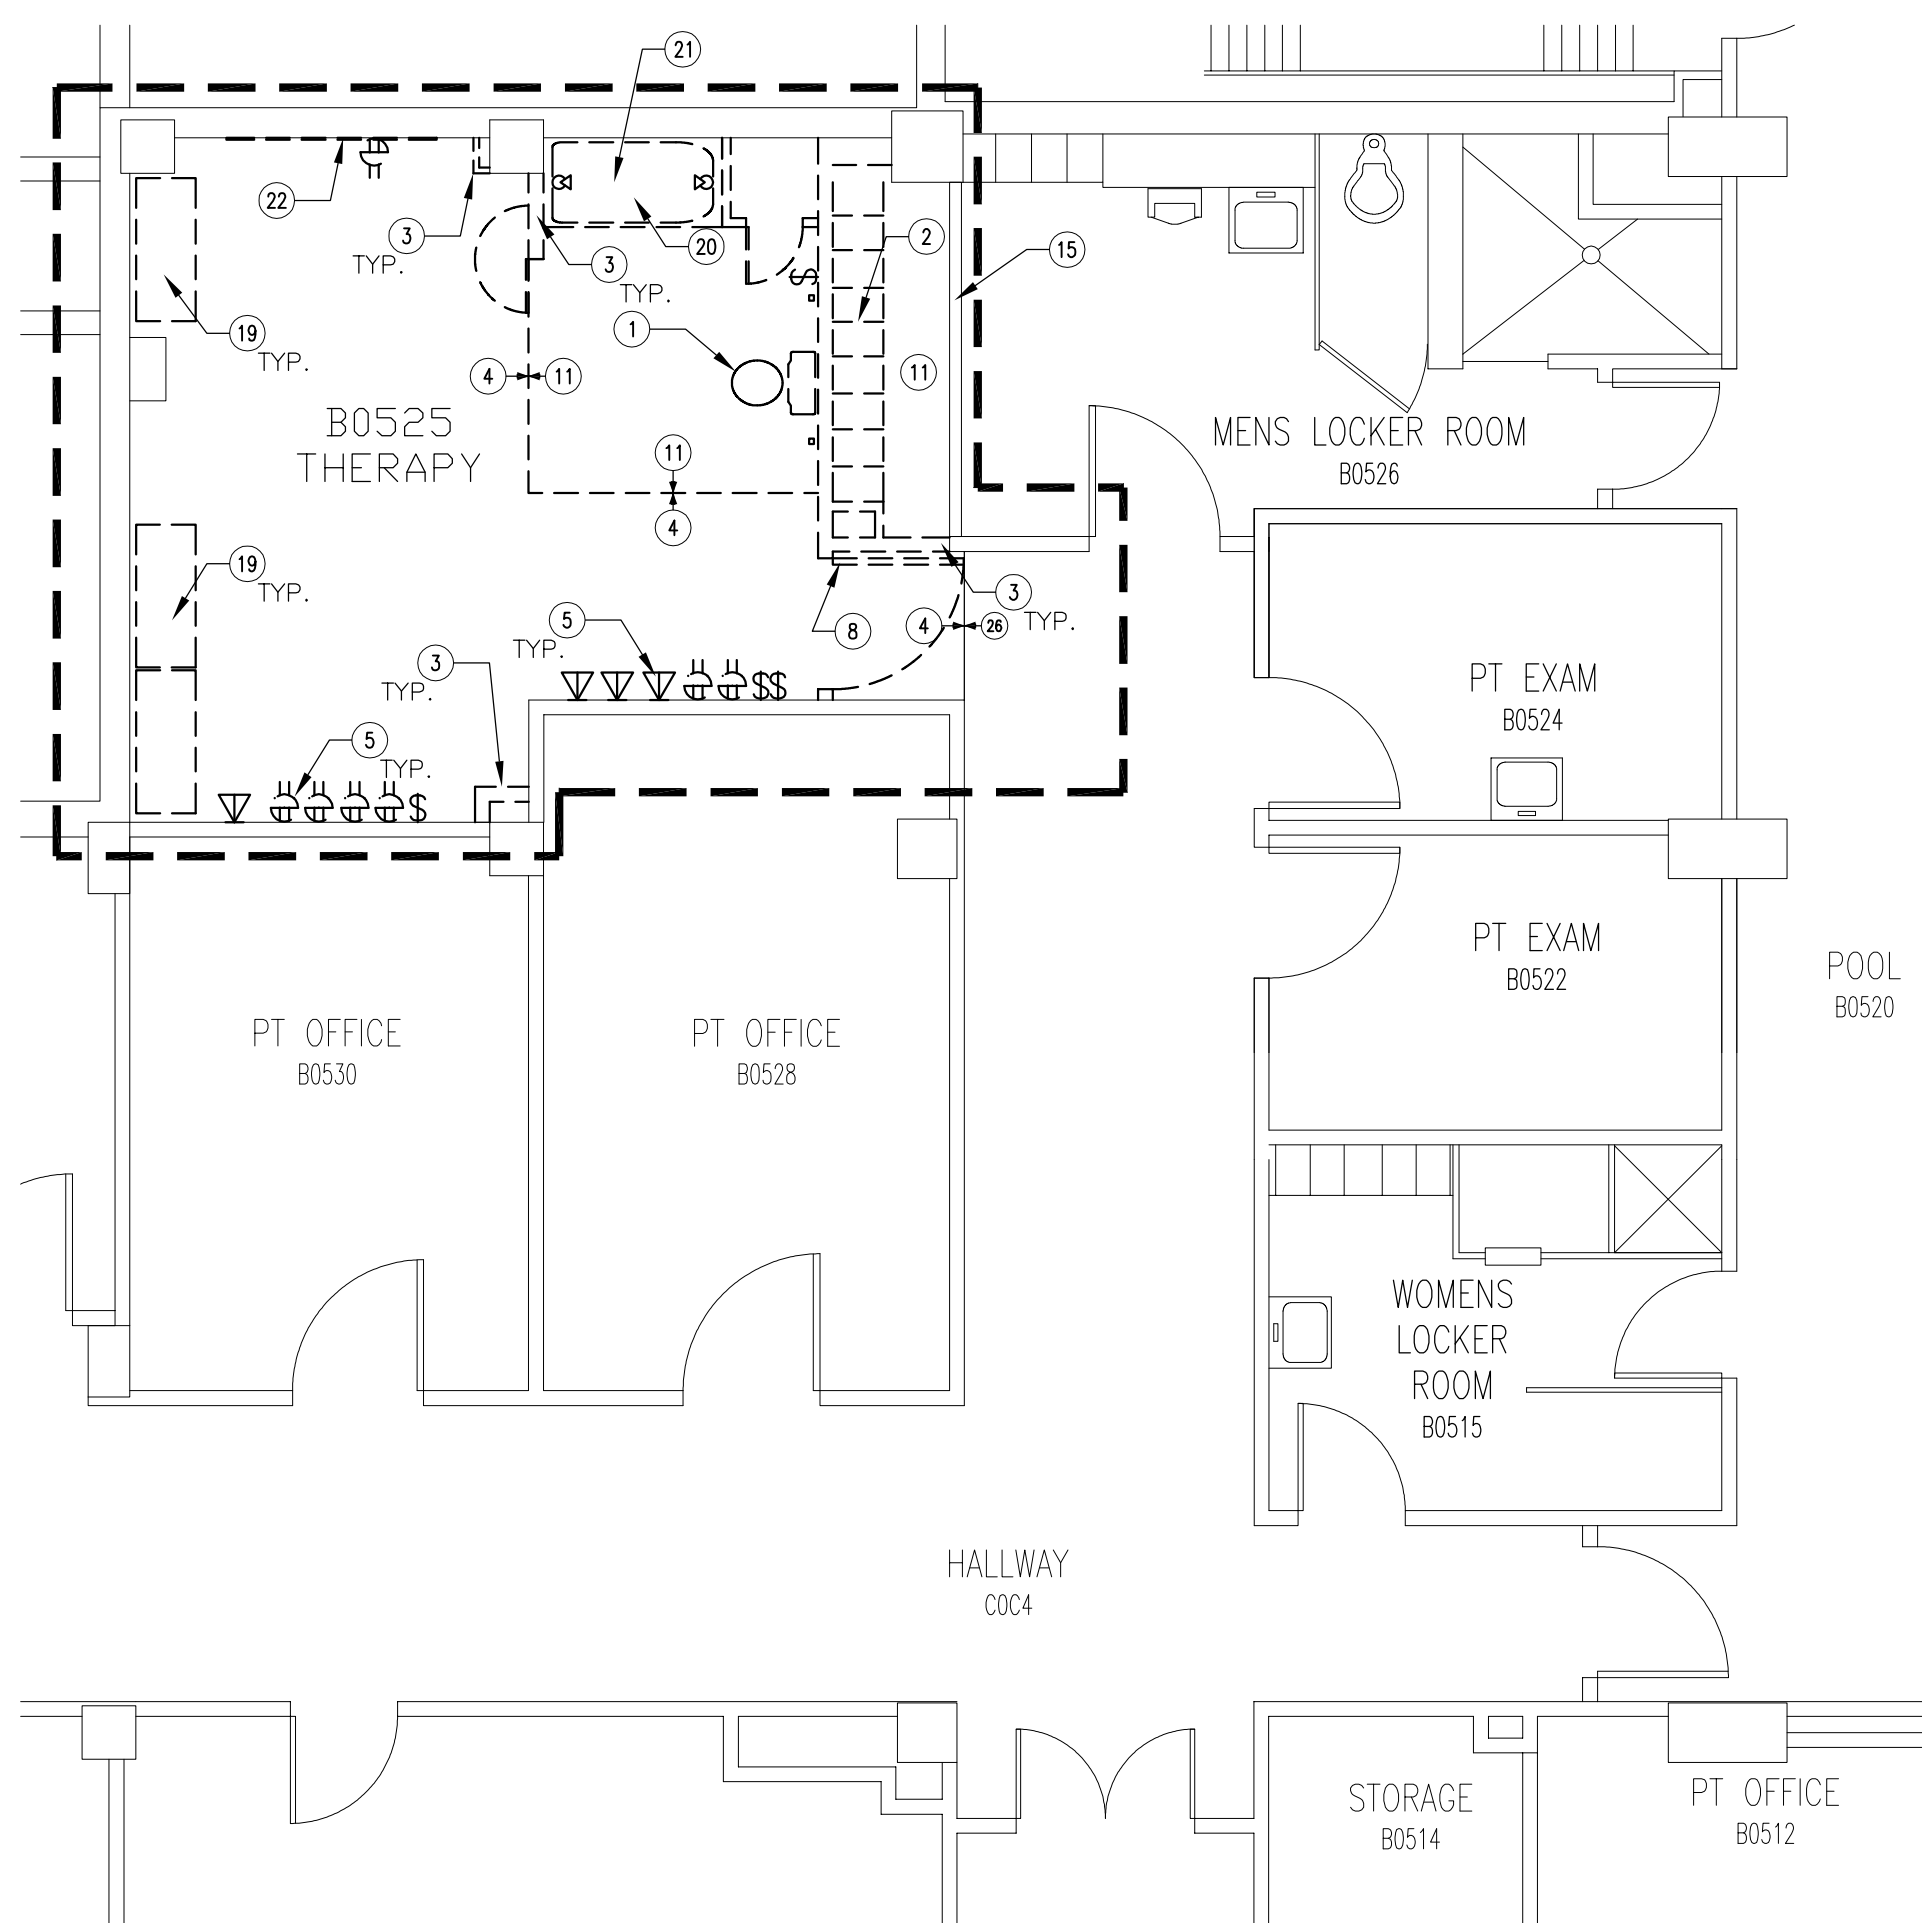

1 DEMOLITION PLAN - PHASE 1
3/16" = 1'-0"

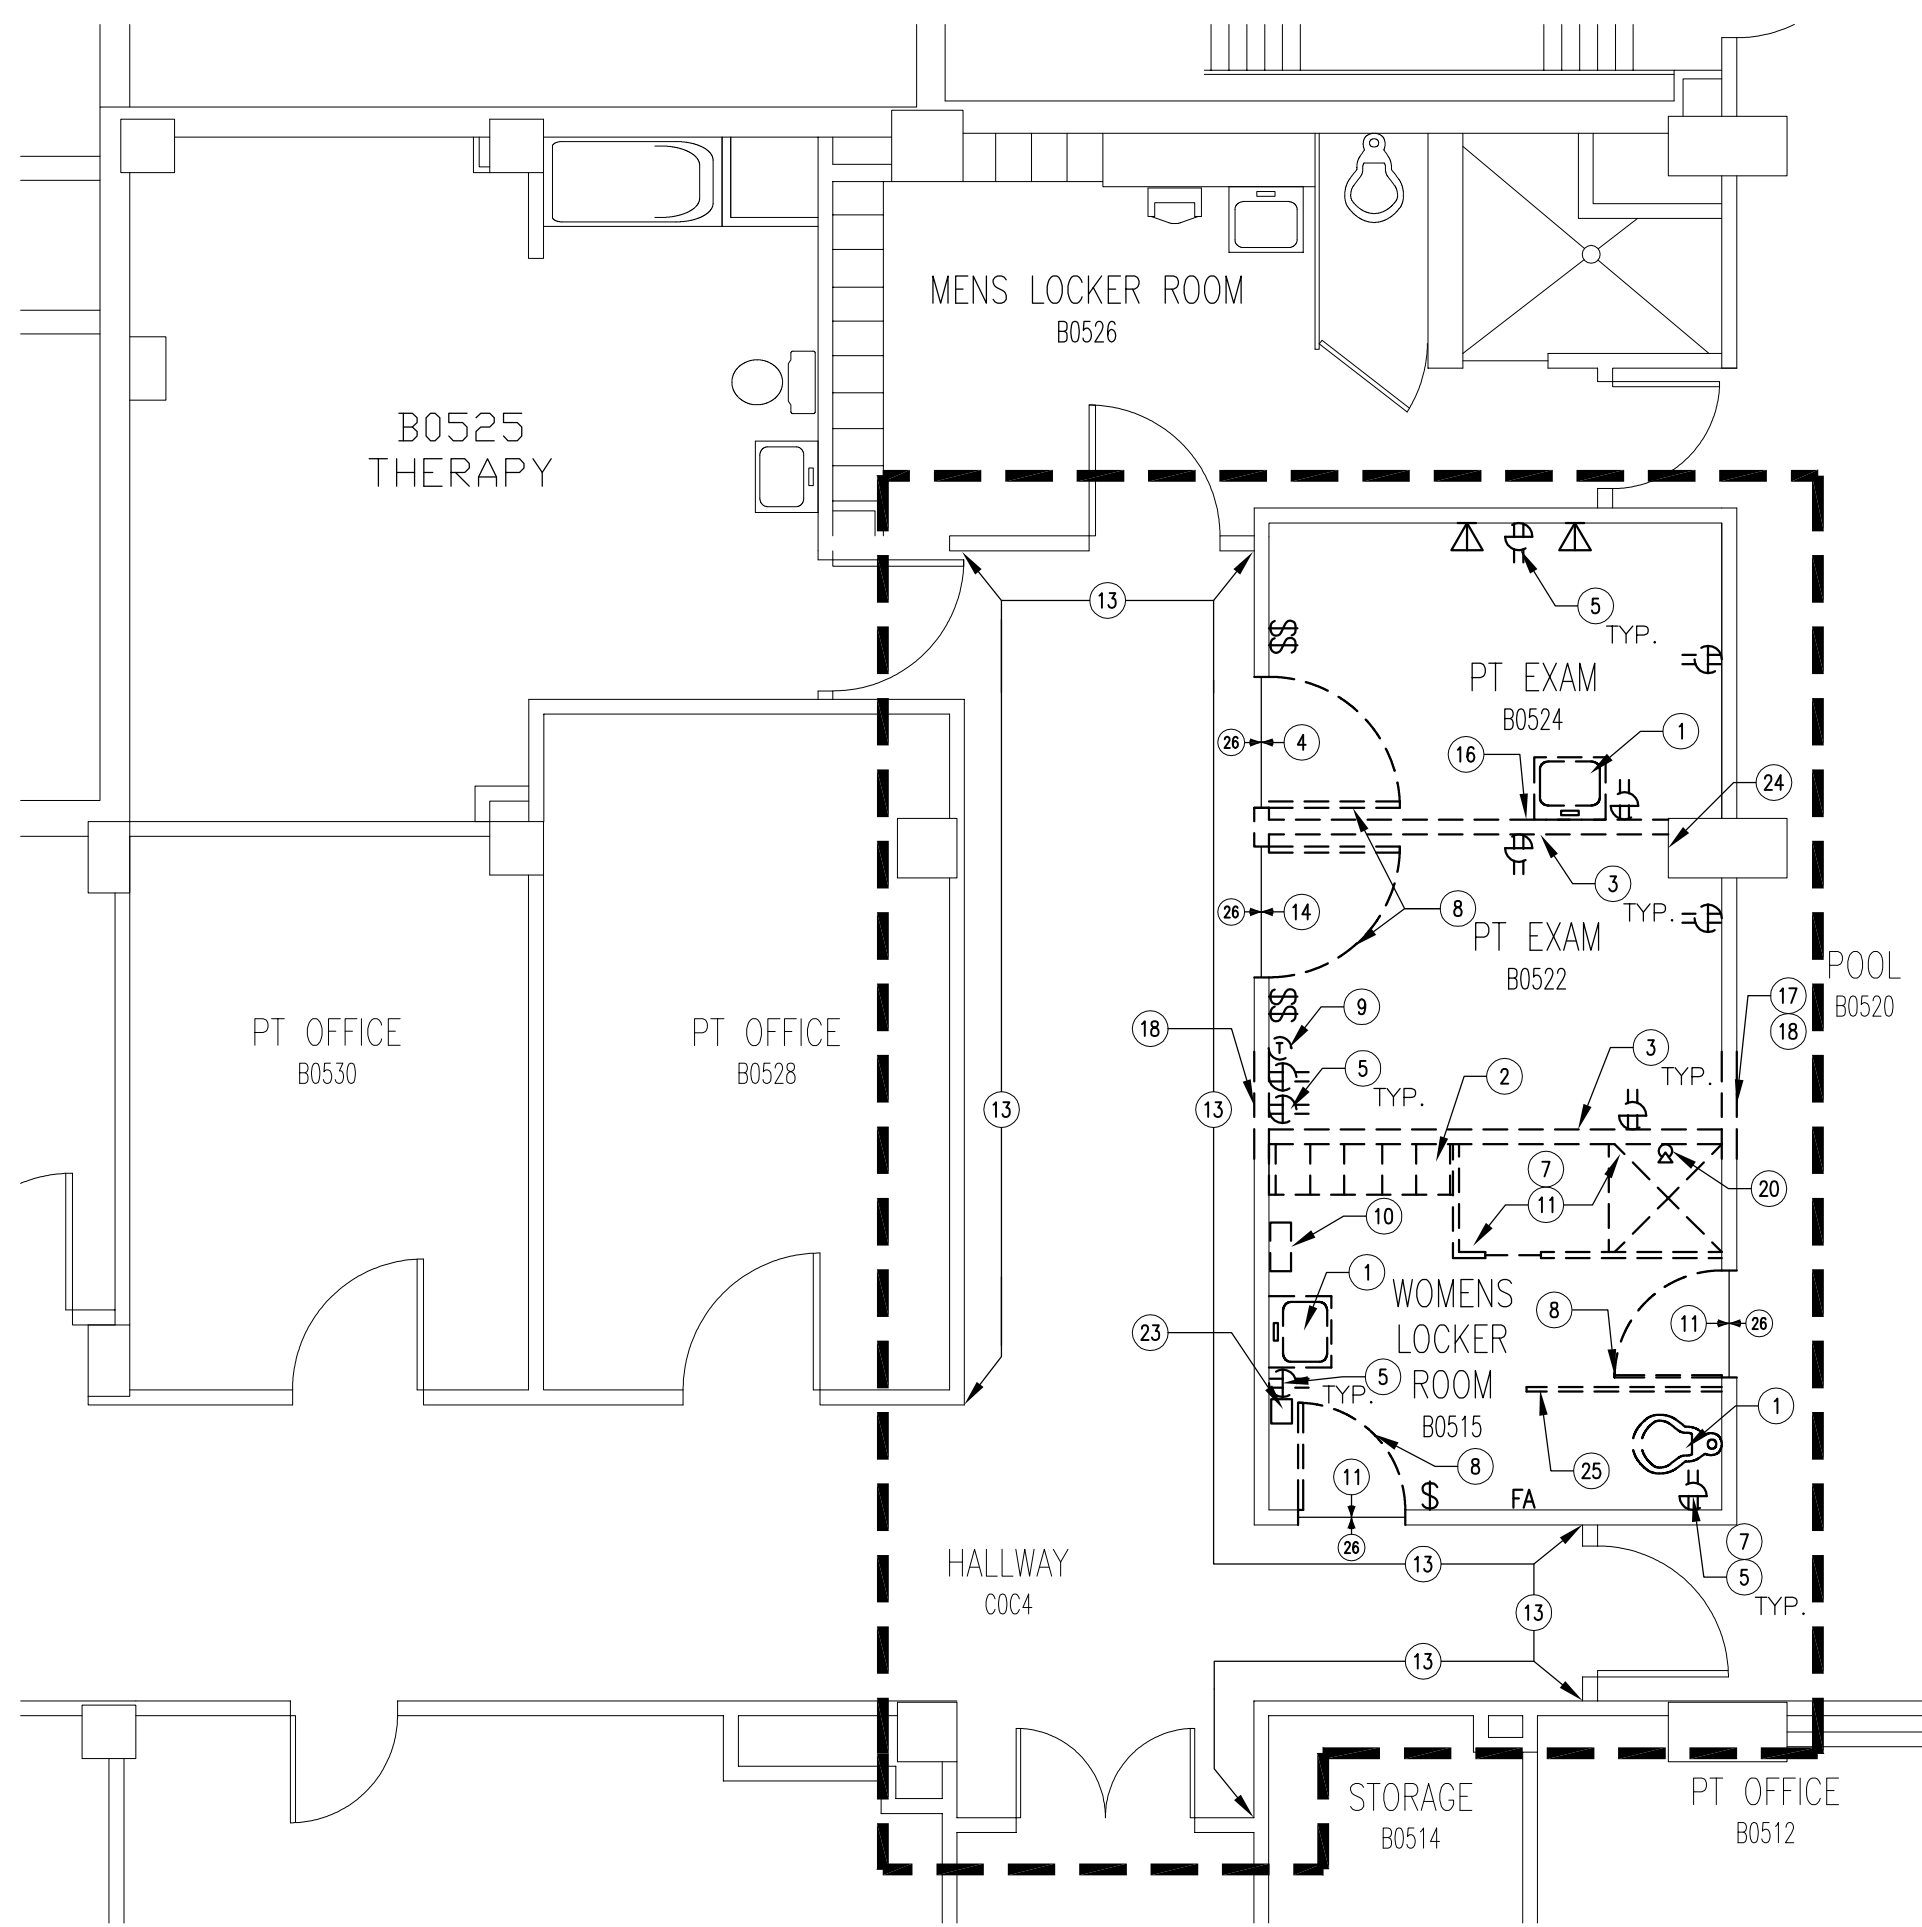

2 DEMOLITION PLAN - PHASE 2
3/16" = 1'-0"

PLUMBING, ELECTRICAL & MECHANICAL DEMOLITION NOTES

- ALL EXISTING PLUMBING SHOWN HATCHED AND/OR DESIGNATED WITH AN "X" SHALL BE REMOVED. ALL PLUMBING NOT INDICATED TO BE REMOVED SHALL REMAIN.
- WHERE EXISTING PIPING IS TO BE REMOVED AT A SLAB ON GRADE, CAP EXISTING PIPING FLUSH OR BELOW FLOOR LEVEL SO AS NOT TO INTERFERE WITH NEW FLOOR FINISHES.
- EXISTING PIPING SHALL BE REMOVED BACK TO PIPING TO REMAIN. EXISTING PIPING SHALL NOT BE ABANDONED IN PLACE UNLESS APPROVED BY THE ENGINEER AND OWNER'S REPRESENTATIVE.
- REPAIR PIPE INSULATION ON EXISTING PIPING WHERE DAMAGED BY DEMOLITION OR NEW WORK.
- DEMOLITION WORK SHALL BE COORDINATED WITH PHASED CONSTRUCTION. PLUMBING FIXTURES LOCATED OUTSIDE OF THE CURRENT CONSTRUCTION PHASE SHALL REMAIN OPERATIONAL UNLESS APPROVED BY THE OWNER'S REPRESENTATIVE.
- REFER TO THE SPECIFICATIONS FOR CUTTING AND PATCHING REQUIREMENTS.
- THIS CONTRACTOR SHALL BE RESPONSIBLE FOR ALL CUTTING AND PATCHING NECESSARY FOR THE WORK OF THIS CONTRACT UNLESS SPECIFICALLY INDICATED OTHERWISE WITHIN THE ARCHITECTURAL DRAWINGS OR SPECIFICATIONS.
- ALL EXISTING BRANCH WASTE PIPING SERVING NEW FIXTURES SHALL BE RODDED AND FLUSHED BACK TO THE WASTE STACK OR BUILDING DRAIN TO INSURE PROPER DRAINAGE.
- SEAL ALL EXISTING PIPE PENETRATIONS IN EXISTING CONSTRUCTION WHERE PIPING IS REMOVED. SEALED PENETRATIONS SHALL MATCH RATING OF THE CONSTRUCTION IN WHICH THEY OCCUR.
- PLUMBING CONTRACTOR SHALL REMOVE, AND REINSTALL OR REPLACE, EXISTING CEILING AS REQUIRED FOR ACCESS TO PLUMBING SYSTEMS, THIS INCLUDES, CEILING ON THE FLOORS BELOW THE PROJECT AREA AND AREAS OUTSIDE THE PROJECT CONSTRUCTION LIMITS.
- WHERE EXISTING PIPING IS REMOVED, REMAINING PIPING SHALL BE CAPPED BELOW FINISHED FLOORS, WITHIN WALLS AND ABOVE SUSPENDED CEILINGS.

ASBESTOS CONTAINING MATERIAL NOTES

- THE FOLLOWING AREAS ARE KNOWN TO BE ASBESTOS CONTAINING MATERIAL (ACM) AND MUST BE ABATED BY THE CONTRACTOR IF ACM MATERIALS ARE DISTURBED OR ENCOUNTERED:
 - VINYL ASBESTOS TILE AND MASTIC
 - EXISTING PLUMBING FITTINGS AND PIPING
 - EXISTING CONDITIONS WITHIN PLENUM
- THE CONTRACTOR SHALL CONFIRM ACM AREAS THE ASBESTOS REPORT INCLUDED IN THE PROJECT MANUAL.
- REMOVAL OF ACM SHALL COMPLY WITH ALL CITY, STATE, AND FEDERAL REGULATIONS. REMOVAL OF ACM SHALL CONFORM TO THE LATEST EDITION OF APPLICABLE OSHA AND AHERA REGULATIONS. ALSO COMPLY WITH THE STATE OF WISCONSIN DEPARTMENT OF NATURAL RESOURCES AND NESHAPS (40 cfr 60 & 62). WORK PRACTICES SHALL CONFORM TO NIRS GUIDANCE / WORK PRACTICES FOR THE REMOVAL OF ASBESTOS. IF ANY ADDITIONAL ACM OR POTENTIAL ACM IS IDENTIFIED DURING THE DEMOLITION OR CONSTRUCTION, THE CONTRACTOR SHALL NOTIFY THE RESIDENT ENGINEER IMMEDIATELY. ANY CONFIRMED ACM SHALL BE ABATED BY THE CONTRACTOR PER THE ABOVE REQUIREMENTS.

PLAN KEY NOTES

- REMOVE AND PROTECT PLUMBING FIXTURES TO BE REUSED. CONTRACTOR MAY NOT ABANDON IN PLACE. ASBESTOS MAY BE PRESENT ON EXISTING FITTINGS AND PIPING. CAP EXISTING PIPING BELOW FINISHED FLOOR IN SUB-BASEMENT.
- DEMO EXISTING LOCKERS, LOCKER BASE AND SOFFIT. CONTRACTOR TO REPAIR WALL FOR NEW FINISHES. SEE FINISH SCHEDULE.
- DEMO WALLS TO EXTENT AS SHOWN. DEMO WALLS TO THE UNDERSIDE OF THE STRUCTURAL DECK ABOVE. PATCH/REPAIR EXISTING WALLS FOR NEW FINISHES.
- DEMO EXISTING FLOORING AND BASE. PREPARE FOR INSTALLATION OF NEW FLOORING AS REQUIRED BY FLOORING MANUFACTURER. SEE FINISH SCHEDULE.
- DEMO EXISTING ELECTRICAL, OUTLETS, LIGHT SWITCHES, COVER PLATES, DATA/PHONE RECEPTACLES AND WALL ASSOCIATED CONDUIT, WIRING AND/OR CABLING BACK TO ELECTRICAL AND DATA CLOSETS. CONTRACTOR MAY NOT ABANDON IN PLACE.
- DEMO EXISTING RADIATOR HEAT AND ALL ASSOCIATED PIPING. CAP AS REQUIRED BELOW FINISHED FLOOR IN SUB-BASEMENT. CONTRACTOR TO ENSURE DEMOLITION DOES NOT PREVENT DESIGN INTENT AND ASBESTOS MAY BE PRESENT AS INSULATION OF PIPING.
- DEMO EXISTING NURSE CALL WALL OR CEILING MOUNTED BUTTONS, CONDUIT AND ASSOCIATED WIRING BACK TO ELECTRICAL/DATA CLOSET. CONTRACTOR MAY NOT ABANDON IN PLACE.
- REMOVE AND PROTECT EXISTING DOOR, FRAME AND HARDWARE FOR RE-USE AND RELOCATION.
- DEMO EXISTING THERMOSTAT, CONDUIT AND ASSOCIATED WIRING BACK TO SOURCE.
- REMOVE EXISTING HAND DRYERS FOR RE-USE AND ASSOCIATED WIRING. CONTRACTOR TO DEMOLITION EXISTING CONDUIT AND WIRING BACK TO SOURCE. BASED ON DESIGN INTENT OF NEW LOCATION, CONTRACTOR SHALL NOT PROVIDE ANY COVER PLATES AS ALL WORK IS TO BE DEMOLITION BACK TO SOURCE.
- DEMO EXISTING TILE FLOORING, CONCRETE SLAB/CURB WITH TILE. DEMOLITION OF EXISTING TILE AND SLAB TO ALIGN WITH EXISTING FLOOR HEIGHT. PREP FOR INSTALLATION OF NEW FLOORING AS ALL FLOORING TO BE LEVEL. SEE FINISH SCHEDULE.
- DEMO EXISTING CONCRETE CURB. DEMOLITION OF CURB SHALL ALIGN WITH EXISTING FLOOR. PREP FOR INSTALLATION OF NEW FLOORING. SEE FINISH SCHEDULE.
- DEMO OF EXISTING WALL COVERING. PREP WALLS TO RECEIVE NEW FINISHES. SEE FINISH SCHEDULE. DEMO MUST OCCUR AFTER HOURS AND NOT IMPACT PATIENT CARE. SEE DEMO GENERAL NOTE #16 FOR "AFTER HOURS".
- DEMO OF EXISTING VCT TILE FLOORING AND RUBBER BASE. CONTRACTOR TO ENSURE ABATEMENT OF ASBESTOS IS NOT REQUIRED.
- CONSTRUCT TEMPORARY IFC WALL PRIOR TO COMMENCEMENT OF PHASE 1 SCOPE OF WORK. SEE DETAIL 2/G-001.
- DEMO EXISTING WALL TILE AND BASE. CONTRACTOR TO ENSURE ABATEMENT OF ASBESTOS IS NOT REQUIRED.
- REMOVE, PROTECT FOR REUSE EXISTING WALL TILE AND BASE. CONTRACTOR TO ENSURE ABATEMENT OF ASBESTOS IS NOT REQUIRED.
- DEMO EXISTING WALL FOR INSTALLATION OF RELOCATED DOOR FRAME. SEE FLOOR PLANS FOR LOCATION AND CONTRACTOR TO COORDINATE DEMO WITH VA PRIOR TO WORK.
- REMOVE EXISTING BUILT-IN METAL STORAGE CABINETS. CONTRACTOR TO RELOCATE TO ROOM XXXX.
- DEMO EXISTING SHOWER/BATHTUB, HARDWARE, FLOOR DRAIN AND ASSOCIATED PLUMBING BACK TO PIPE MAIN. CONTRACTOR MAY NOT ABANDON IN PLACE. CAP EXISTING PIPING BELOW FINISHED FLOOR IN SUB-BASEMENT.
- DEMO EXISTING STORAGE CABINETS ABOVE EXISTING SHOWER/BATH TUB ENCLOSURE.
- DEMO EXISTING MARKER BOARD AND ASSOCIATED ACCESSORIES. CONTRACTOR TO PREP/PATCH/REPAIR WALL TO RECEIVE NEW FINISHES. SEE FINISH SCHEDULE.
- REMOVE AND RELOCATE FIXTURE IN WOMEN'S LOCKER ROOM. REPAIR/PATCH WALL TO RECEIVE NEW FINISHES. SEE FINISH SCHEDULE.
- DEMO EXISTING PIPING TO MAIN. CONTRACTOR MAY NOT ABANDON IN PLACE. CAP EXISTING PIPING BELOW FINISHED FLOOR IN SUB-BASEMENT.
- DEMO EXISTING TOILET PARTITIONS/ANCHORING ASSEMBLIES AND ASSOCIATED HARDWARE/ACCESSORIES.
- EXISTING TO REMAIN.


DEMOLITION GENERAL NOTES




- INFORMATION PERTAINING TO EXISTING PROJECT CONDITIONS, SUCH AS PRESENT LOCATIONS OF ARCHITECTURAL, STRUCTURAL BUILDING COMPONENTS, MECHANICAL AND ELECTRICAL EQUIPMENT, PIPING, DUCTWORK, ROUGH-INS AND OTHER MISCELLANEOUS CONSTRUCTION APPEARS ON THE DRAWINGS. WHILE SUCH INFORMATION HAS BEEN BASED ON AVAILABLE RECORDS AND COLLECTED WITH REASONABLE CARE, THE ARCHITECT AND ENGINEER DOES NOT ASSUME ANY EXPRESSED OR IMPLIED GUARANTEE THAT CONDITIONS SO INDICATED ARE SHOWN ENTIRELY COMPLETE, CORRECT AND REPRESENTATIVE OF THOSE ACTUALLY EXISTING. ALL CONTRACTORS SHALL SATISFY THEMSELVES AS TO ALL EXISTING JOB CONDITIONS PRIOR TO BIDDING, AND VERIFY ALL DIMENSIONS AT THE SITE.
- REMOVE EXISTING CONSTRUCTION WITHIN PROJECT LIMITS AS INDICATED OR AS REQUIRED TO COMPLETE WORK.
- CONTRACTOR SHALL VERIFY ALL EXISTING CONDITIONS AND DIMENSIONS PRIOR TO BEGINNING DEMOLITION OR CONSTRUCTION. CONTRACTOR SHALL REPORT ANY DISCREPANCIES TO THE RESIDENT ENGINEER PRIOR TO START OF DEMOLITION CONSTRUCTION ACTIVITIES.
- THE CONTRACTOR SHALL NOTIFY THE RESIDENT ENGINEER PRIOR TO REMOVAL OF MATERIAL, FURNITURE, CASEWORK, OR EQUIPMENT NOT INDICATED ON THE DRAWINGS TO BE REMOVED.
- SHOULD MATERIAL APPEARING TO CONTAIN ASBESTOS BE ENCOUNTERED DURING THE COURSE OF WORK, CONTRACTOR SHALL STOP WORKING INVOLVING SAID MATERIAL AND NOTIFY THE RESIDENT ENGINEER IMMEDIATELY.
- UNLESS DIRECTED OTHERWISE, DISPOSE OF ALL ITEMS SHOWN TO BE DEMOLISHED.
- WHERE PARTITION OR CEILING MOUNTED EQUIPMENT, NOT CALLED OUT FOR DEMOLITION IN ARCHITECTURAL, MECHANICAL, PLUMBING, OR ELECTRICAL DRAWINGS, IS ATTACHED TO PARTITIONS OR CEILINGS SCHEDULED FOR DEMOLITION, CONTRACTOR SHALL COORDINATE REMOVAL OF SAID EQUIPMENT WITH RESIDENT ENGINEER.
- REFER TO MECHANICAL AND ELECTRICAL DRAWINGS FOR ADDITIONAL DEMOLITION NOTES. PATCH REPAIR SURFACES AS REQUIRED IN ASSOCIATED ELECTRICAL, DATA, AND PLUMBING WORK AND PREPARE TO RECEIVE NEW FINISH.
- UNLESS OTHERWISE NOTED, ALL PLUMBING FIXTURES/DOMESTIC WATER PIPING TO BE REMOVED SHALL BE FREZZED AND CAPPED BELOW FLOOR STRUCTURE PRIOR TO START OF DEMOLITION WORK.
- THE CONTRACTOR SHALL BE RESPONSIBLE FOR PROTECTION OF EXISTING STRUCTURES, EQUIPMENT, AND FINISHES SURROUNDING THE AREA OF WORK. DAMAGE TO EXISTING STRUCTURES, PAVEMENT/GRADES, EQUIPMENT OR FINISHES SHALL BE REPAIRED OR REPLACED AT NO ADDITIONAL COST TO THE OWNER. REPAIR AND REPLACEMENT SHALL MATCH ADJACENT MATERIALS. EXTEND REPAIR AND REPLACEMENT TO BREAK IN PLAN OR FIRST MATERIAL JOINT BEYOND DAMAGE.
- ALL EXISTING SURFACES WHICH REMAIN IN PLACE WITHIN AREA OF WORK SHALL BE PATCHED AND REPAIRED AS REQUIRED AND PREPARED TO RECEIVE NEW FINISH.
- CONTRACTOR SHALL REPAIR AND/OR RESTORE EXISTING CONSTRUCTION DAMAGED BY ALTERATIONS TO MECHANICAL AND ELECTRICAL SYSTEMS, WHETHER OR NOT WORK IS WITHIN DEMOLITION AREAS SHOWN.
- COORDINATE DEMOLITION WITH SCHEDULES, CONSTRUCTION REQUIREMENTS, AND SUBCONTRACTORS OPERATIONS. COORDINATE SEQUENCING WITH THE CONSTRUCTION MANAGER AND PROCEED ONLY AFTER OBTAINING THE RESIDENT ENGINEER'S ACCEPTANCE OF DEMOLITION SCHEDULE.
- ALL WORK MUST BE COORDINATED WITH THE RESIDENT ENGINEER TO NOT ADVERSELY AFFECT OPERATIONS OUTSIDE OF THE WORK AREA. TEMPORARY 1-HOUR FIRE RATED CONSTRUCTION PARTITIONS WILL BE REQUIRED WHEN WORK AREA EXTENDS INTO AND AFFECTS EXISTING FACILITY OPERATIONS. NO WORK SHALL BE STARTED WHICH AFFECTS EXISTING FACILITY OPERATIONS WITHOUT PRIOR COORDINATION AND APPROVAL OF THE WORK WITH THE RESIDENT ENGINEER.
- FLOOR SURFACES DAMAGED OR BENEATH EXISTING CASEWORK TO BE PATCHED AND PREPARED TO MATCH SURROUNDING FLOOR SURFACES.
- DEMOLITION WORK CAUSING VIBRATION AND/OR LOUD NOISE DISRUPTIVE TO HOSPITAL FUNCTIONS AS DEEMED BY THE OWNER SHALL BE SCHEDULED TO BE DONE AFTER HOURS. AFTER HOURS IS DEFINED AS BETWEEN 6:00 PM AND 5:00 AM - RETURN NON-PROJECT AREAS TO HOSPITAL LEVEL CLEANLINESS BEFORE 6:00 AM.
- PATCH CONCRETE FLOOR PENETRATIONS FOR ALL DEMOLISHED PLUMBING FIXTURES, CUT EXISTING CONCRETE FLOOR AS NECESSARY TO ACCOMMODATE NEW PIPING, CONDUIT OR OTHER WORK. PATCH BACK TO MATCH SURROUNDING SURFACES AT CORNERS - DRILL WITH ROTARY HAMMER, DO NOT OVER SCORE CONCRETE TO BE CUT.
- WHERE REMOVAL OF EXISTING CONSTRUCTION DISRUPTS EXISTING ELECTRICAL, MECHANICAL, AND PLUMBING SERVICES, MAKE PERMANENT (OR TEMPORARY) CONNECTIONS TO RESTORE AFFECTED SERVICES TO AREAS NOT SCHEDULED FOR DEMOLITION AND REMODELING. WHERE TEMPORARY CONNECTION ARE PROVIDED, RESTORE PERMANENT SERVICE PRIOR TO PROJECT COMPLETION.
- CONTRACTOR SHALL INSURE THAT ALL FINISHED OR UNFINISHED WALL AND FLOOR AREAS, PATH OF TRAVEL, ACCESSIBLE TO THE PUBLIC DURING BUSINESS HOURS ARE CLEAN, DRY, FREE OF DEBRIS AND GLUE, AND SUITABLE FOR USE.
- IN KEY NOTES, "REMOVE" MEANS REMOVE, HAUL AWAY, AND DISPOSE OF IN ACCORDANCE WITH APPLICABLE LAWS AND REGULATIONS. REFER ALSO TO SECTION 01 74 19 CONSTRUCTION WASTE MANAGEMENT.
- ALL WORK SHALL COMPLY WITH THE REQUIREMENTS OF NATIONAL AND LOCAL CODES, WHICHEVER IS MORE STRINGENT.
- CONTRACTOR SHALL COORDINATE MATERIAL STORAGE WITH THE RESIDENT ENGINEER.
- CONTRACTOR SHALL PROVIDE FIRE PROTECTION EQUIPMENT (FIRE EXTINGUISHERS, ETC.) AND INSPECT THEM MONTHLY AS REQUIRED DURING DEMOLITION AND NEW CONSTRUCTION WORK.
- CONTRACTOR SHALL PROVIDE TEMPORARY SEAL AT ALL DOOR AND WALL OPENINGS AT PERIMETER WALLS DURING DEMOLITION AND NEW CONSTRUCTION WORK TO PROTECT ADJACENT AREAS FROM DUST INTRUSION.
- VERIFY FIELD DIMENSIONS, COORDINATE ACTUAL DIMENSIONS WITH OWNER'S REPRESENTATIVE. GENERAL CONTRACTOR TO SUBMIT CONCRETE & STEEL SHOP DRAWINGS INDICATING ACTUAL FIELD DIMENSIONS, CONTRACTOR RESPONSIBLE TO DIMENSION OF STRUCTURE TO FIT EXISTING CONDITIONS.
- CONTRACTOR RESPONSIBLE TO ABATE ALL ASBESTOS CONTAINING MATERIALS IN AREA OF WORK.
- REMOVE EXISTING LIGHTING, POWER AND DATA BACK TO J-BOX INCLUDE SWITCHES, WIRING, ETC. & PREP FOR NEW LIGHTING-COORDINATED WITH ELECTRICAL CONTRACTOR

GRAPHIC LEGEND


- | | | | |
|--|-------------------------|--|-------------------|
| | EXISTING WALL TO REMAIN | | PLAN KEY NOTE |
| | EXISTING DOOR TO REMAIN | | DEMOLITION/REMOVE |

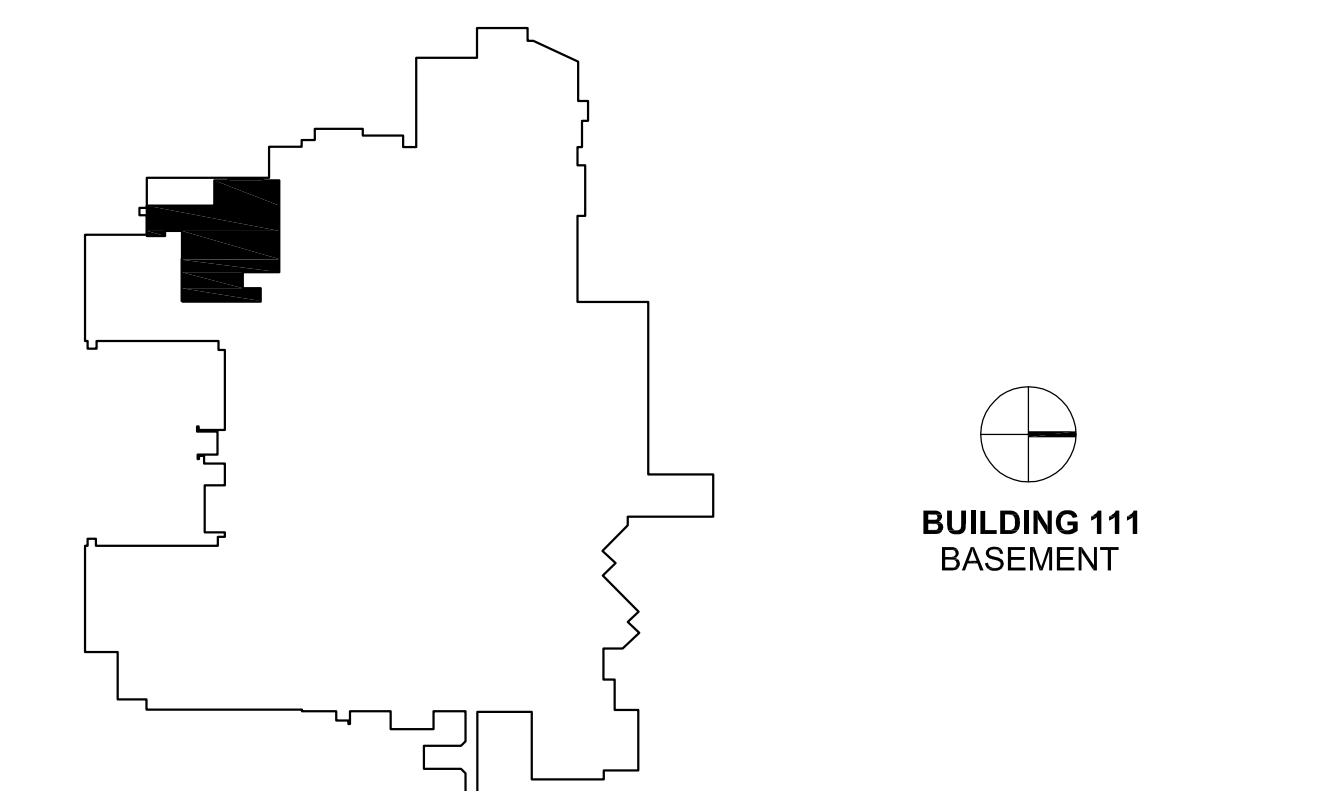KEY PLAN




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| | |  | Dept. of Veterans Affairs Medical Center 5000 W. National Avenue Milwaukee, WI |  | ARCHITECT: CLEMENT J. ZABLOCKI VA MEDICAL CENTER OFFICE OF CONSTRUCTION AND FACILITIES MANAGEMENT | Drawing Title PHASE 1 - 3: DEMOLITION FLOOR PLANS | | Project Title 111 Upgrade Pool Locker Rooms | | Project Number 695-14-114 | | Office of Construction and Facilities Management |
| | | | | | | Approved: Project Director Troy Martinson, PE | | Location VA Medical Center, Milwaukee, WI | | Building Number Building 111 | | |
| Revisions: | | | | | | Date: | | Date August 28, 2015 | | Checked AJ | | |
| | | | | | | | | | | | |  Department of Veterans Affairs |


three inches = one foot
one and one half inches = one foot
one inch = one foot
three quarters inch = one foot
one half inch = one foot
three eighths inch = one foot
one quarter inch = one foot
one eighth inch = one foot

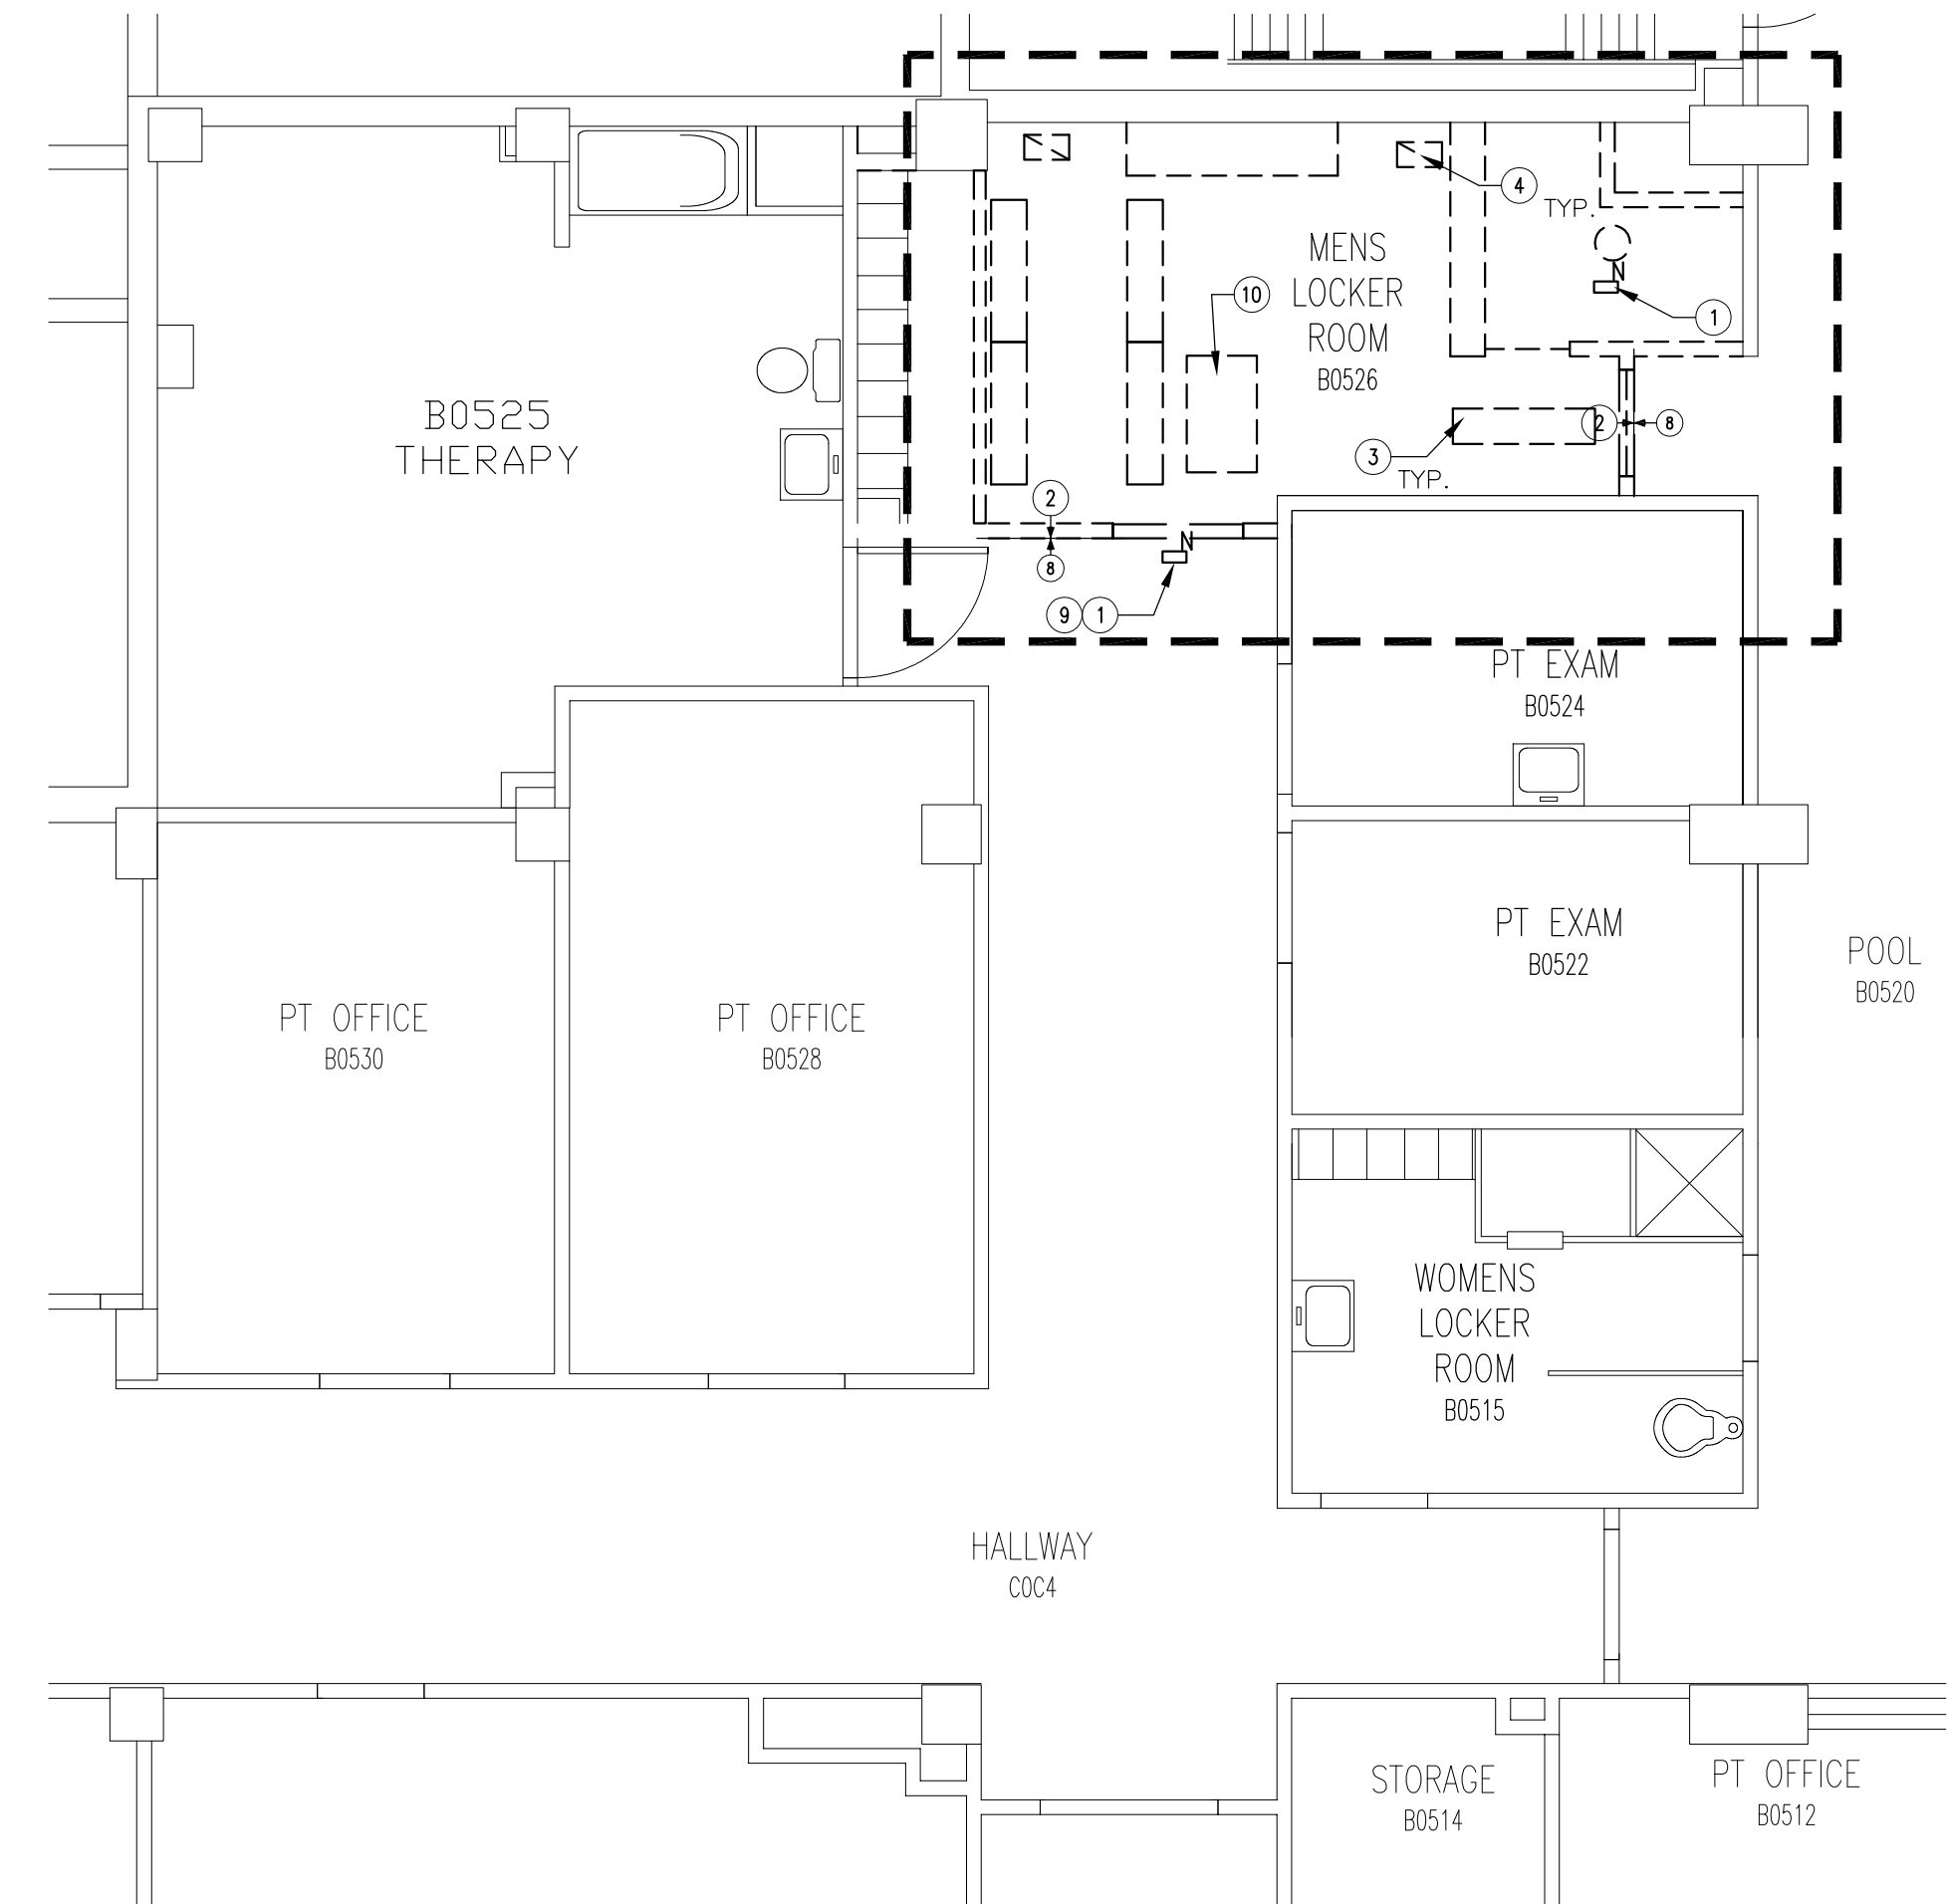

3 DEMOLITION RCP PLAN - PHASE 3
3/16" = 1'-0"

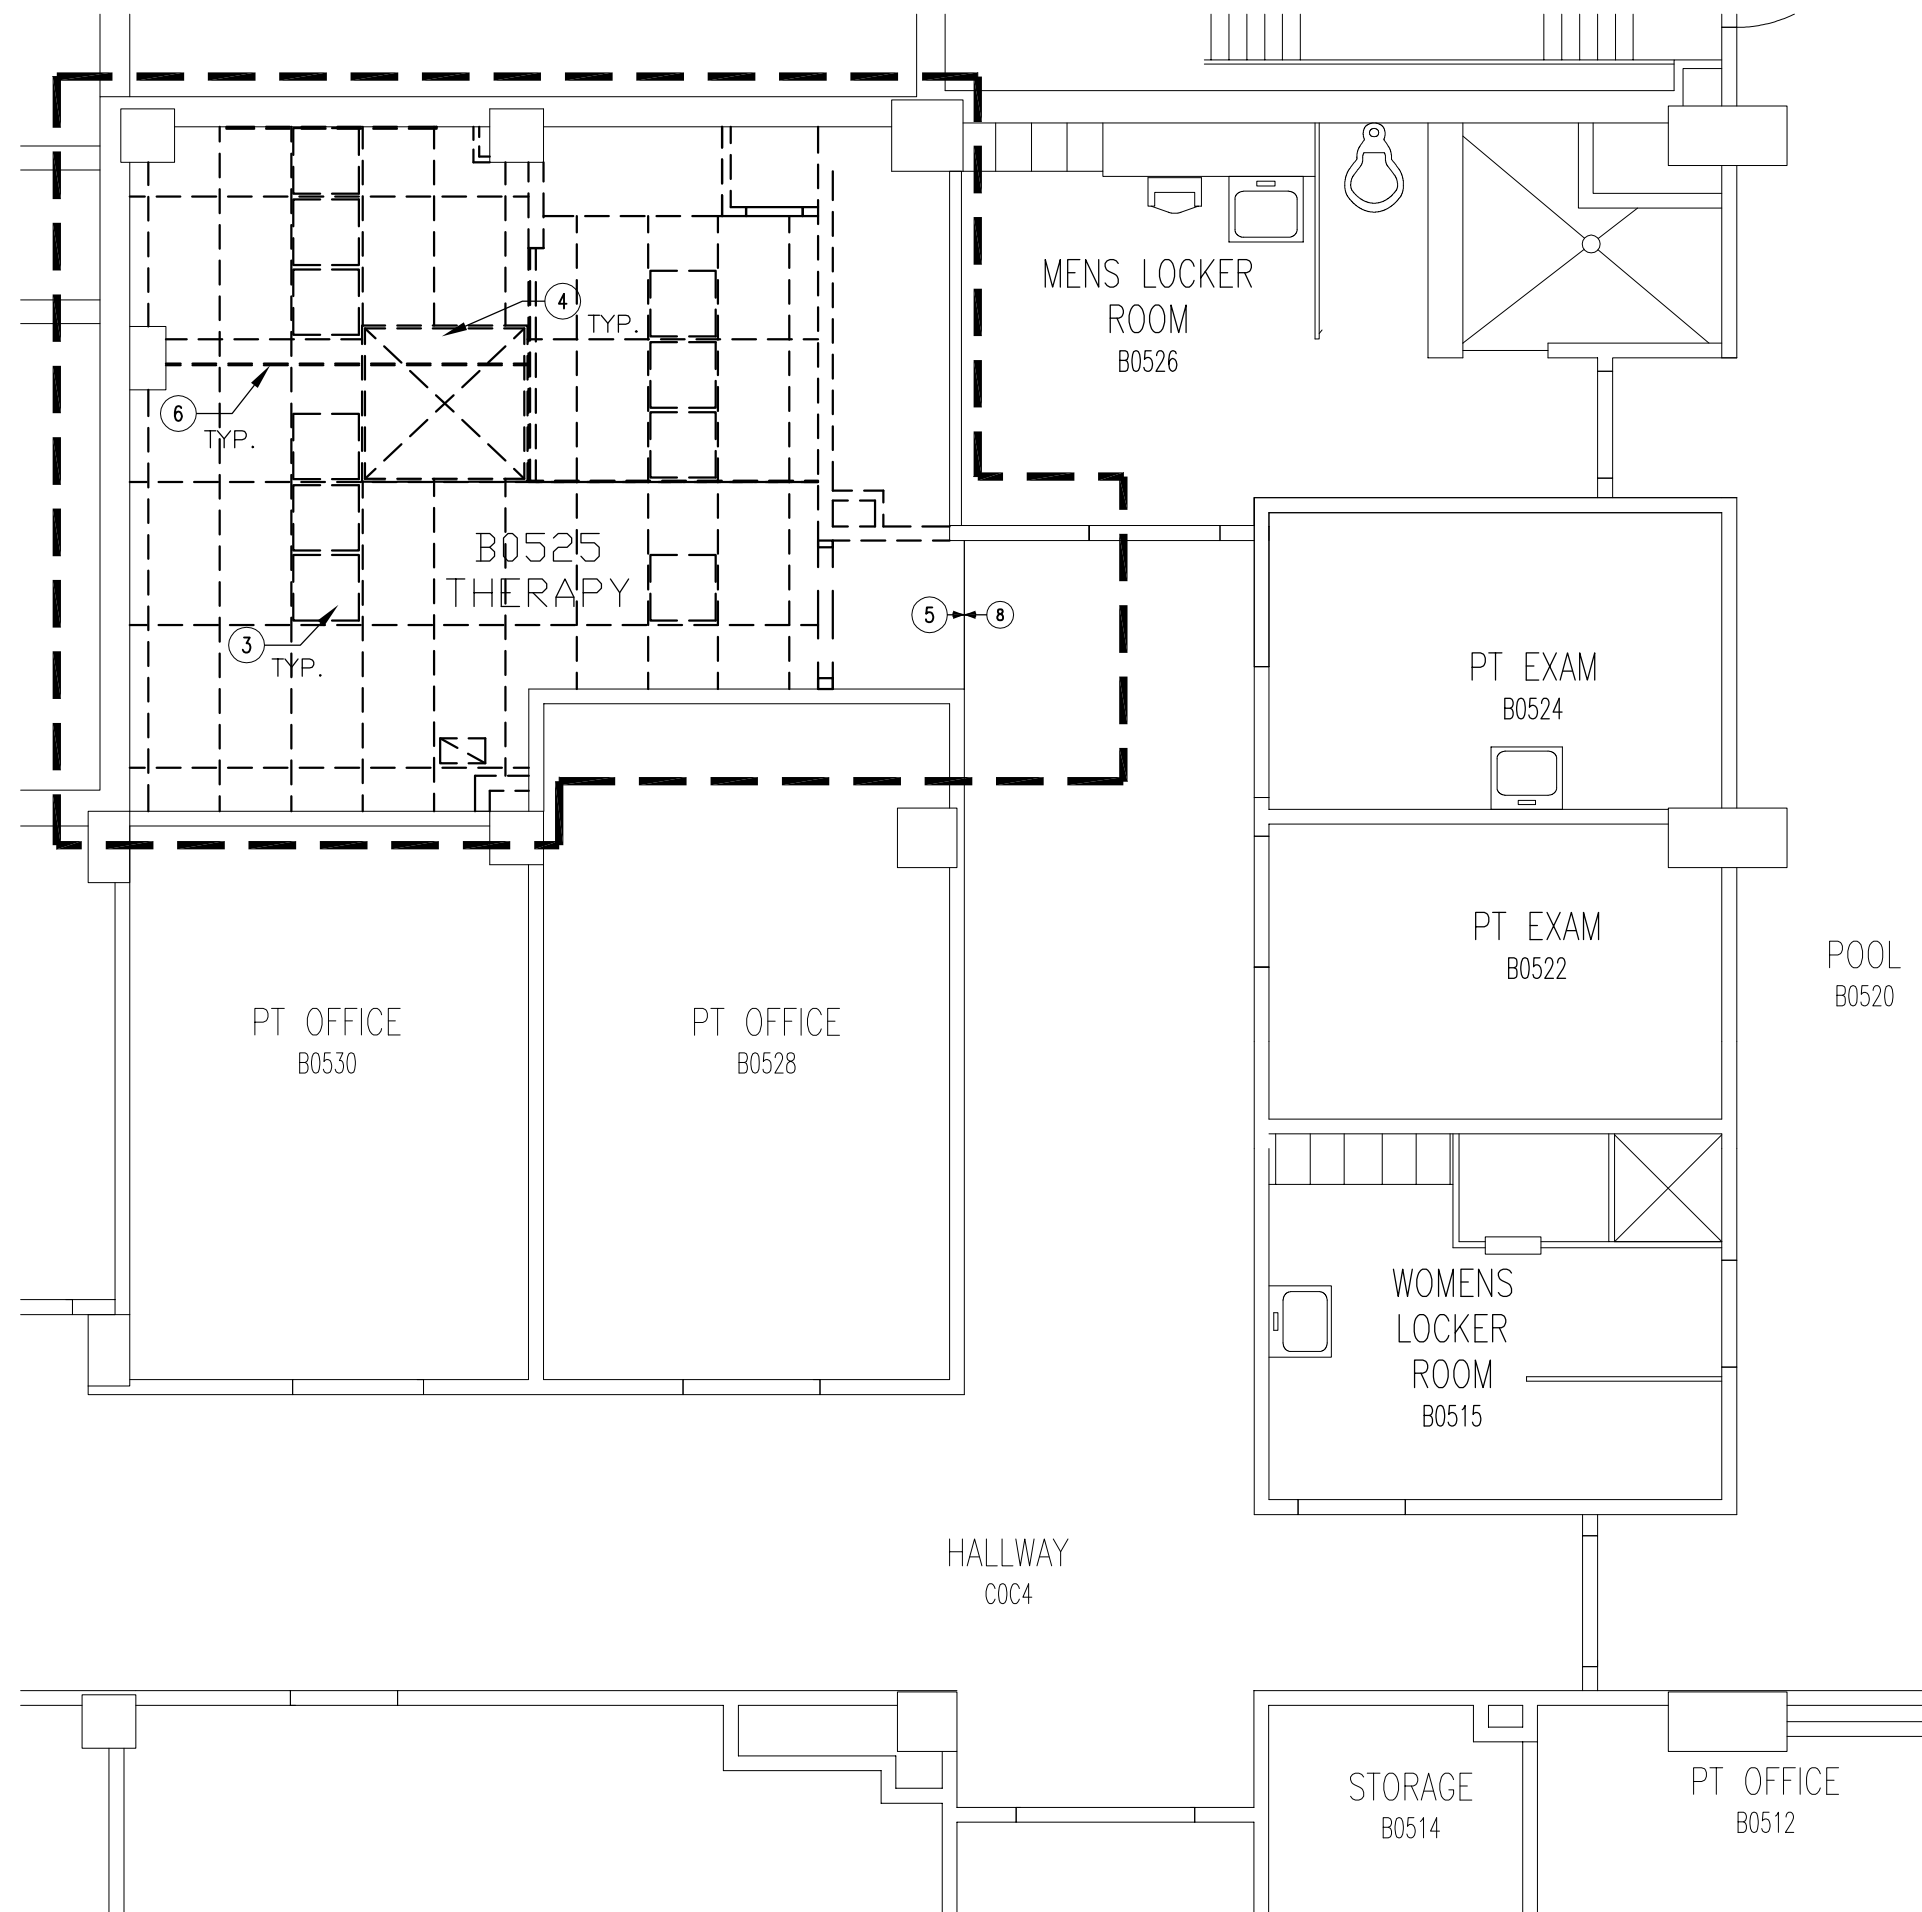

1 DEMOLITION RCP PLAN - PHASE 1
3/16" = 1'-0"

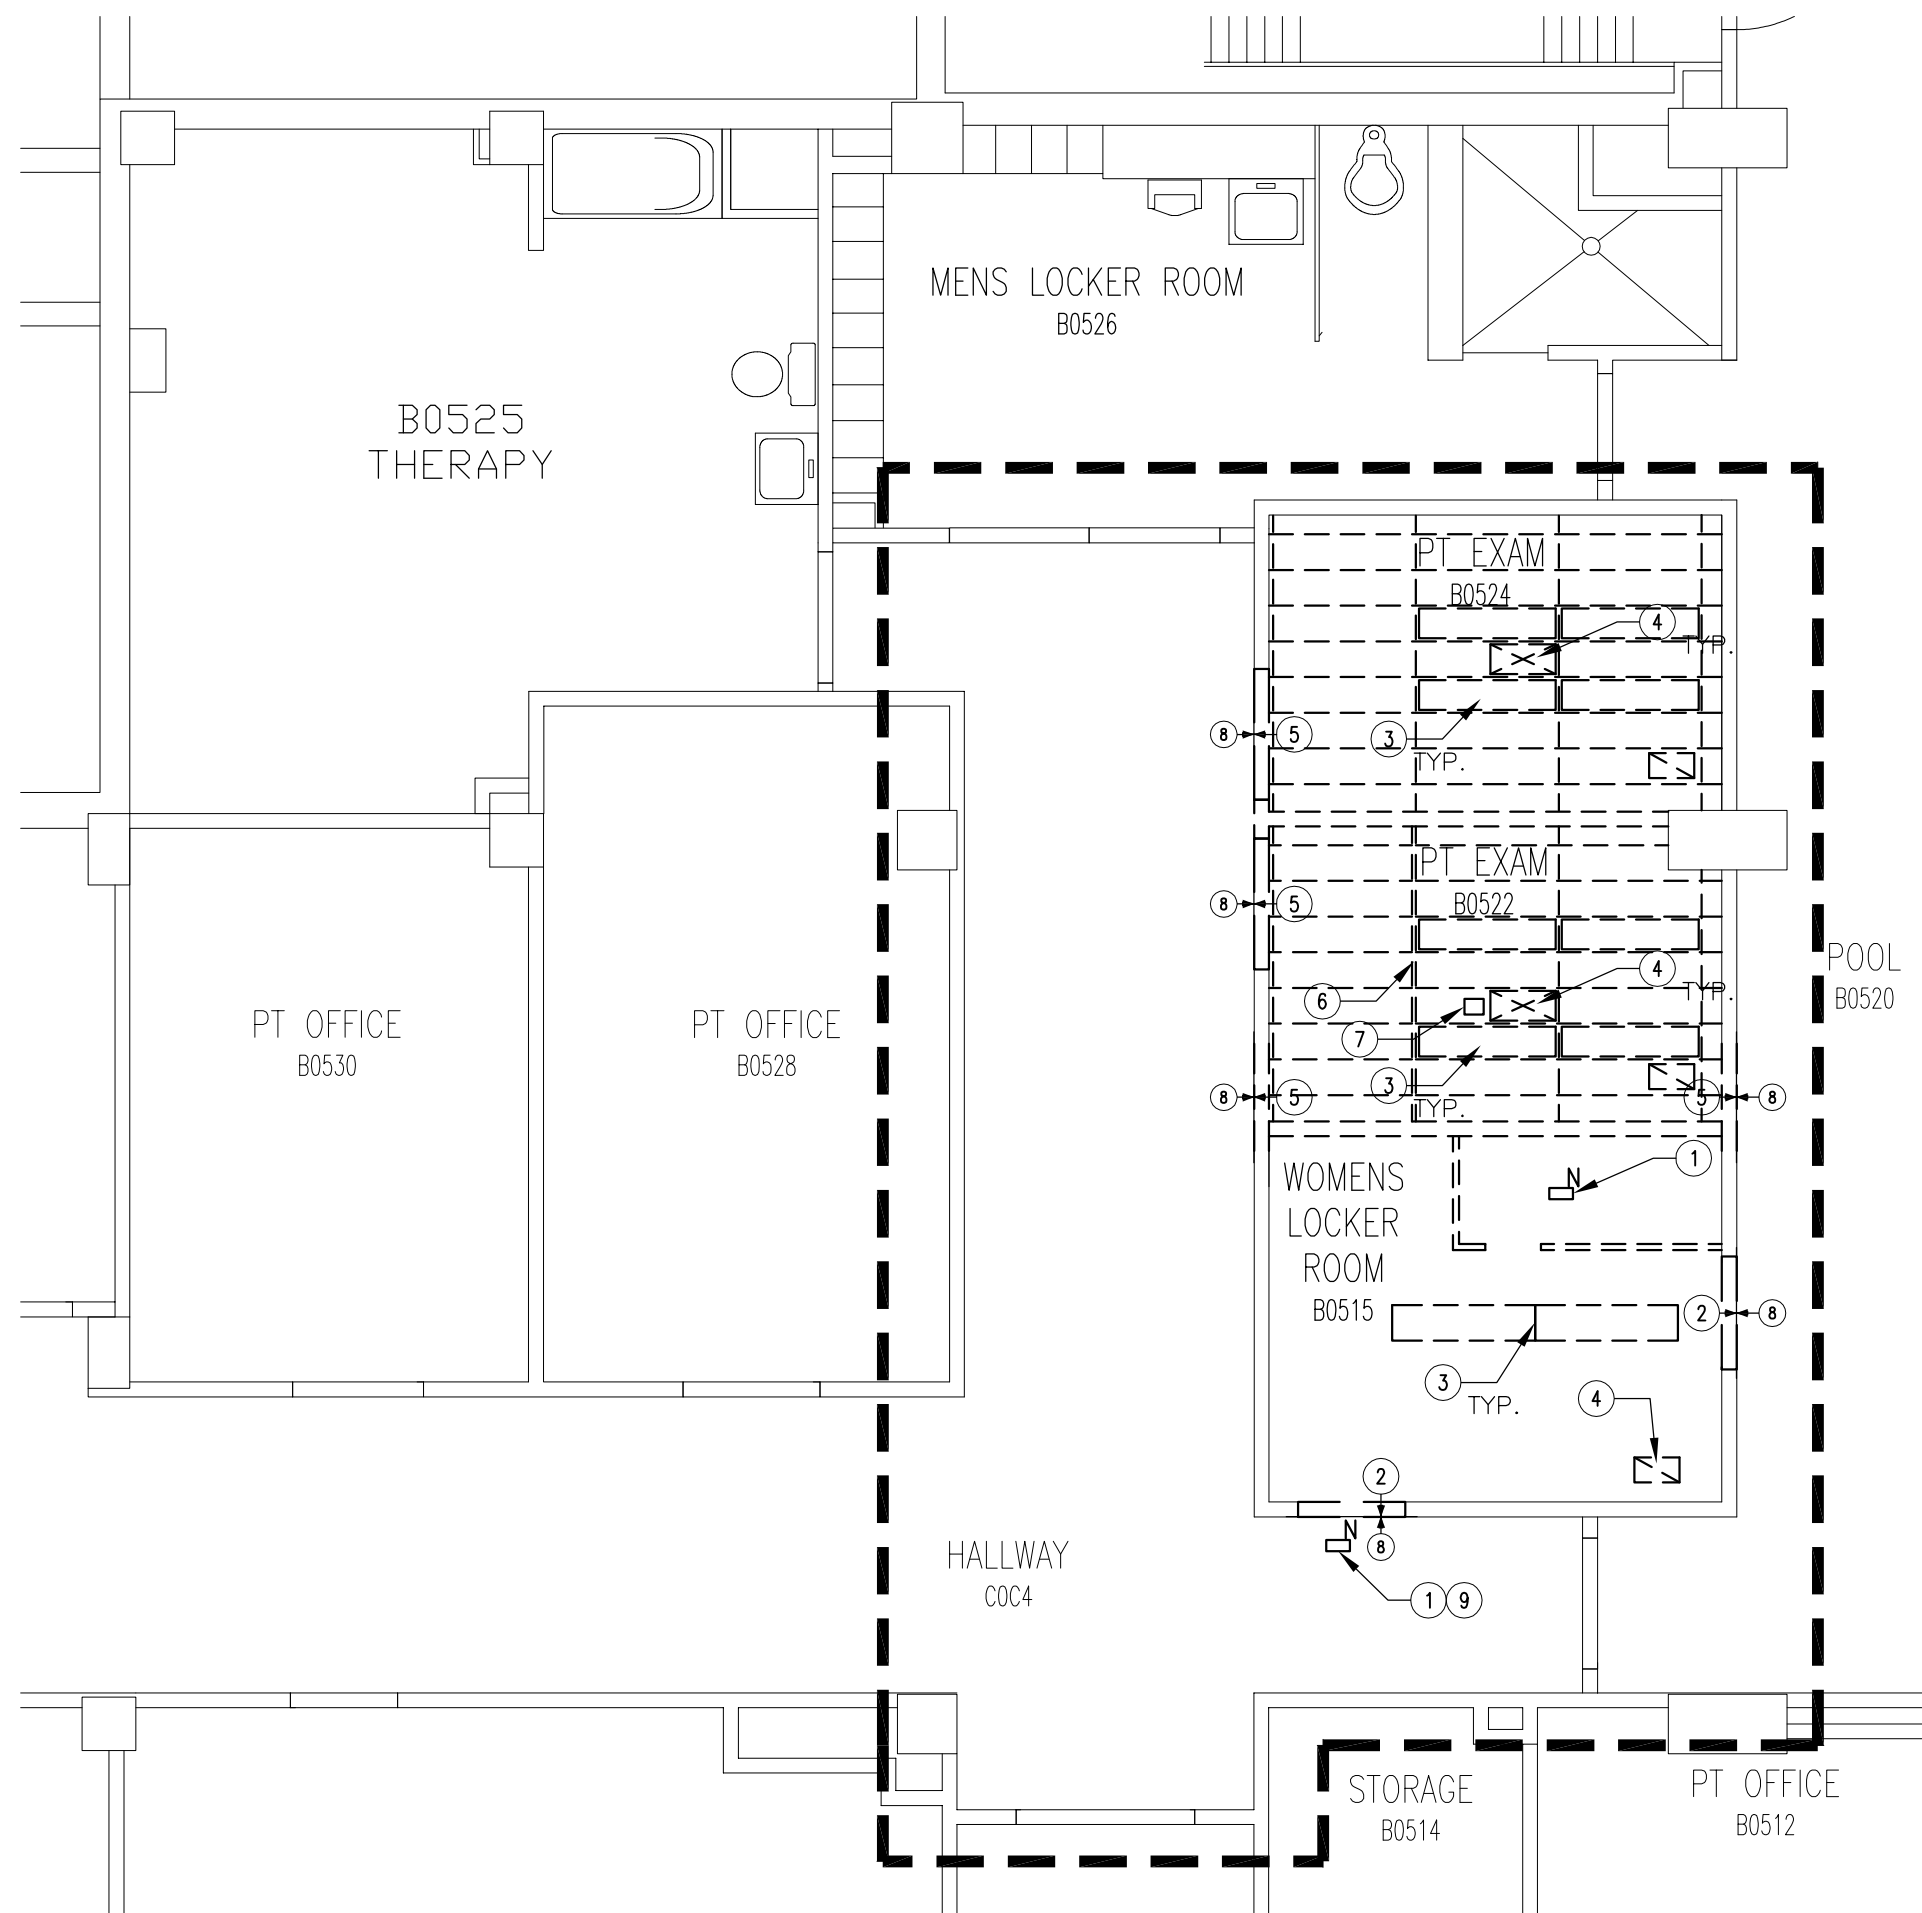

2 DEMOLITION RCP PLAN - PHASE 2
3/16" = 1'-0"

PLUMBING, ELECTRICAL & MECHANICAL DEMOLITION NOTES

1. ALL EXISTING PLUMBING SHOWN HATCHED AND/OR DESIGNATED WITH AN "X" SHALL BE REMOVED. ALL PLUMBING NOT INDICATED TO BE REMOVED SHALL REMAIN.
2. WHERE EXISTING PIPING IS TO BE REMOVED AT A SLAB ON GRADE, CAP EXISTING PIPING FLUSH OR BELOW FLOOR LEVEL SO AS NOT TO INTERFERE WITH NEW FLOOR FINISHES.
3. EXISTING PIPING SHALL BE REMOVED BACK TO PIPING TO REMAIN. EXISTING PIPING SHALL NOT BE ABANDONED IN PLACE UNLESS APPROVED BY THE ENGINEER AND OWNER'S REPRESENTATIVE.
4. REPAIR PIPE INSULATION ON EXISTING PIPING WHERE DAMAGED BY DEMOLITION OR NEW WORK.
5. DEMOLITION WORK SHALL BE COORDINATED WITH PHASED CONSTRUCTION. PLUMBING FIXTURES LOCATED OUTSIDE OF THE CURRENT CONSTRUCTION PHASE SHALL REMAIN OPERATIONAL UNLESS APPROVED BY THE OWNER'S REPRESENTATIVE.
6. REFER TO THE SPECIFICATIONS FOR CUTTING AND PATCHING REQUIREMENTS.
7. THIS CONTRACTOR SHALL BE RESPONSIBLE FOR ALL CUTTING AND PATCHING NECESSARY FOR THE WORK OF THIS CONTRACT UNLESS SPECIFICALLY INDICATED OTHERWISE WITHIN THE ARCHITECTURAL DRAWINGS OR SPECIFICATIONS.
8. ALL EXISTING BRANCH WASTE PIPING SERVING NEW FIXTURES SHALL BE RODDED AND FLUSHED BACK TO THE WASTE STACK OR BUILDING DRAIN TO INSURE PROPER DRAINAGE.
9. SEAL ALL EXISTING PIPE PENETRATIONS IN EXISTING CONSTRUCTION WHERE PIPING IS REMOVED. SEALED PENETRATIONS SHALL MATCH RATING OF THE CONSTRUCTION IN WHICH THEY OCCUR.
10. PLUMBING CONTRACTOR SHALL REMOVE, AND REINSTALL OR REPLACE, EXISTING CEILINGS AS REQUIRED FOR ACCESS TO PLUMBING SYSTEMS. THIS INCLUDES, CEILINGS ON THE FLOORS BELOW THE PROJECT AREA AND AREAS OUTSIDE THE PROJECT CONSTRUCTION LIMITS.
11. WHERE EXISTING PIPING IS REMOVED, REMAINING PIPING SHALL BE CAPPED BELOW FINISHED FLOORS, WITHIN WALLS AND ABOVE SUSPENDED CEILINGS, BEYOND DAMAGE.

ASBESTOS CONTAINING MATERIAL NOTES

1. THE FOLLOWING AREAS ARE KNOWN TO BE ASBESTOS CONTAINING MATERIAL (ACM) AND MUST BE ABATED BY THE CONTRACTOR IF ACM MATERIALS ARE DISTURBED OR ENCOUNTERED:
 - A. VINYL ASBESTOS TILE AND MASTIC
2. THE CONTRACTOR SHALL CONFIRM ACM AREAS THE ASBESTOS REPORT INCLUDED IN THE PROJECT MANUAL.
3. REMOVAL OF ACM SHALL COMPLY WITH ALL CITY, STATE, AND FEDERAL REGULATIONS. REMOVAL OF ACM SHALL CONFORM TO THE LATEST EDITION OF ALL APPLICABLE OSHA AND AHERA REGULATIONS. ALSO COMPLY WITH THE STATE OF WISCONSIN DEPARTMENT OF NATURAL RESOURCES AND RESHAPS (40 cfr 60 & 92). WORK PRACTICES SHALL CONFORM TO NIBS GUIDANCE/ WORK PRACTICES FOR THE REMOVAL OF ASBESTOS. IF ANY ADDITIONAL ACM OR POTENTIAL ACM IS IDENTIFIED DURING THE DEMOLITION OR CONSTRUCTION, THE CONTRACTOR SHALL NOTIFY THE RESIDENT ENGINEER IMMEDIATELY. ANY CONFIRMED ACM SHALL BE ABATED BY THE CONTRACTOR PER THE ABOVE REQUIREMENTS.

GRAPHIC LEGEND

- | | | | |
|--|-------------------------|--|-------------------|
| | EXISTING WALL TO REMAIN | | PLAN KEY NOTE |
| | EXISTING DOOR TO REMAIN | | DEMOLITION/REMOVE |


PLAN KEY NOTES

- 1 DEMO EXISTING CEILING MOUNTED NURSE CALL BUTTONS/INDICATORS, CONDUIT AND ASSOCIATED WIRING BACK TO ELECTRICAL CLOSET. CONTRACTOR MAY NOT ABANDON IN PLACE.
- 2 DEMO EXISTING GYPSUM BOARD CEILING. PREP/REPAIR WALLS FOR NEW CEILING. SEE FINISH SCHEDULE FOR TYPE OF CEILING TO BE INSTALLED.
- 3 DEMO EXISTING LIGHT FIXTURES, CONDUIT AND ASSOCIATED WIRING BACK TO ELECTRICAL CLOSET. CONTRACTOR MAY NOT ABANDON IN PLACE.
- 4 DEMO EXISTING SUPPLY AND RETURN AIR REGISTERS AND ASSOCIATED DUCT WORK BACK TO SOURCE. CONTRACTOR MAY NOT ABANDON IN PLACE.
- 5 DEMO EXISTING CEILING GRID AND CEILING TILES. PREP/REPAIR WALLS FOR NEW CEILING. SEE FINISH SCHEDULE FOR TYPE OF CEILING TO BE INSTALLED.
- 6 DEMO EXISTING CEILING MOUNTED CURTAIN TRACK AND ALL ASSOCIATED HARDWARE.
- 7 REMOVE FOR REUSE EXISTING WIFI RECEIVER AND DEMO ASSOCIATED CABLING BACK TO DATA CLOSET. CONTRACTOR MAY NOT ABANDON IN PLACE.
- 8 EXISTING TO REMAIN.
- 9 REPAIR/REPLACE/PATCH CEILING WHERE DEMO OF EXISTING NURSE CALL INDICATOR WAS REMOVED. CONTRACTOR TO COORDINATE TYPE OF REPAIR WITH VA PRIOR TO COMMENCEMENT OF WORK AND TO ENSURE DEMO DOES NOT IMPACT OTHER NURSE CALL INDICATORS.
- 10 DEMO EXISTING ACCESS PANEL AND ASSOCIATED PIPING/CONDUIT BACK TO MAIN OR ELECTRICAL/DATA CLOSET. CONTRACTOR MAY NOT ABANDON IN PLACE.

DEMOLITION GENERAL NOTES

1. INFORMATION PERTAINING TO EXISTING PROJECT CONDITIONS, SUCH AS PRESENT LOCATIONS OF ARCHITECTURAL, STRUCTURAL BUILDING COMPONENTS, MECHANICAL AND ELECTRICAL EQUIPMENT, PIPING, DUCTWORK, ROUGH-INS AND OTHER MISCELLANEOUS CONSTRUCTION APPEARS ON THE DRAWINGS. WHILE SUCH INFORMATION HAS BEEN BASED ON AVAILABLE RECORDS AND COLLECTED WITH REASONABLE CARE, THE ARCHITECT AND ENGINEER DOES NOT ASSUME ANY EXPRESSED OR IMPLIED GUARANTEE THAT CONDITIONS SO INDICATED ARE SHOWN ENTIRELY COMPLETE, CORRECT AND REPRESENTATIVE OF THOSE ACTUALLY EXISTING. ALL CONTRACTORS SHALL SATISFY THEMSELVES AS TO ALL EXISTING JOB CONDITIONS PRIOR TO BIDDING, AND VERIFY ALL DIMENSIONS AT THE SITE.
2. REMOVE EXISTING CONSTRUCTION WITHIN PROJECT LIMITS AS INDICATED OR AS REQUIRED TO COMPLETE WORK.
3. CONTRACTOR SHALL VERIFY ALL EXISTING CONDITIONS AND DIMENSIONS PRIOR TO BEGINNING DEMOLITION OR CONSTRUCTION. CONTRACTOR SHALL REPORT ANY DISCREPANCIES TO THE RESIDENT ENGINEER PRIOR TO START OF DEMOLITION CONSTRUCTION ACTIVITIES.
4. THE CONTRACTOR SHALL NOTIFY THE RESIDENT ENGINEER PRIOR TO REMOVAL OF MATERIAL, FURNITURE, CASEWORK, OR EQUIPMENT NOT INDICATED ON THE DRAWINGS TO BE REMOVED.
5. SHOULD MATERIAL APPEARING TO CONTAIN ASBESTOS BE ENCOUNTERED DURING THE COURSE OF WORK, CONTRACTOR SHALL STOP WORKING INVOLVING SAID MATERIAL AND NOTIFY THE RESIDENT ENGINEER IMMEDIATELY.
6. UNLESS DIRECTED OTHERWISE, DISPOSE OF ALL ITEMS SHOWN TO BE DEMOLISHED.
7. WHERE PARTITION OR CEILING MOUNTED EQUIPMENT, NOT CALLED OUT FOR DEMOLITION IN ARCHITECTURAL, MECHANICAL, PLUMBING, OR ELECTRICAL DRAWINGS, IS ATTACHED TO PARTITIONS OR CEILINGS SCHEDULED FOR DEMOLITION, CONTRACTOR SHALL COORDINATE REMOVAL OF SAID EQUIPMENT WITH RESIDENT ENGINEER.
8. REFER TO MECHANICAL AND ELECTRICAL DRAWINGS FOR ADDITIONAL DEMOLITION NOTES. PATCH REPAIR SURFACES AS REQUIRED IN ASSOCIATED ELECTRICAL, DATA, AND PLUMBING WORK AND PREPARE TO RECEIVE NEW FINISH.
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10. THE CONTRACTOR SHALL BE RESPONSIBLE FOR PROTECTION OF EXISTING STRUCTURES, EQUIPMENT, AND FINISHES SURROUNDING THE AREA OF WORK. DAMAGE TO EXISTING STRUCTURES, PAVEMENT/GRADES, EQUIPMENT OR FINISHES SHALL BE REPAIRED OR REPLACED AT NO ADDITIONAL COST TO THE OWNER. REPAIR AND REPLACEMENT SHALL MATCH ADJACENT MATERIALS. EXTEND REPAIR AND REPLACEMENT TO BREAK IN PLAN OR FIRST MATERIAL JOINT BEYOND DAMAGE.
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14. ALL WORK MUST BE COORDINATED WITH THE RESIDENT ENGINEER TO NOT ADVERSELY AFFECT OPERATIONS OUTSIDE OF THE WORK AREA. TEMPORARY 1-HOUR FIRE RATED CONSTRUCTION PARTITIONS WILL BE REQUIRED WHEN WORK AREA EXTENDS INTO AND AFFECTS EXISTING FACILITY OPERATIONS. NO WORK SHALL BE STARTED WHICH AFFECTS EXISTING FACILITY OPERATIONS WITHOUT PRIOR COORDINATION AND APPROVAL OF THE WORK WITH THE RESIDENT ENGINEER.
15. FLOOR SURFACES DAMAGED OR BENEATH EXISTING CASEWORK TO BE PATCHED AND PREPARED TO MATCH SURROUNDING FLOOR SURFACES.
16. DEMOLITION WORK CAUSING VIBRATION AND/OR LOUD NOISE DISRUPTIVE TO HOSPITAL FUNCTIONS AS DEEMED BY THE OWNER SHALL BE SCHEDULED TO BE DONE AFTER HOURS. AFTER HOURS IS DEFINED AS BETWEEN 6:00 PM AND 5:00 AM - RETURN NON-PROJECT AREAS TO HOSPITAL LEVEL CLEANLINESS BEFORE 6:00 AM.
17. PATCH CONCRETE FLOOR PENETRATIONS FOR ALL DEMOLISHED PLUMBING FIXTURES, CUT EXISTING CONCRETE FLOOR AS NECESSARY TO ACCOMMODATE NEW PIPING, CONDUIT OR OTHER WORK. PATCH BACK TO MATCH SURROUNDING SURFACES AT CORNERS - DRILL WITH ROTARY HAMMER, DO NOT OVER SCORE CONCRETE TO BE CUT.
18. WHERE REMOVAL OF EXISTING CONSTRUCTION DISRUPTS EXISTING ELECTRICAL, MECHANICAL, AND PLUMBING SERVICES, MAKE PERMANENT (OR TEMPORARY) CONNECTIONS TO RESTORE AFFECTED SERVICES TO AREAS NOT SCHEDULED FOR DEMOLITION AND REMODELING. WHERE TEMPORARY CONNECTION ARE PROVIDED, RESTORE PERMANENT SERVICE PRIOR TO PROJECT COMPLETION.
19. CONTRACTOR SHALL INSURE THAT ALL FINISHED OR UNFINISHED WALL AND FLOOR AREAS, PATH OF TRAVEL, ACCESSIBLE TO THE PUBLIC DURING BUSINESS HOURS ARE CLEAN, DRY, FREE OF DEBRIS AND GLUE, AND SUITABLE FOR USE.
20. IN KEY NOTES, "REMOVE" MEANS REMOVE, HAUL AWAY, AND DISPOSE OF IN ACCORDANCE WITH APPLICABLE LAWS AND REGULATIONS. REFER ALSO TO SECTION 01 74 19 CONSTRUCTION WASTE MANAGEMENT.
21. ALL WORK SHALL COMPLY WITH THE REQUIREMENTS OF NATIONAL AND LOCAL CODES, WHICHEVER IS MORE STRINGENT.
22. CONTRACTOR SHALL COORDINATE MATERIAL STORAGE WITH THE RESIDENT ENGINEER.
23. CONTRACTOR SHALL PROVIDE FIRE PROTECTION EQUIPMENT (FIRE EXTINGUISHERS, ETC.) AND INSPECT THEM MONTHLY AS REQUIRED DURING DEMOLITION AND NEW CONSTRUCTION WORK.
24. CONTRACTOR SHALL PROVIDE TEMPORARY SEAL AT ALL DOOR AND WALL OPENINGS AT PERIMETER WALLS DURING DEMOLITION AND NEW CONSTRUCTION WORK TO PROTECT ADJACENT AREAS FROM DUST INTRUSION.
25. VERIFY FIELD DIMENSIONS, COORDINATE ACTUAL DIMENSIONS WITH OWNER'S REPRESENTATIVE. GENERAL CONTRACTOR TO SUBMIT CONCRETE & STEEL SHOP DRAWINGS INDICATING ACTUAL FIELD DIMENSIONS, CONTRACTOR RESPONSIBLE TO DIMENSION OF STRUCTURE TO FIT EXISTING CONDITIONS.
26. CONTRACTOR RESPONSIBLE TO ABATE ALL ASBESTOS CONTAINING MATERIALS IN AREA OF WORK.
27. REMOVE EXISTING LIGHTING, POWER AND DATA BACK TO J-BOX INCLUDE SWITCHES, WIRING, ETC. & PREP FOR NEW LIGHTING-COORDINATED WITH ELECTRICAL CONTRACTOR

KEY PLAN

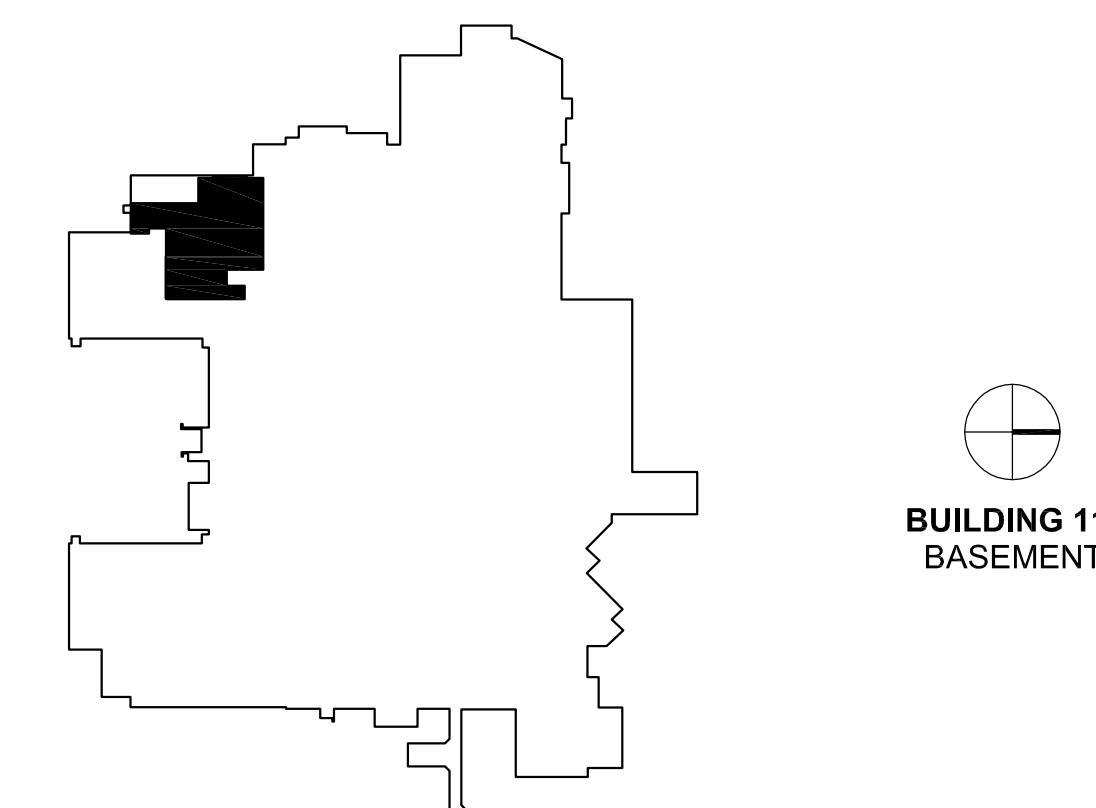

BUILDING 111
BASEMENT



ARCHITECT:

CLEMENT J. ZABLOCKI VA MEDICAL CENTER
OFFICE OF CONSTRUCTION AND FACILITIES MANAGEMENT

Drawing Title

PHASE 1 - 3: DEMOLITION
REFLECTED CEILING PLANS

Approved: Project Director

Troy Martinson, PE

Project Title

111 Upgrade Pool Locker
Rooms

Location

VA Medical Center, Milwaukee, WI

Date

August 28, 2015

Checked

Drawn

AJ

Project Number

695-14-114

Building Number

Building 111

Drawing Number

AD-301

Office of
Construction
and Facilities
Management

Department of
Veterans Affairs

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PLAN KEY NOTES

- 1 PROVIDE NEW ROOM SIGNAGE TO MATCH EXISTING. SEE SHEET A-000.
- 2 PROVIDE NEW DOOR AND HARDWARE PER DOOR/FRAME SCHEDULE. SEE SHEET A-000.
- 3 CONSTRUCT TEMPORARY 1 HOUR RATED WALL TO SERVE AS CONSTRUCTION BARRIER FOR PHASE 3.
- 4 IN-FILL EXISTING DOOR OPENING WITH SAME CONSTRUCTION TYPE AND ALIGN NEW WALL ON BOTH SIDES. PREPARE WALL TO RECEIVE NEW FINISHES. SEE SHEET ID-101.
- 5 RELOCATE AND INSTALL EXISTING TILE WALL AND BASE TO MATCH EXISTING CONDITIONS.
- 6 PROVIDE REQUIRED BACKING FOR ADA WALL MOUNTED GRAB BARS.
- 7 PROVIDE (1) GFI DUPLEX OUTLET ABOVE FINISHED MILLWORK. SEE SHEET ID-102 FOR LOCATION. CONTRACTOR TO COORDINATE PRECISE LOCATION WITH MILLWORK PRIOR TO INSTALLATION.
- 8 PROVIDE 6" DIAMETER CUT OUT IN STAINLESS STEEL COUNTER FOR UNDER COUNTER MOUNTED TRASH CAN. CONTRACTOR TO COORDINATE WORK WITH MILL-WORKER PRIOR TO INSTALLATION. CONTRACTOR TO PROVIDE FINISHED GROMMET COVER.
- 9 PROVIDE AUTOMATIC DOOR OPENER ON BOTH PUSH AND PULL SIDE. SEE DOOR SCHEDULE ON SHEET A-000.
- 10 PROVIDE NURSE CALL BUTTON. SEE SHEET ID-102 FOR PRECISE LOCATION.
- 11 SLOPE FINISHED TILE FLOOR BY 1% TOWARDS LINEAR DRAIN AS DESCRIBED IN MANUFACTURES SPECIFICATIONS FOR ADA ACCESSIBLE SHOWERS.
- 12 PROVIDE PLUMBING FIXTURES AND ASSOCIATED PIPING. SEE FINISH SCHEDULE SHEET P-101.
- 13 PROVIDE TEMPORARY MAGNETIC SIGNAGE TO CHANGE OCCUPANCY USE WHILE PHASES ARE IN CONSTRUCTION. SEE SHEET A-000.
- 14 POINT OF TRANSITION OF FLOOR SLOPE PER KEY NOTE #11.
- 15 FUR OUT ALL EXISTING WALLS TO REMAIN WITH ONE LAYER OF THE APPROPRIATE TYPE OF GYPSUM BOARD. ENSURE ALL WALLS ARE PREPARED TO RECEIVE NEW FINISHES AS INDICATED ON THE FINISH SCHEDULE.
- 16 EXISTING TILE TO REMAIN. CONTRACTOR SHALL PROTECT TO ENSURE DAMAGE DOES NOT OCCUR.


GENERAL NOTES

1. REFER TO DETAIL PLANS FOR ADDITIONAL PARTITION INFORMATION, SEE SHEET A-000.
2. INTERIOR DIMENSIONS ARE TO FINISH FACE TO FACE U.N.O.
3. INSTALL 5/8" TYPE X GYPSUM WALL BOARD AND ACOUSTICAL INSULATION IN ALL ROOMS, FINISH TO GRADE #5.
4. ALL SWITCHES, THERMOSTATS, AND OTHER ENVIRONMENTAL CONTROLS SHALL BE MOUNTED AT 40" AFF. TELEPHONE AND POWER OUTLETS SHALL BE AT 18" AFF. THESE CONTROLS SHALL BE LINED UP AT THE SAME HEIGHT AND WHERE MORE THAN ONE ARE ADJACENT, THEY SHALL BE EVENLY SPACED. GROUP MULTIPLE DEVICES IN A SINGLE COVER PLATE WHERE POSSIBLE.
5. VERIFY ALL UTILITIES AND CONNECTION LOCATIONS.
6. ALL PENETRATIONS IN RATED WALLS, SHALL BE RATED, TESTED ASSEMBLIES AS REQUIRED BY CODE.
7. SEAL ALL PENETRATIONS IN SMOKE BARRIERS IN ACCORDANCE WITH CODES AND REQUIREMENTS.
8. CONTRACTOR SHALL VERIFY ALL EXISTING CONDITIONS AND DIMENSIONS PRIOR TO BEGINNING CONSTRUCTION.
9. CORNER GUARDS ARE REQUIRED AT ALL OUTSIDE CORNERS, SOME LOCATIONS MAY NOT BE INDICATED ON DRAWINGS. SEE SHEET ID-101.
10. REPLACE DOORS, LOCKS, KICK PLATES, CLOSER, BUMPER GUARDS, DOOR STOPS, AND HARDWARE, SEE SHEET A-000. RESTORE DOOR FRAME TO SMOOTH FINISH AND REPAINT.
11. ALL WALL HUNG CASEWORK, SHELVING AND EQUIPMENT ATTACHED TO WALLS SHALL BE ANCHORED BETWEEN STUDS.
12. REFER TO INTERIOR FLOOR FINISH PLAN, SHEET ID-101.
13. REFER TO INTERIOR WALL FINISH PLAN, SHEET ID-101.
14. REFER TO INTERIOR SIGNAGE PLAN, SHEET A-000.
15. VERIFY FIELD DIMENSIONS, COORDINATE ACTUAL DIMENSIONS WITH CONTRACTOR AND VA.
16. SUBMIT CONCRETE AND STEEL SHOP DRAWINGS INDICATING ACTUAL, FILED DIMENSIONS, CONTRACTOR RESPONSIBLE TO DIMENSION OF STRUCTURE TO FIT EXISTING CONDITIONS.
17. WALL TYPES SEE A-000
18. DIMENSIONS ON FLOOR PLAN ARE BASED ON FACE OF FINISHED WALL TO FACE OF FINISHED WALL (NOMINAL), U.N.O.
19. VERIFY ALL DIMENSIONS AND CONDITIONS AT JOB SITE. PORTIONS OF EXISTING CONSTRUCTION MAY HAVE BEEN REMOVED BY OWNER.
20. MAINTAIN CONTINUOUS UTILITY SERVICE TO ALL SPACES IN THE BUILDING NOT AFFECTED BY THIS WORK. COORDINATE WITH OWNER ANY DISRUPTION IN SERVICES REQUIRED TO PERFORM WORK OR TO MODIFY EXISTING PIPING, DUCTWORK OR ANY ASSOCIATED EQUIPMENT.
21. REFER TO SHEET ID-101 AND ID-102 FOR FINISH SCHEDULE AND FINISH MATERIALS.
22. REFER TO SHEET A-000 FOR DOOR SCHEDULE, DOOR TYPES, HARDWARE AND NOTES.

GRAPHIC LEGEND

| | | | |
|--|---|--|---|
| | EXISTING WALL TO REMAIN | | PLAN KEY NOTE |
| | EXISTING DOOR TO REMAIN | | PARTITION TYPE |
| | INFECTION CONTROL/CONSTRUCTION BARRIER WALL (FC/CB) | | INTERIOR ELEVATION |
| | NEW WALL/PARTITION | | NEW DOOR |
| | NEW WALL OR CEILING MOUNTED NURSE CALL BUTTON | | NEW WALL MOUNTED ADA AUTOMATIC DOOR OPENER PUSH PLATE - EXACT LOCATION DURING MEP OUTLET BOX WALK-THROUGH |
| | NEW SWITCH | | NEW IVORY RECEPTACLE, DUPLEX WITH GROUND FAULT CIRCUIT INTERRUPTER, HOSPITAL GRADE |

KEY PLAN

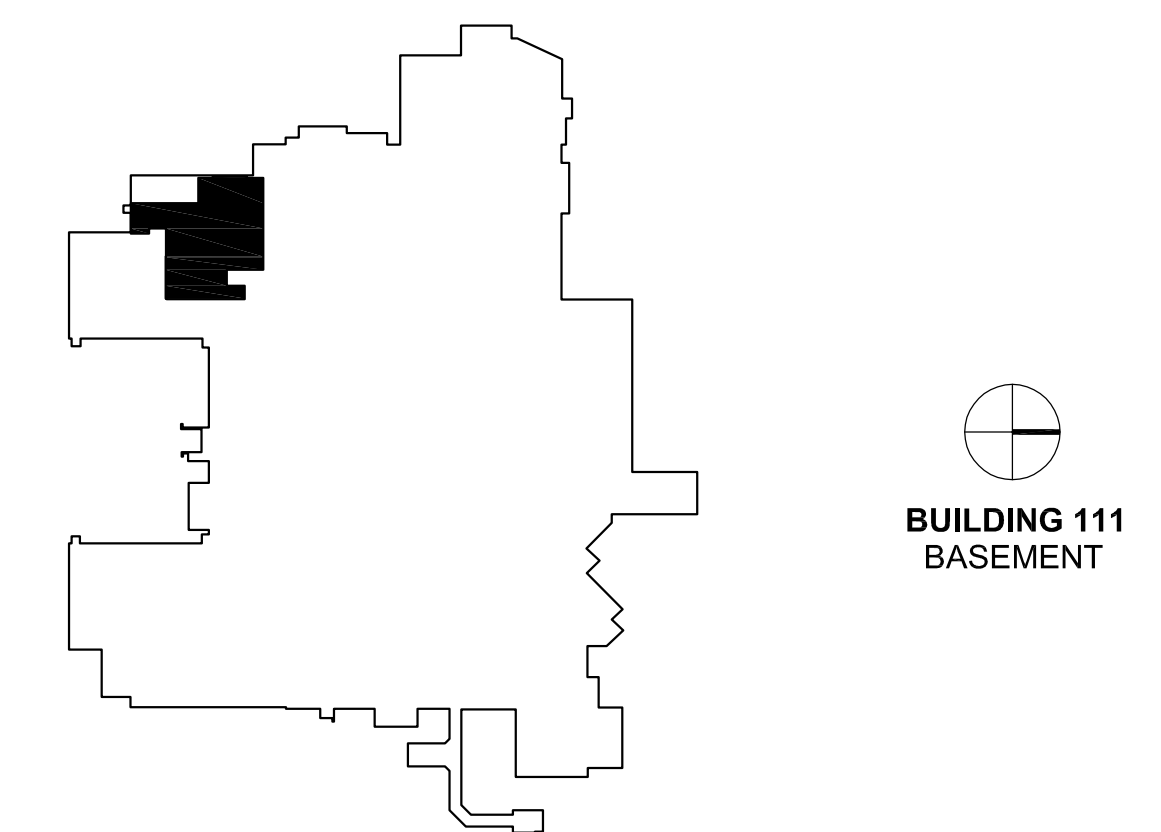

BUILDING 111
BASEMENT

| | | | |
|--|---|--|---|
| Drawing Title PHASE 1 - 3: FLOOR PLANS | Project Title 111 Upgrade Pool Locker Rooms | Project Number 695-14-114 | Office of Construction and Facilities Management |
| Approved: Project Director Troy Martinson, PE | Location VA Medical Center, Milwaukee, WI | Building Number Building 111 | |
| | Date August 28, 2015 | Checked AJ | |
| | | Drawing Number A-101 | |

| | | | | | | | | |
|-----------|------|--|---|---|--|---|-------------------------------------|---|
| Revisions | Date | | Dept. of Veterans Affairs Medical Center 5000 W. National Avenue Milwaukee, WI | ARCHITECT: CLEMENT J. ZABLOCKI VA MEDICAL CENTER OFFICE OF CONSTRUCTION AND FACILITIES MANAGEMENT | Drawing Title PHASE 1 - 3: FLOOR PLANS | Project Title 111 Upgrade Pool Locker Rooms | Project Number 695-14-114 | Office of Construction and Facilities Management |
| | | | | | | | | |

A

three inches = one foot

B

one and one half inches = one foot

C

one inch = one foot

D

three quarters inch = one foot

E

three quarters inch = one foot

F

one half inch = one foot

G

one half inch = one foot

H

one eighth inch = one foot

I

three eighths inch = one foot

J


one quarter inch = one foot

K


one eighth inch = one foot

L


one eighth inch = one foot

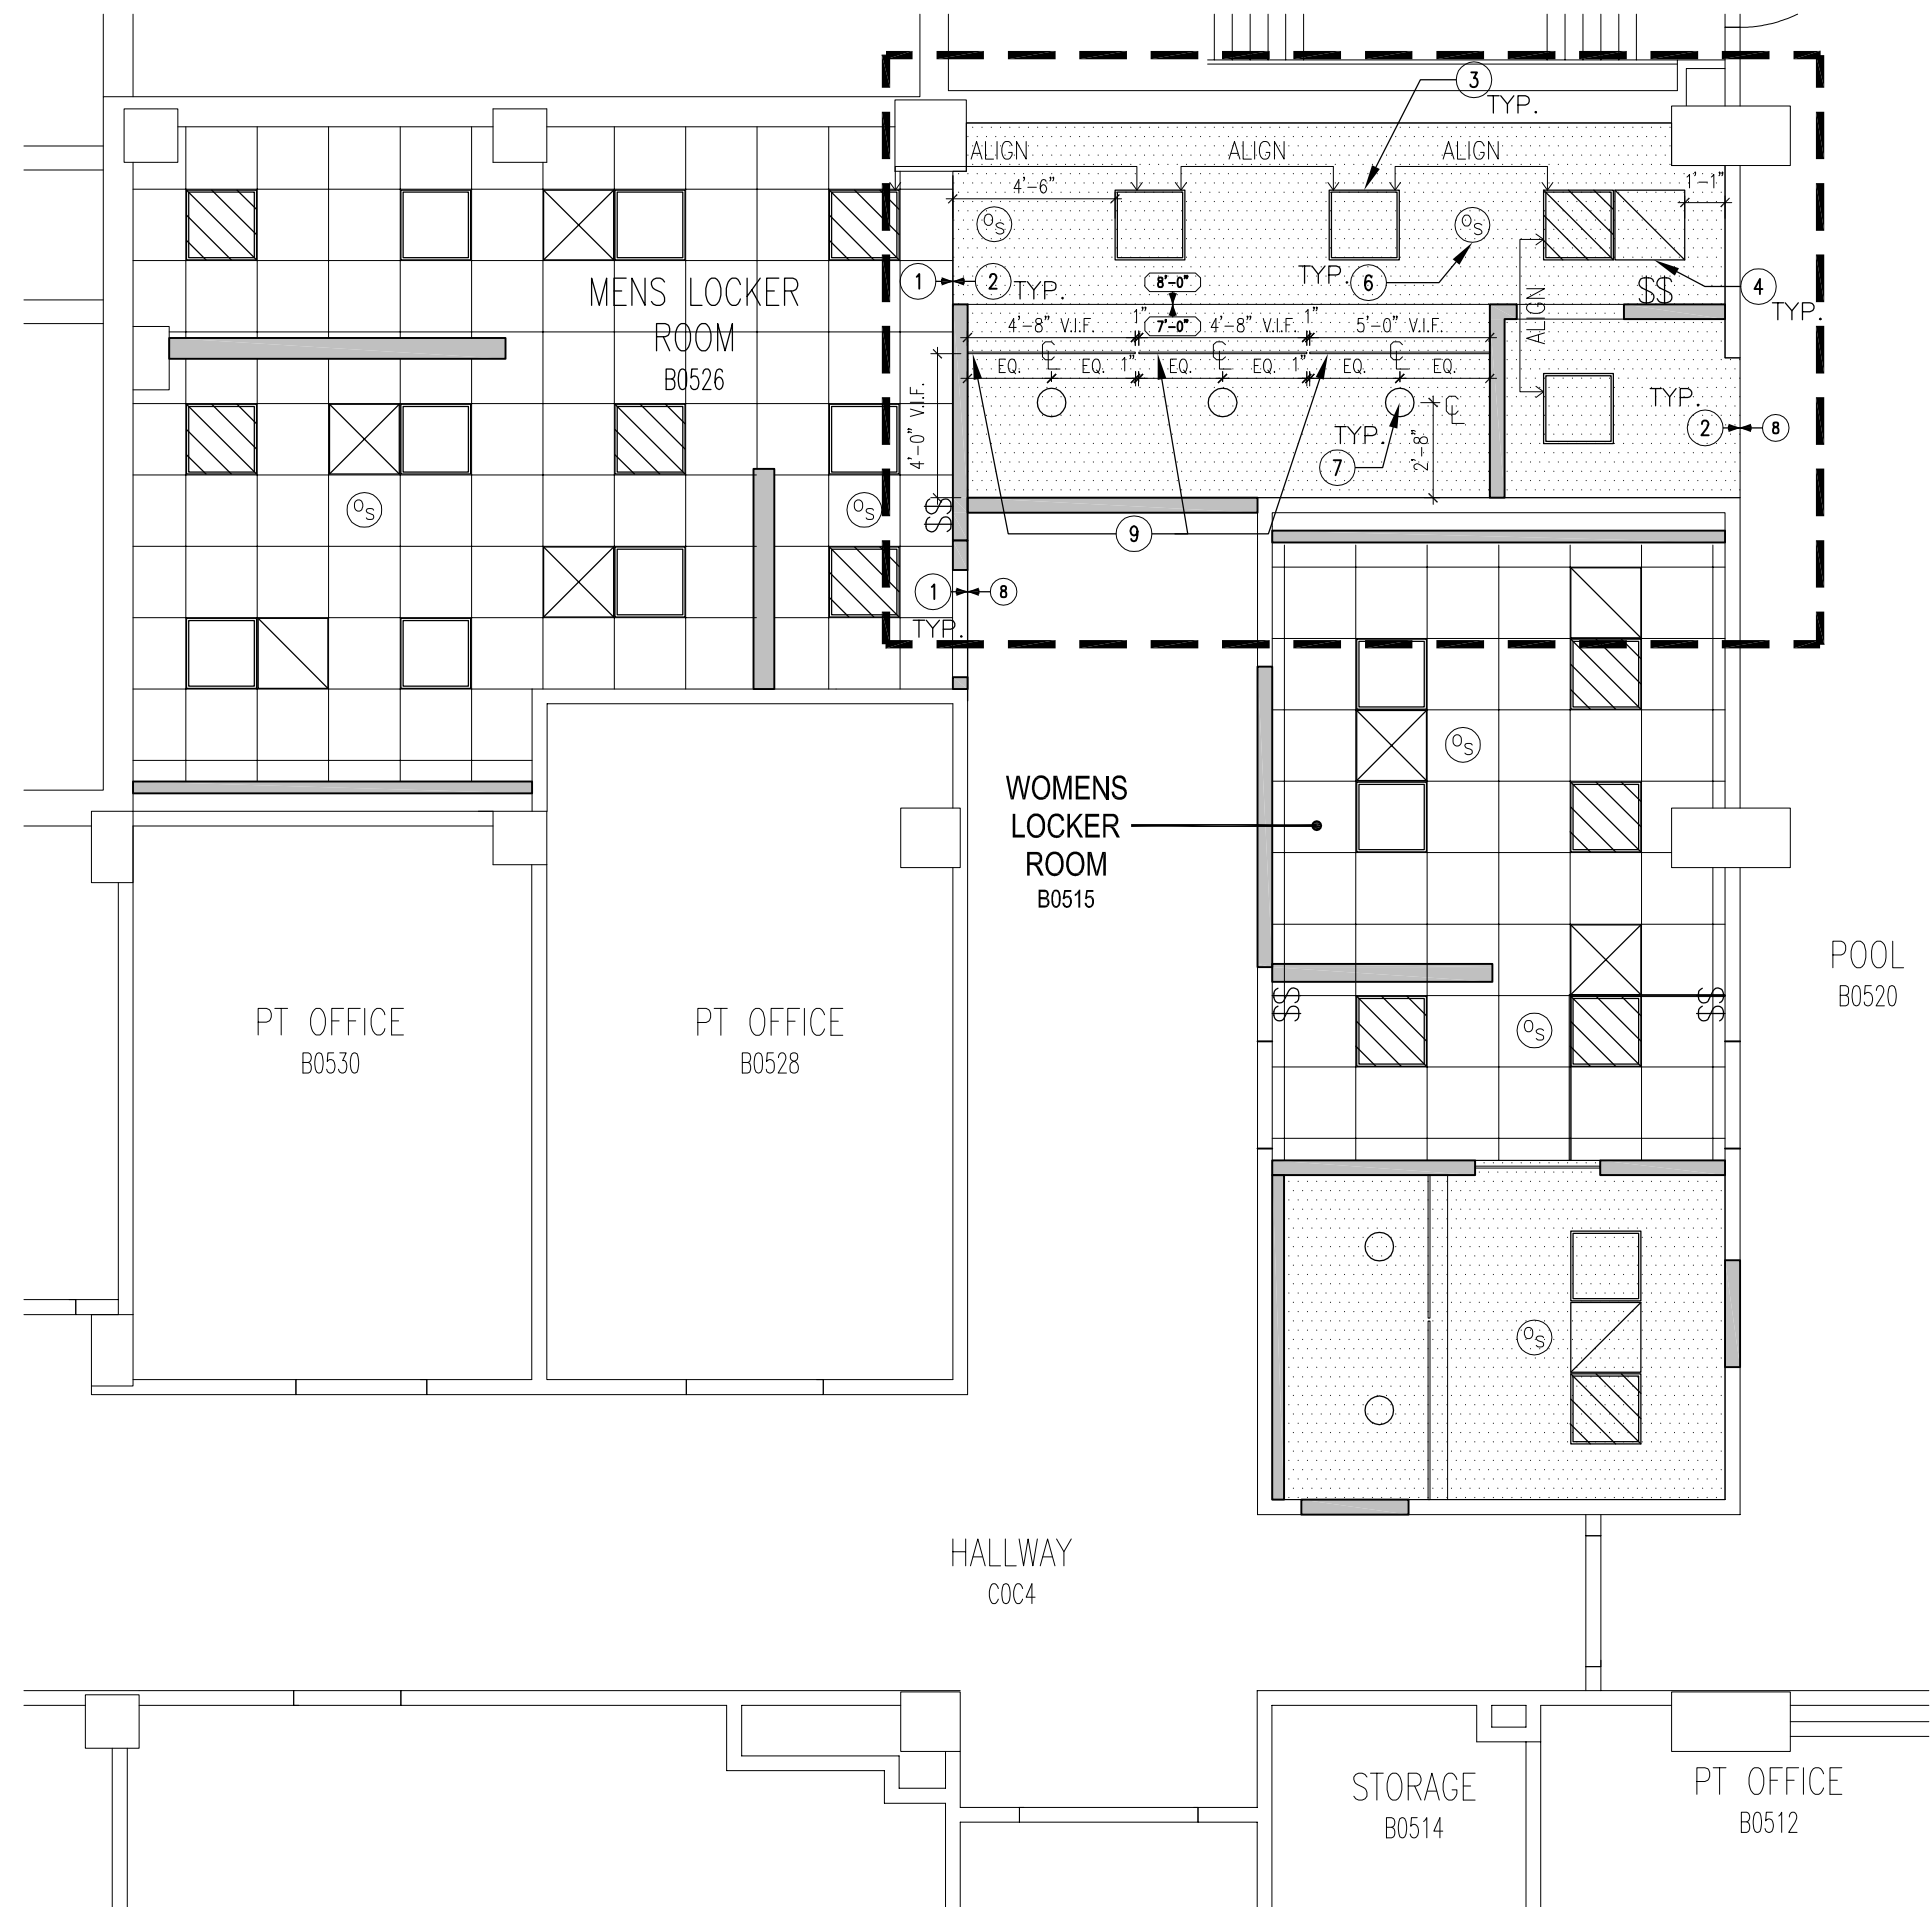

3 REFLECTED CEILING PLAN - PHASE 3
3/16" = 1'-0"

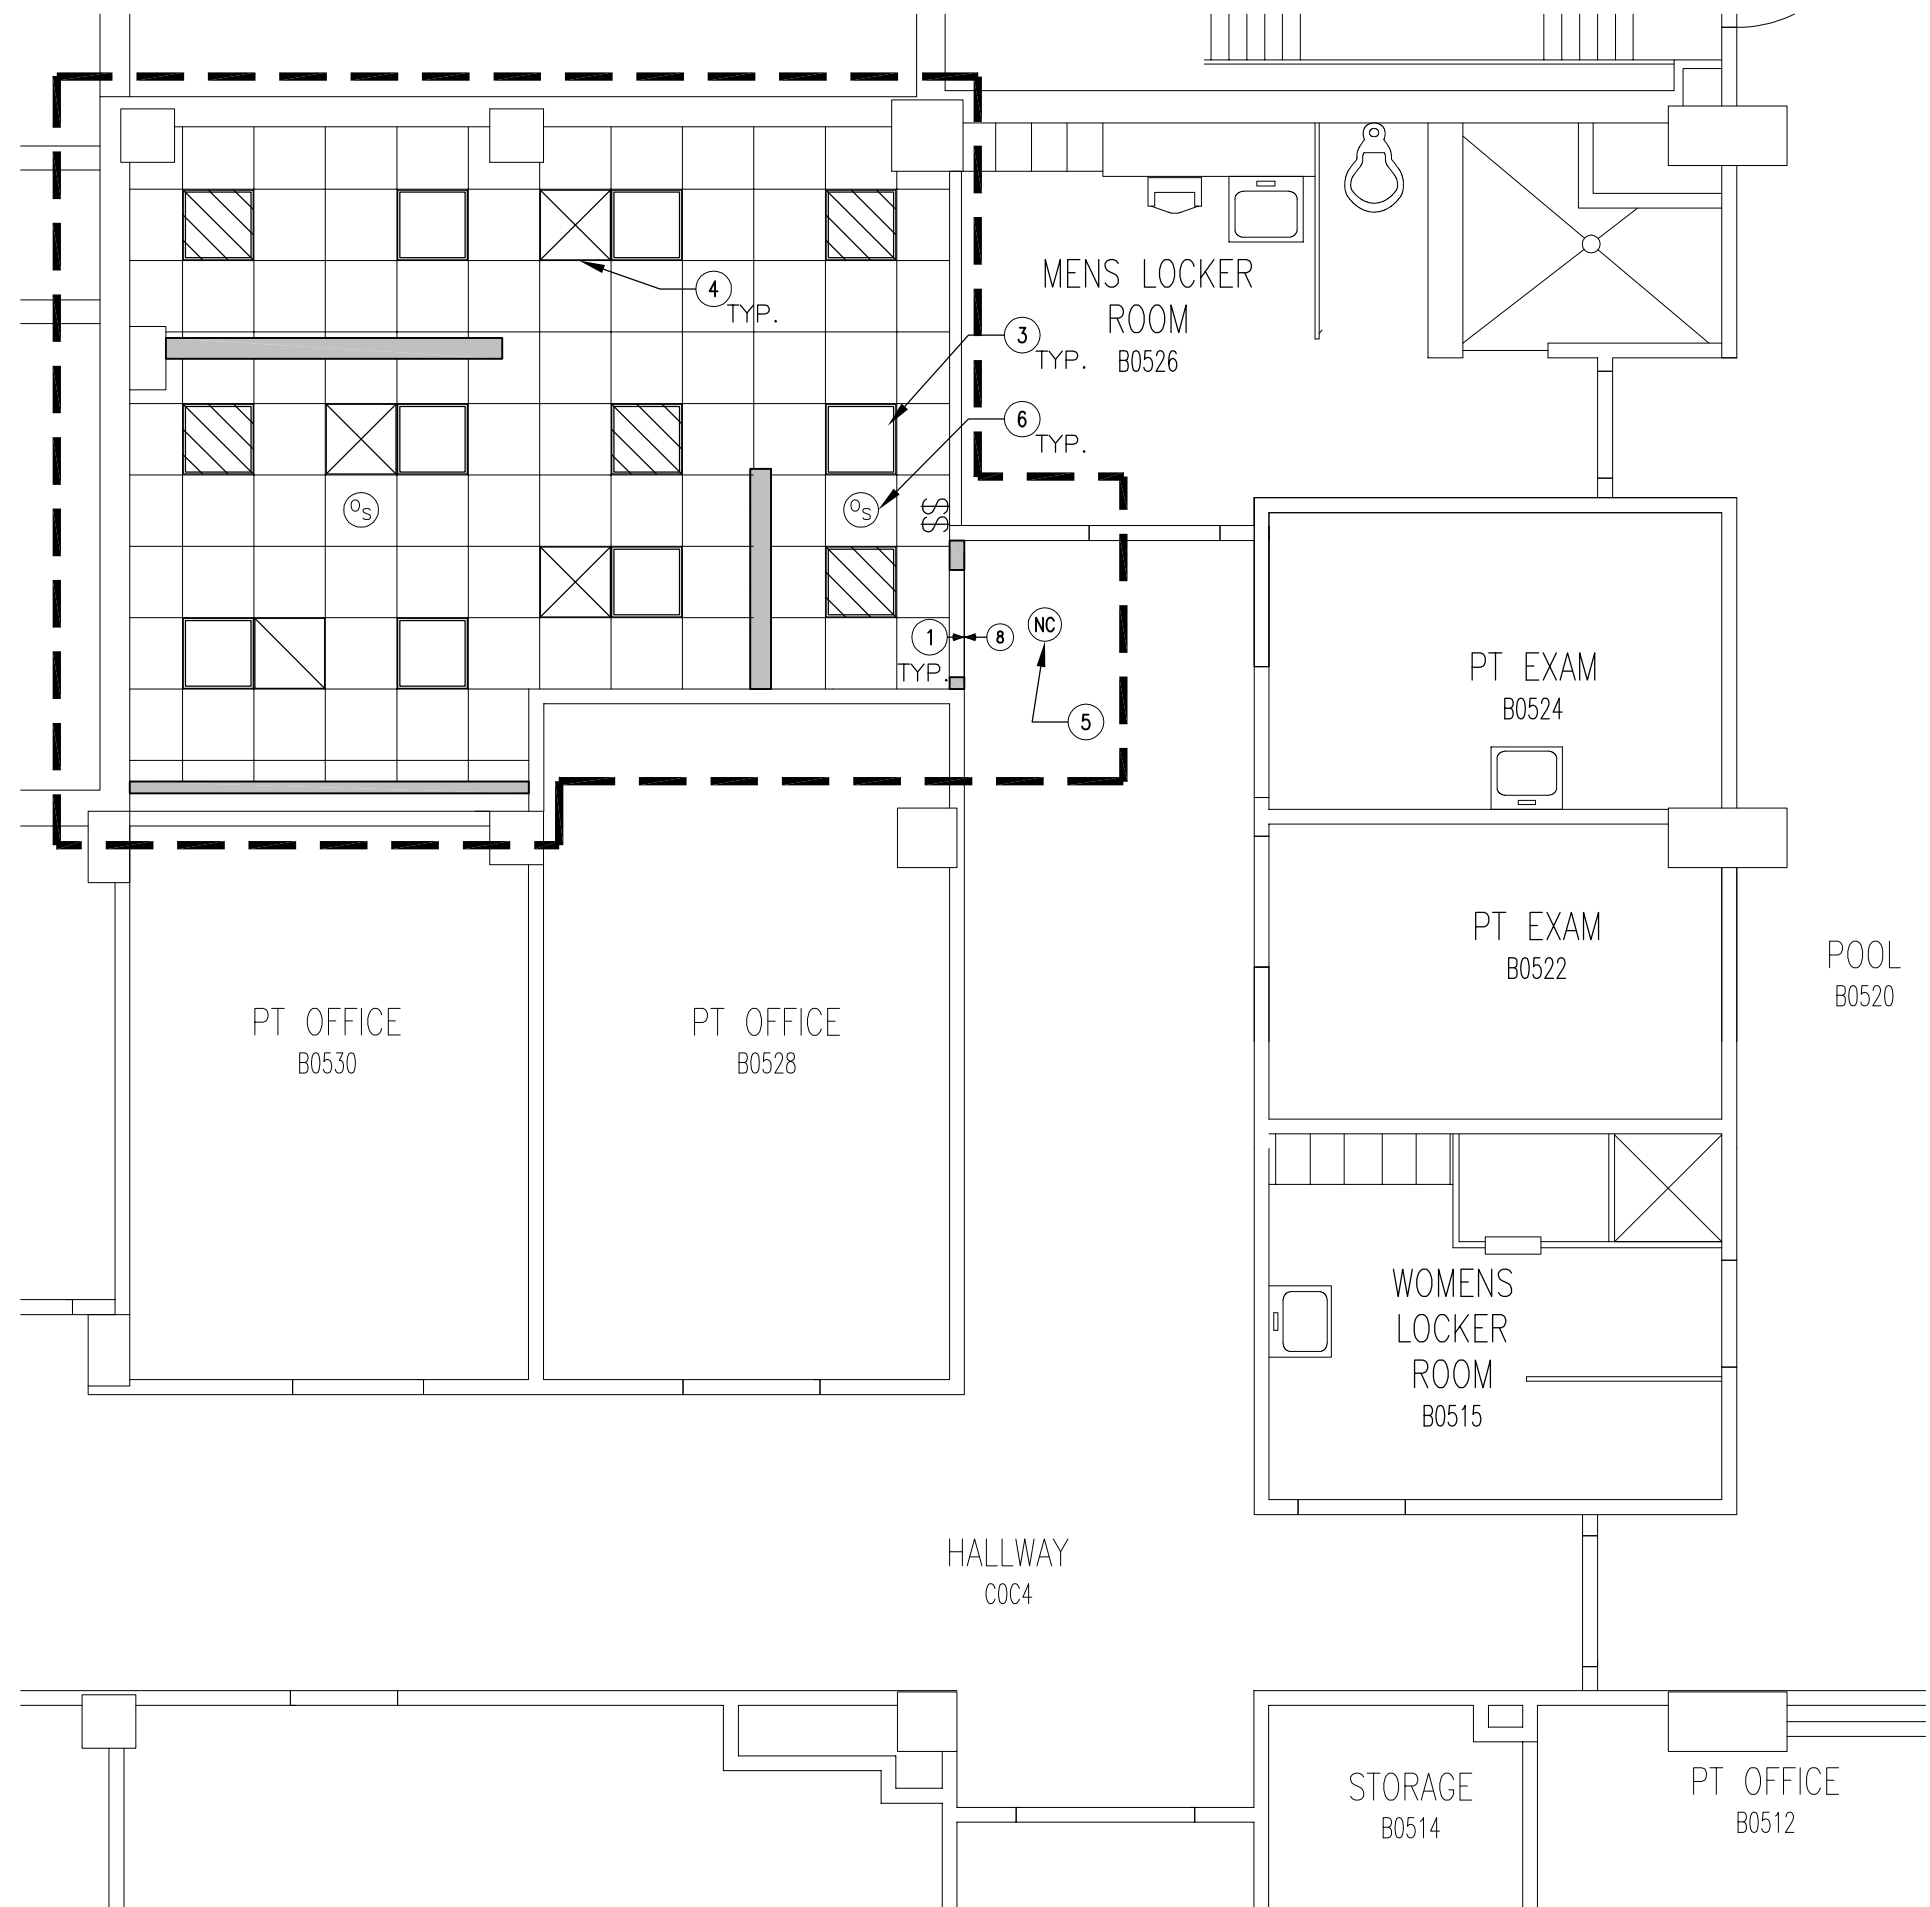

1 REFLECTED CEILING PLAN - PHASE 1
3/16" = 1'-0"

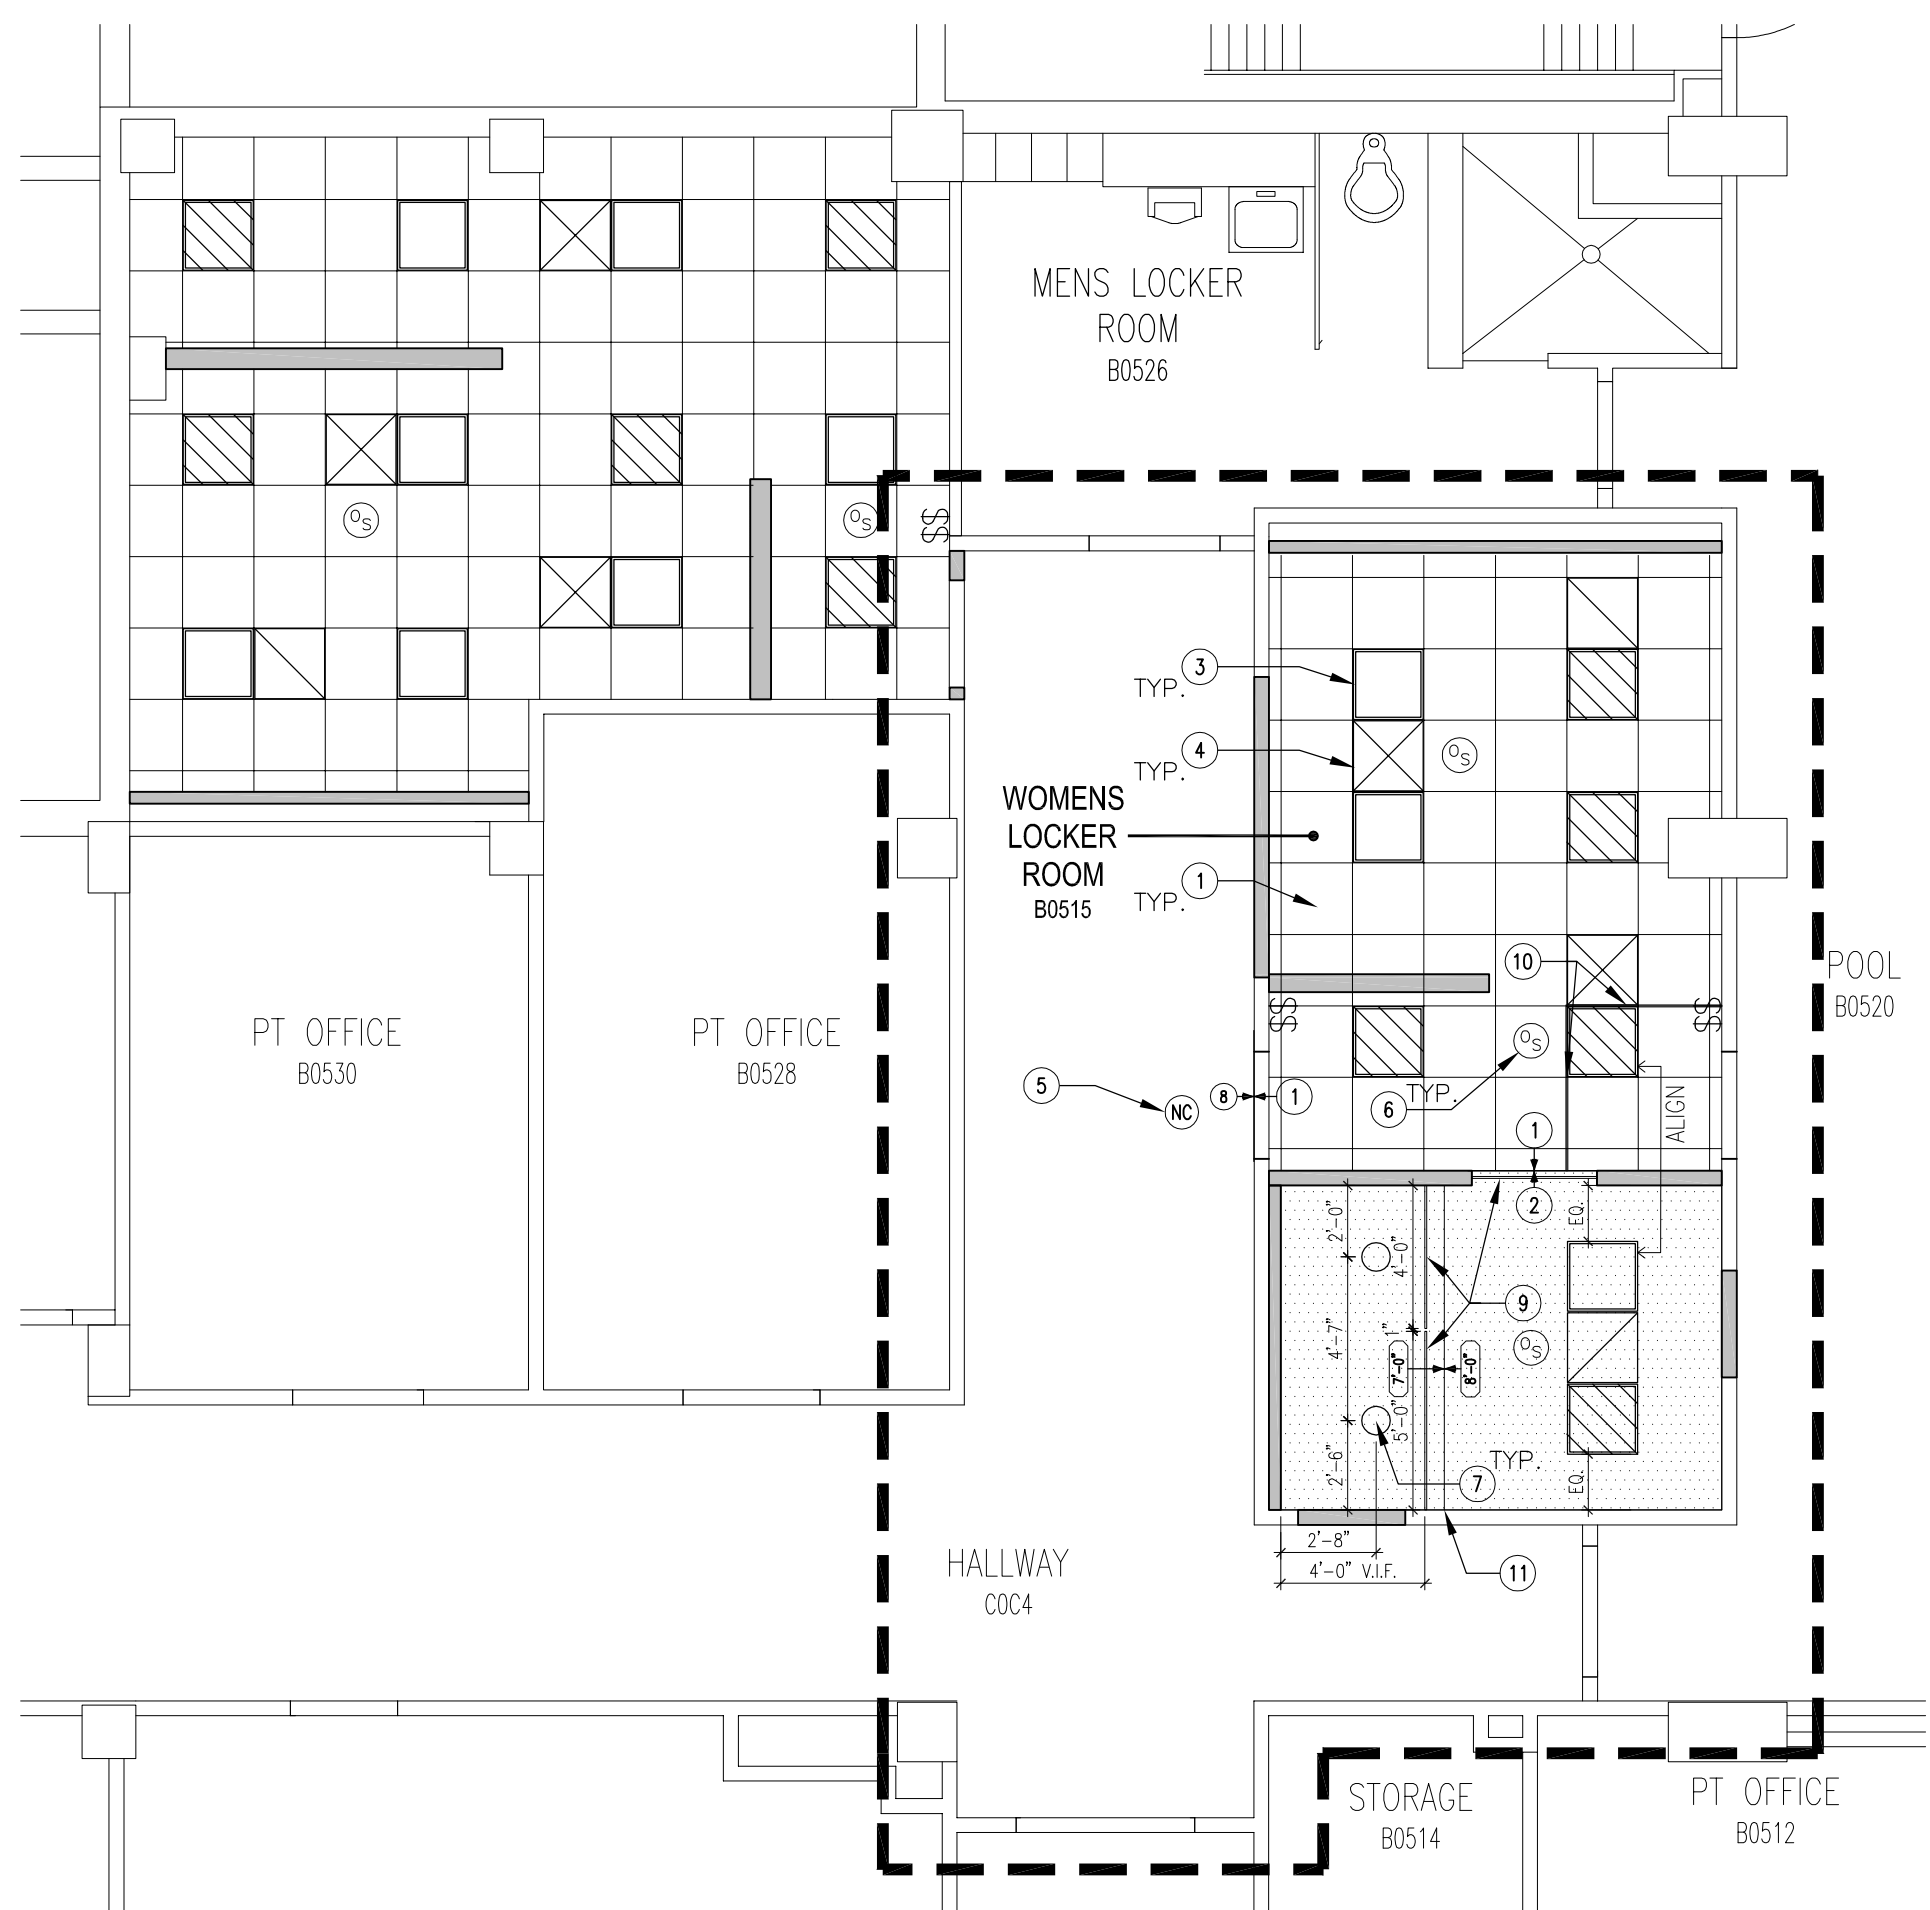

2 REFLECTED CEILING PLAN - PHASE 2
3/16" = 1'-0"

REFLECTED CEILING PLAN GENERAL NOTES

- PERIMETER CEILING TILES SHALL NOT BE LESS THAN 4".
- LOCATE ALL SPRINKLER HEADS, SMOKE DETECTORS, HEAT SENSORS IN THE CENTER OF CEILING TILE (OR IN THE CENTER OF A RAISED/RECESSED FIELD OF PATTERNED TILE).
- CEILING HEIGHT SHALL BE 8'-0" U.N.O. REFER TO SHEET ID-102 FOR INTERIOR ELEVATIONS.
- THE REFLECTED CEILING PLAN (RCP) MAY NOT INDICATE ALL CEILING MOUNTED DEVICES AND FIXTURES.

HVAC GENERAL NOTES

- EXHAUST 10 AIR CHANGES PER HOUR FOR LOCKER ROOMS.
- CONNECT TO EXISTING EXHAUST FANS.
- FIELD VERIFY DURING SCOPE WALK-THRU EXISTING LOCATIONS OF DUCTS.
- TEST AND BALANCE HVAC AS REQUIRED.
- HVAC IS A DESIGN BUILD PROJECT. SUPPLY AND RETURN REGISTERS ARE GRAPHICALLY SHOWN TO DEPICT IDEAL LOCATION. PRIOR TO INSTALLATION OF SUPPLY AND RETURN REGISTERS COORDINATE ALL WORK WITH VA PRIOR TO INSTALLATION.

ELECTRICAL GENERAL NOTES

- PROVIDE ALL NEW WIRING, SWITCHES, RECEPTACLES, CONDUIT, J-BOXES, ITEMS MAY BE REUSED IF THEY MEET CODE AND ARE IN GOOD CONDITION.
- COORDINATE WITH VA FOR LOCATION OF POWER PANELS.
- CONTRACTOR IS RESPONSIBLE FOR LOWERING ALL FIRE DETECTION SYSTEMS AND OTHER OPERATIONAL SYSTEMS TO THE NEW ACT OR GYPSUM BOARD CEILINGS.
- CONTRACTOR TO PROVIDE ELECTRICAL AND FIRE ALARM TIE IN TO DOORS ON MAGNETIC HOLD OPEN - SEE DOOR SCHEDULE SHEET A-000. ALL WIRING TO BE FINISHED IN DRYWALL WALLS.

PLAN KEY NOTES

- PROVIDE NEW ALUMINUM/MOISTURE RESISTIVE CEILING GRID AND TILES. CEILING GRID SHALL BE CONTINUOUS AND CENTERED WITHIN ROOM. SEE SHEET ID-101 FOR SPECIFICATIONS.
- PROVIDE NEW MOISTURE RESISTIVE GYPSUM BOARD CEILING.
- PROVIDE NEW LIGHT FIXTURES. SEE SHEET E-301 FOR FIXTURE SCHEDULE.
- PROVIDE NEW ALUMINUM SUPPLY AND ALUMINUM RETURN AIR REGISTERS.
- PROVIDE NEW NURSE CALL INDICATOR CENTERED ABOVE DOOR ON CORRIDOR SIDE. COORDINATE PRECISE LOCATION WITH VA PRIOR TO INSTALLATION.
- PROVIDE NEW OCCUPANCY SENSOR.
- PROVIDE NEW ROUND RECESSED LIGHT FIXTURE CENTERED ABOVE EACH SHOWER ENCLOSURE. COORDINATE PRECISE LOCATION WITH VA PRIOR TO INSTALLATION. REFER TO SHEET E-301 FOR FIXTURE SCHEDULE.
- EXISTING TO REMAIN.
- INSTALL CEILING MOUNTED CURTAIN ROD TRACK WITH CURTAIN TRACK FLUSH IN GYPSUM BOARD CEILING. CURTAIN ROD TRACK SHALL BE WITHIN 2" FROM FINISHED EDGE OF CEILING AT HEIGHT TRANSITION FROM 7'-0" A.F.F. TO 8'-0" A.F.F. CEILING MOUNTED CURTAIN ROD TRACK SHALL NOT BE CONTINUOUS AND SHALL BE CENTERED BETWEEN EACH SHOWER STALL. CONTRACTOR TO COORDINATE PRECISE LOCATION WITH VA PRIOR TO INSTALLATION. SEE FINISH SCHEDULE ON SHEET A-000.
- INSTALL CONTINUOUS CEILING MOUNTED CURTAIN ROD TRACK WITH CURTAIN ALONG CEILING GRID. SEE FINISH SCHEDULE ON SHEET ID-101. CONTRACTOR TO COORDINATE PRECISE LOCATION WITH VA PRIOR TO INSTALLATION.
- TRANSITION OF CEILING HEIGHT SHALL ALIGN WITH FLOOR TRANSITION. CONTRACTOR TO COORDINATE ALIGNMENT OF TRANSITIONS.


GENERAL NOTES

- REFER TO DETAIL PLANS FOR ADDITIONAL PARTITION INFORMATION, SEE SHEET A-000.
- INTERIOR DIMENSIONS ARE TO FINISH FACE TO FACE U.N.O.
- INSTALL 5/8" TYPE X GYPSUM WALL BOARD AND ACOUSTICAL INSULATION IN ALL ROOMS, FINISH TO GRADE #5.
- ALL SWITCHES, THERMOSTATS, AND OTHER ENVIRONMENTAL CONTROLS SHALL BE MOUNTED AT 40" AFF. TELEPHONE AND POWER OUTLETS SHALL BE AT 18" AFF. THESE CONTROLS SHALL BE LINED UP AT THE SAME HEIGHT AND WHERE MORE THAN ONE ARE ADJACENT, THEY SHALL BE EVENLY SPACED. GROUP MULTIPLE DEVICES IN A SINGLE COVER PLATE WHERE POSSIBLE.
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- CONTRACTOR SHALL VERIFY ALL EXISTING CONDITIONS AND DIMENSIONS PRIOR TO BEGINNING CONSTRUCTION.
- CORNER GUARDS ARE REQUIRED AT ALL OUTSIDE CORNERS, SOME LOCATIONS MAY NOT BE INDICATED ON DRAWINGS. SEE SHEET ID-101.
- REPLACE DOORS, LOCKS, KICK PLATES, CLOSER, BUMPER GUARDS, DOOR STOPS, AND HARDWARE, SEE SHEET A-000. RESTORE DOOR FRAME TO SMOOTH FINISH AND REPAINT.
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- REFER TO INTERIOR FLOOR FINISH PLAN, SHEET ID-101.
- REFER TO INTERIOR WALL FINISH PLAN, SHEET ID-101.
- REFER TO INTERIOR SIGNAGE PLAN, SHEET A-000.
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- SUBMIT CONCRETE AND STEEL SHOP DRAWINGS INDICATING ACTUAL FILED DIMENSIONS, CONTRACTOR RESPONSIBLE TO DIMENSION OF STRUCTURE TO FIT EXISTING CONDITIONS.
- WALL TYPES SEE A-000
- DIMENSIONS ON FLOOR PLAN ARE BASED ON FACE OF FINISHED WALL TO FACE OF FINISHED WALL (NOMINAL), U.N.O.
- VERIFY ALL DIMENSIONS AND CONDITIONS AT JOB SITE. PORTIONS OF EXISTING CONSTRUCTION MAY HAVE BEEN REMOVED BY OWNER.
- MAINTAIN CONTINUOUS UTILITY SERVICE TO ALL SPACES IN THE BUILDING NOT AFFECTED BY THIS WORK. COORDINATE WITH OWNER ANY DISRUPTION IN SERVICES REQUIRED TO PERFORM WORK OR TO MODIFY EXISTING PIPING, DUCTWORK OR ANY ASSOCIATED EQUIPMENT.
- REFER TO SHEET ID-101 AND ID-102 FOR FINISH SCHEDULE AND MATERIALS.
- REFER TO SHEET A-000 FOR DOOR SCHEDULE, DOOR TYPES, HARDWARE AND NOTES.

GRAPHIC LEGEND

| | |
|--|---|
| EXISTING WALL TO REMAIN | 1 PLAN KEY NOTE |
| EXISTING DOOR TO REMAIN | 16 PARTITION TYPE |
| INFECTION CONTROL/CONSTRUCTION BARRIER WALL (IFC/CB) | 18 INTERIOR ELEVATION |
| NEW WALL/PARTITION | 20 NEW DOOR |
| 2'-0" x 2'-0" SUSPENDED EXPOSED GRID ACOUSTIC CEILING TILE | 22 EXIT LIGHT |
| DRYWALL CEILING/SOFFIT, HEIGHT SHOWN | 24 NEW OCCUPANCY SENSOR |
| RETURN, EXHAUST GRILLE | 26 CEILING HEIGHT |
| SUPPLY GRILLE | 28 NEW LIGHT FIXTURE, RECESSED FLUORESCENT, 2'x2' |
| NEW SWITCH | 30 NEW RECESSED CAN LIGHT FIXTURE, LED |
| NEW LIGHT FIXTURE, RECESSED FLUORESCENT EMERGENCY, 2'x2'; USE EMERG. CRT FROM CORRIDOR LIGHTING. | |
| NEW CEILING MOUNTED NURSE CALL INDICATOR | |

KEY PLAN

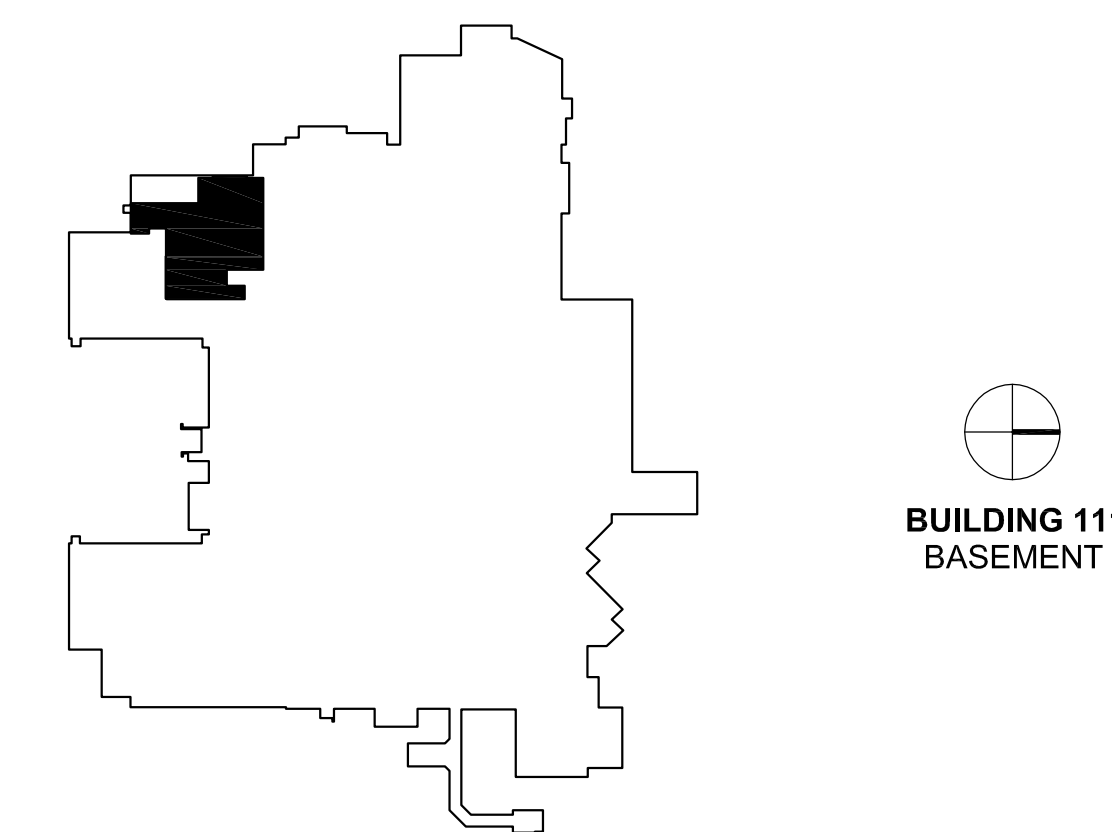

ARCHITECT:

CLEMENT J. ZABLOCKI VA MEDICAL CENTER
OFFICE OF CONSTRUCTION AND FACILITIES MANAGEMENT

Drawing Title
PHASE 1-3:
REFLECTED CEILING PLANS

Approved: Project Director
Troy Martinson, PE

Project Title
111 Upgrade Pool Locker
Rooms

Location
VA Medical Center, Milwaukee, WI

Date
August 28, 2015


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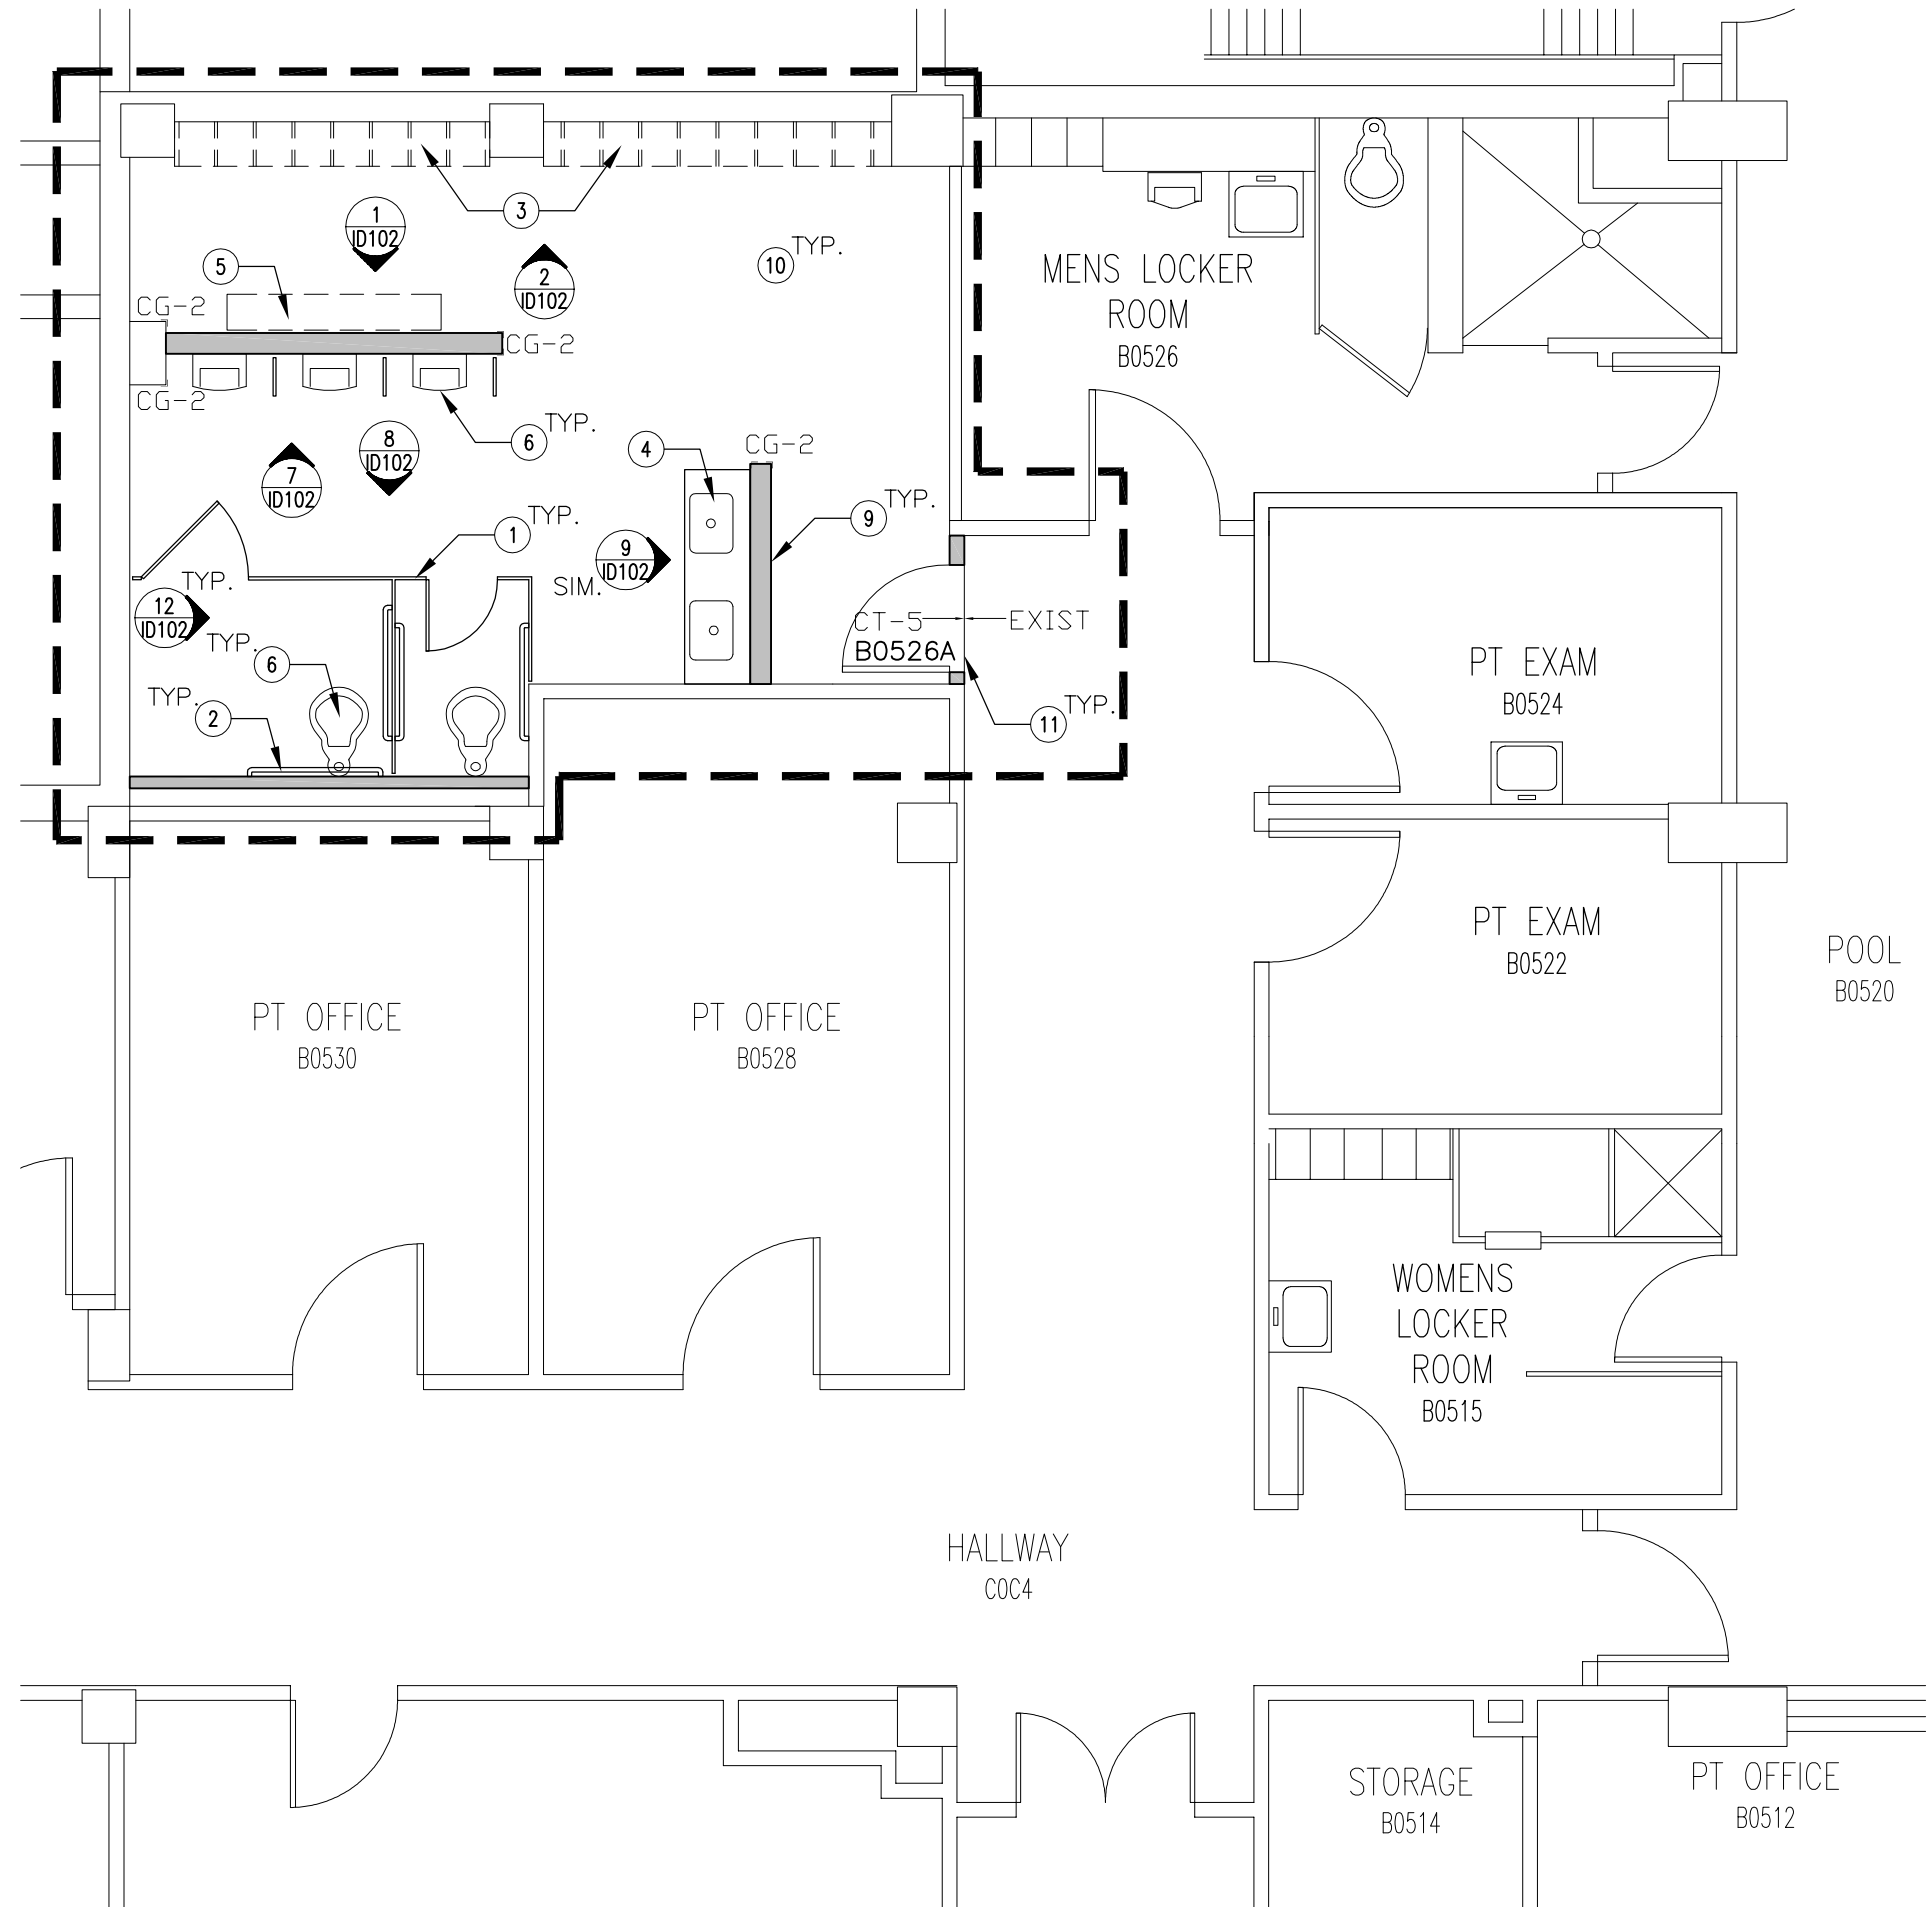
Project Number
695-14-114
Building Number
Building 111
Drawing Number
A-301

Office of
Construction
and Facilities
Management

Department of
Veterans Affairs



3 PLAN - PHASE 3
3/16" = 1'-0"

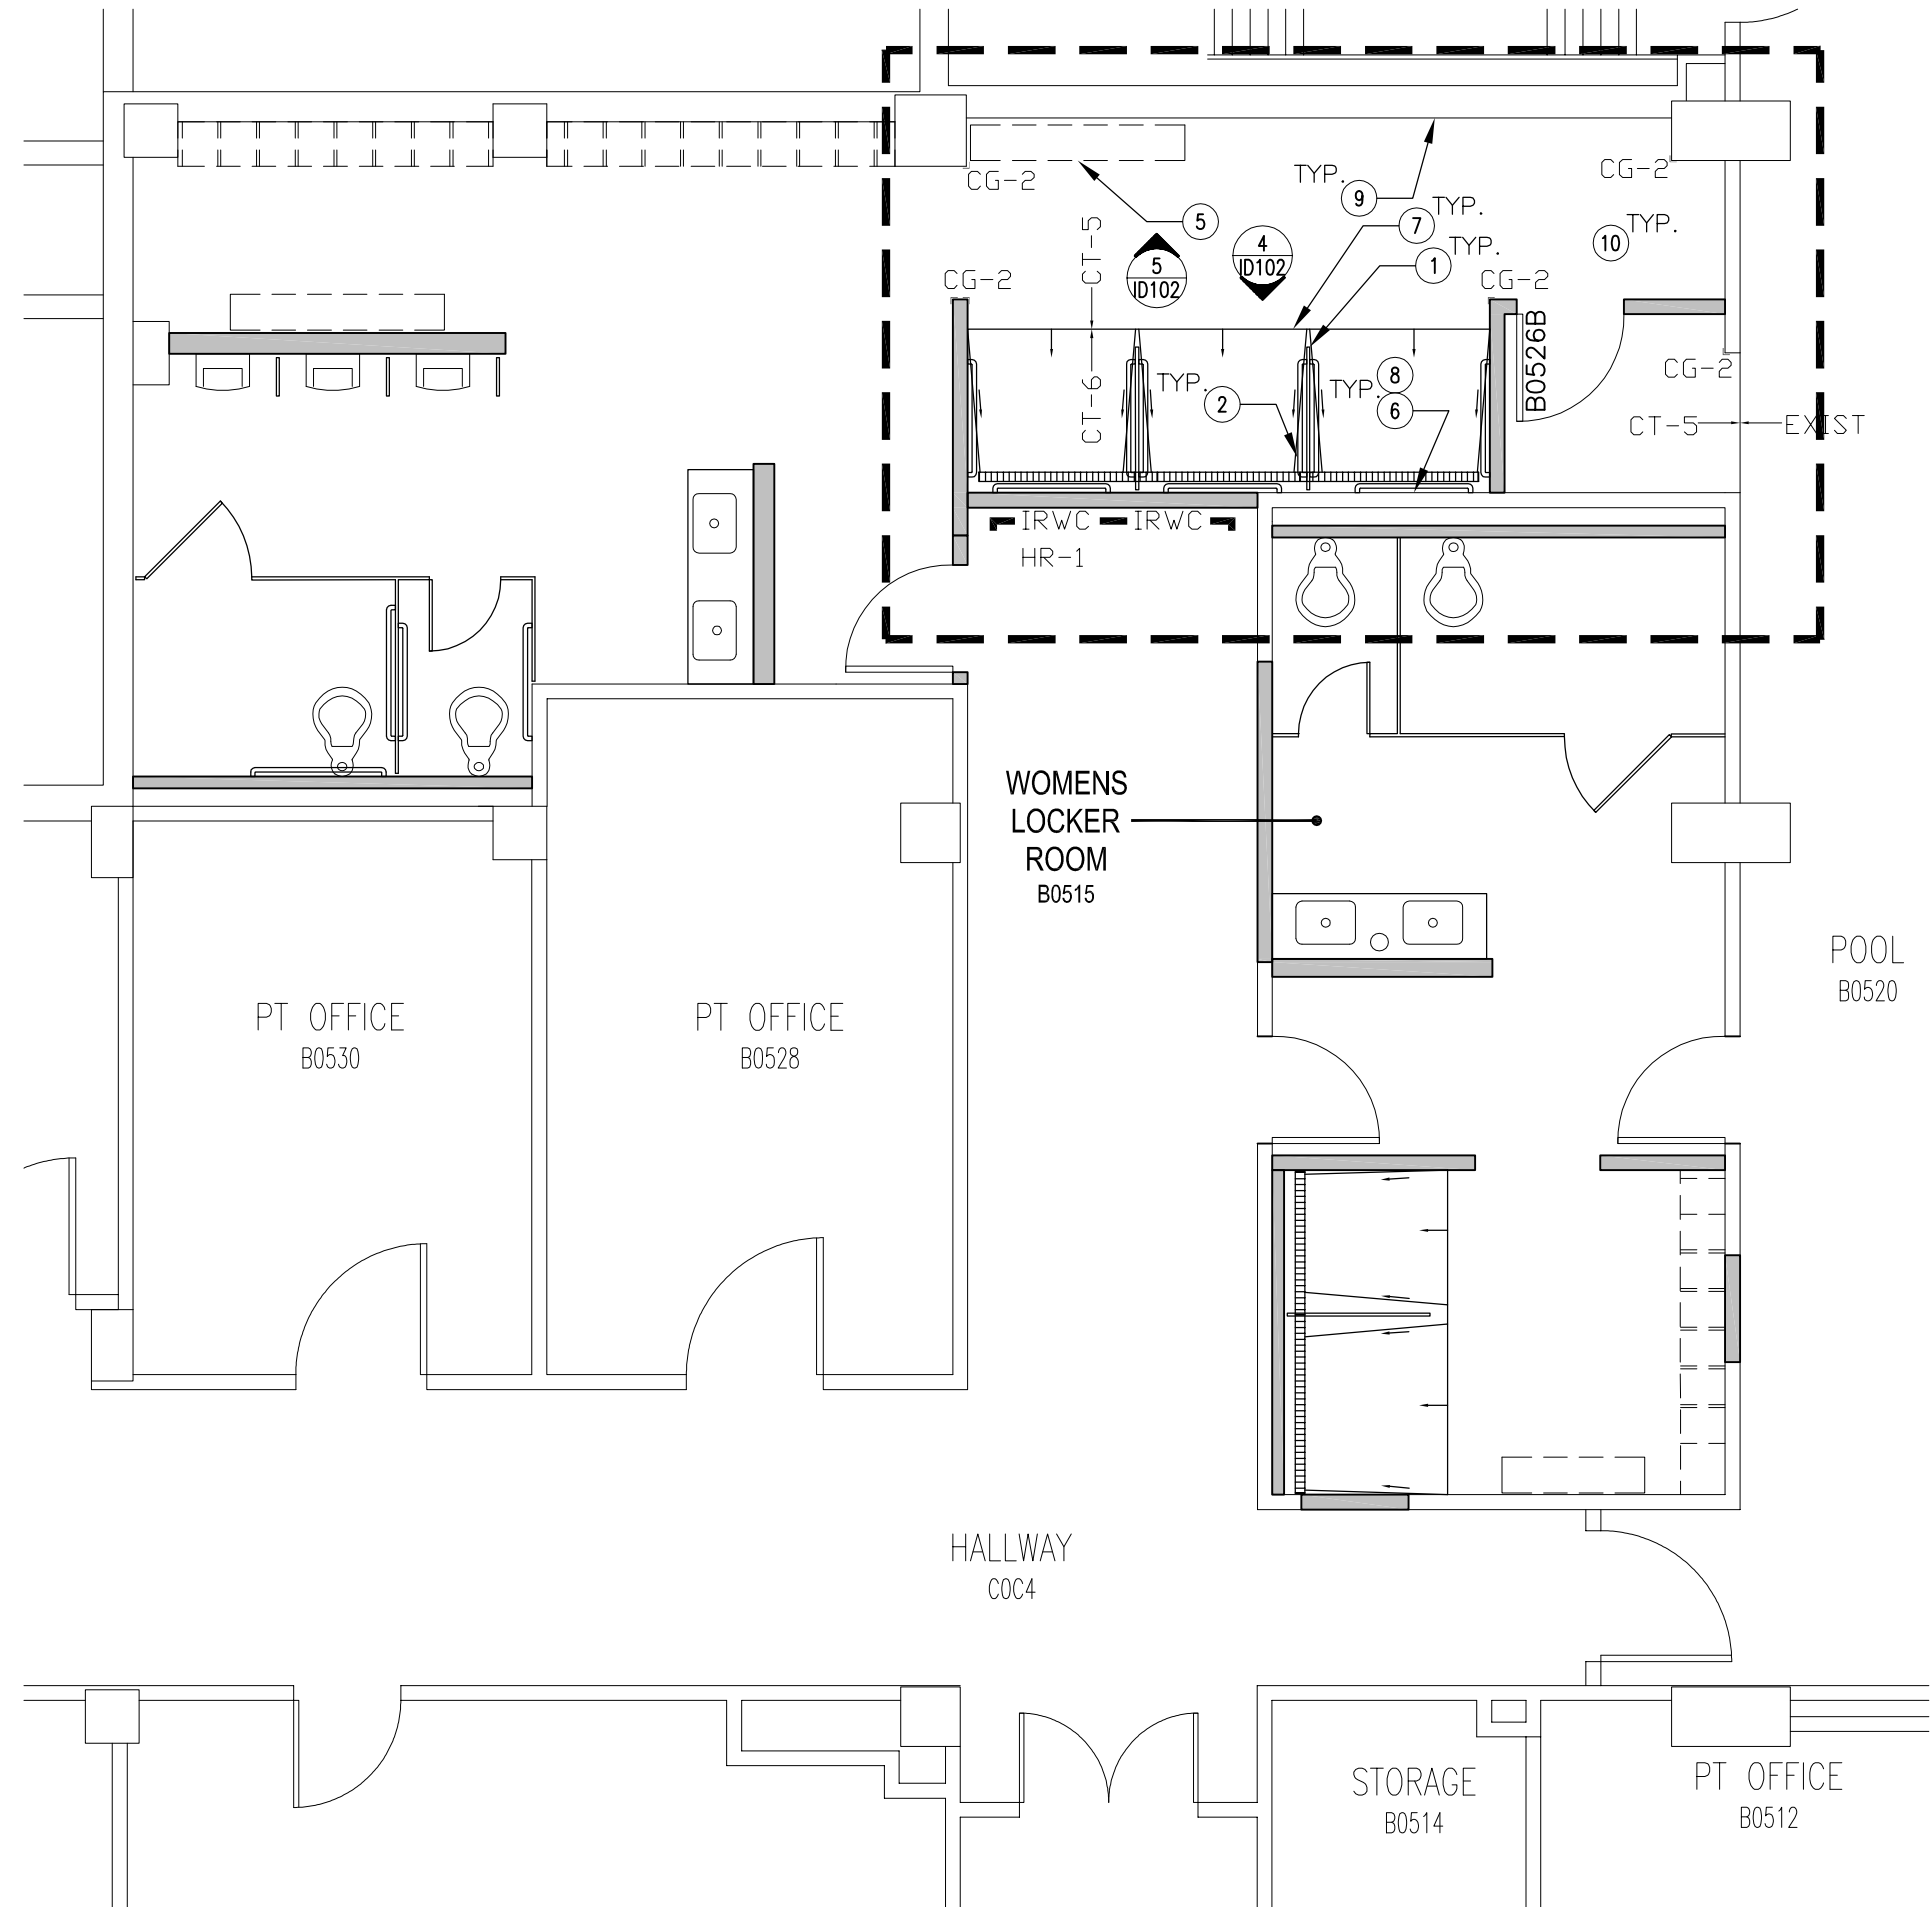


1 PLAN - PHASE 1
3/16" = 1'-0"

| ROOM FINISH SCHEDULE | | | | | | | | | |
|--|---------------------|-----------|------------|----------------|----------------|----------------|----------------|------------|------|
| Project Title: 111 Upgrade Pool Locker Rooms | | | | | | | | | |
| Room # | Room Name | Floor | Base | North | East | South | West | Ceiling | Type |
| COC4 | HALLWAY | RBR-1 | MATCH EXST | IRWC-1-EXST | IRWC-1-EXST | IRWC-1-EXST | IRWC-1-EXST | MATCH EXST | -- |
| B0515 | WOMENS LOCKER ROOM | CT-5/CT-6 | CT-5 | CT-1/CT-2/PA-1 | CT-1/CT-2/PA-1 | CT-1/CT-2/PA-1 | CT-1/CT-2/PA-1 | ACT-1 | -- |
| B0525 | TEMP. MENS RESTROOM | CT-5/CT-6 | CT-5 | CT-1/CT-2/PA-1 | CT-1/CT-2/PA-1 | CT-1/CT-2/PA-1 | CT-1/CT-2/PA-1 | ACT-1 | -- |
| B0526 | MENS LOCKER ROOM | CT-5/CT-6 | CT-5 | CT-1/CT-2/PA-1 | CT-1/CT-2/PA-1 | CT-1/CT-2/PA-1 | CT-1/CT-2/PA-1 | ACT-1 | -- |
| COC3 | HALLWAY | EXST | MATCH EXST | IRWC-1/PA-3 | IRWC-1/PA-3 | IRWC-1/PA-3 | IRWC-1/PA-3 | MATCH EXST | -- |

| MATERIALS SCHEDULE | | | | |
|----------------------------------|---|--|--------------------------|---|
| CODE | MATERIAL | NAME & NUMBER | MANUFACTURER | NOTES |
| ACOUSTICAL CEILING - Division 9 | | | | |
| ACT-1 | Acoustical Ceiling | #755B White, 24" x 24" x 3/4" Beveled Tegal Lay-In Panel - Ceiling Grid and Supports to be Aluminum / Moisture Resistant | Armstrong | |
| FLOORING - Division 9 | | | | |
| RB-1 | Resilient Base | Color: TBD. Vinyl. Height to match existing | Johnsone | Phase 2 corridor work |
| EP-1 | Epoxy Flooring with Epoxy Cove Base | Epoxy Flooring with Integral 6" Epoxy Cove Base. Color: Olivestone - DURA-CHIP: Armor Top Gloss with Grit. | Dur-a-Flex | Bid Alternate #1: replace all tile floor and tile cove base with Epoxy flooring and integral 6" Epoxy cove base. |
| PAINTING / STAINING - Division 9 | | | | |
| PA-1 | Paint | Color: Silver Marlin 2139-50. Finish: Gloss Level 4 | Benjamin Moore | All Walls in both Locker Rooms. U.N.O. |
| PA-2 | Paint | Color: China White. Finish: Gloss Level 5 | Benjamin Moore | Door and Door Frame - Corridor Side ONLY. |
| PA-3 | Paint | Color: Accessible Beige SW 7036. Finish: Gloss Level 4 | Sherwin-Williams | Corridor Walls ONLY. |
| PA-4 | Paint | Color: Gauntlet Gray SW 7019. Finish: Gloss Level 5 | Sherwin-Williams | Door and Door Frame - Both Locker Rooms Inside ONLY |
| CERAMIC TILE - Division 9 | | | | |
| CT-1 | Ceramic Tile ** | Streamline Ceramic Wall Tile, 312 Gunmetal - 3" x 6" Tile | Florida Tile | All Walls in Both Locker Rooms. See Elevation 131D-102 |
| CT-2 | Ceramic Tile ** | Streamline Ceramic Wall Tile, 411 Doran Matte - 4" x 16" Tile | Florida Tile | All Walls in Both Locker Rooms. See Elevation 131D-102 |
| CT-3 | Ceramic Tile ** | Streamline Ceramic Wall Tile, 312 Gunmetal - 4" x 16" Tile | Florida Tile | Shower Enclosure. See Elevation 111D-102 - Walls ONLY |
| CT-4 | Ceramic Tile ** | Streamline Ceramic Wall Tile, 411 Doran Matte - 3" x 6" Tile | Florida Tile | Shower Enclosure. See Elevation 111D-102 - Walls ONLY |
| GT-1 | Grout ** | 335 Winter Gray | Custom Building Products | All Floors and Walls in Both Locker Rooms where tile occurs |
| CT-5 | Ceramic Tile ** | Main Street Porcelain Stone Floor Tile, AV214 Gallery Grey - 12" x 12" Tile and 6" x 12" Cove Base | Armstrong | All Floors except Shower Enclosure - Refer to sheet ID 103. Provide a Schluter edge between tile and rubber flooring. |
| CT-6 | Ceramic Tile ** | Main Street Porcelain Stone Floor Tile, AV214 Gallery Grey - 2 x 2 Mosaics Tile and 6" x 12" Cove Base | Armstrong | Shower Enclosure ONLY. Refer to sheet ID 103. |
| MISC SPECIALTIES - Division 10 | | | | |
| PLAM-1 | Plastic Laminate | Color: Slate SG 228 Suede | Plonite | Privacy Panel and apron at Locker Room Sinks ONLY |
| SS-1 | Solid Surface | Color: Gulf Coast, F1-7710 | Avonite Surfaces | Locker Room Sinks ONLY |
| IRWC-1 | Impact Resistant Wall Covering, Top Caps, End Caps and Divider Bars | Color: Pewter Frost SM SE026, Roll-goods 80" x 4" | InPro Corporation | Corridor ONLY |
| OG-1 | Impact Resistant Corner Guards, & Top Caps | Color: Pewter Frost SM SE026, 158BN, 8" x 3" | InPro Corporation | Corridor ONLY |
| OG-2 | Stainless Steel Corner Guards | 16 Gauge, 2" Wings, 5'-0" Tall | | Both Locker Rooms ALL Corners |
| OG-3 | Stainless Steel End Walls | 16 Gauge, 2" Wings, 5'-0" Tall | | Both Locker Rooms and Restrooms |
| TP-1 | Toilet/Shower Partitions/Privacy Panel | Color: Sandcastle, Classic Series | Scantion Products | Both Locker Rooms and Restrooms |
| LRK-1 | Lockers | Color: Sandcastle, Tufftek Lockers, Two Tier, 12"W x 12"D x 27"H, Horizontal Venting, Slope Top, ADA Compliance Package. Color: Sandcastle, Tufftek Benches, ADA Compliant | Scantion Products | Both Locker Rooms |
| B-1 | Benches | Sandcastle, Tufftek Benches, ADA Compliant | Scantion Products | Both Locker Rooms |
| HR-1 | Handrails | Color: Applewood 0537 | InPro Corporation | Corridor ONLY |

** ALL TILE TO BE SEALED WITH MICROGUARD INORGANIC PROTECTIVE BARRIER, OVER ALL INSTALLED WALL TILE AND GROUT AS DESCRIBED IN MANUFACTURES SPECIFICATIONS, U.N.O.

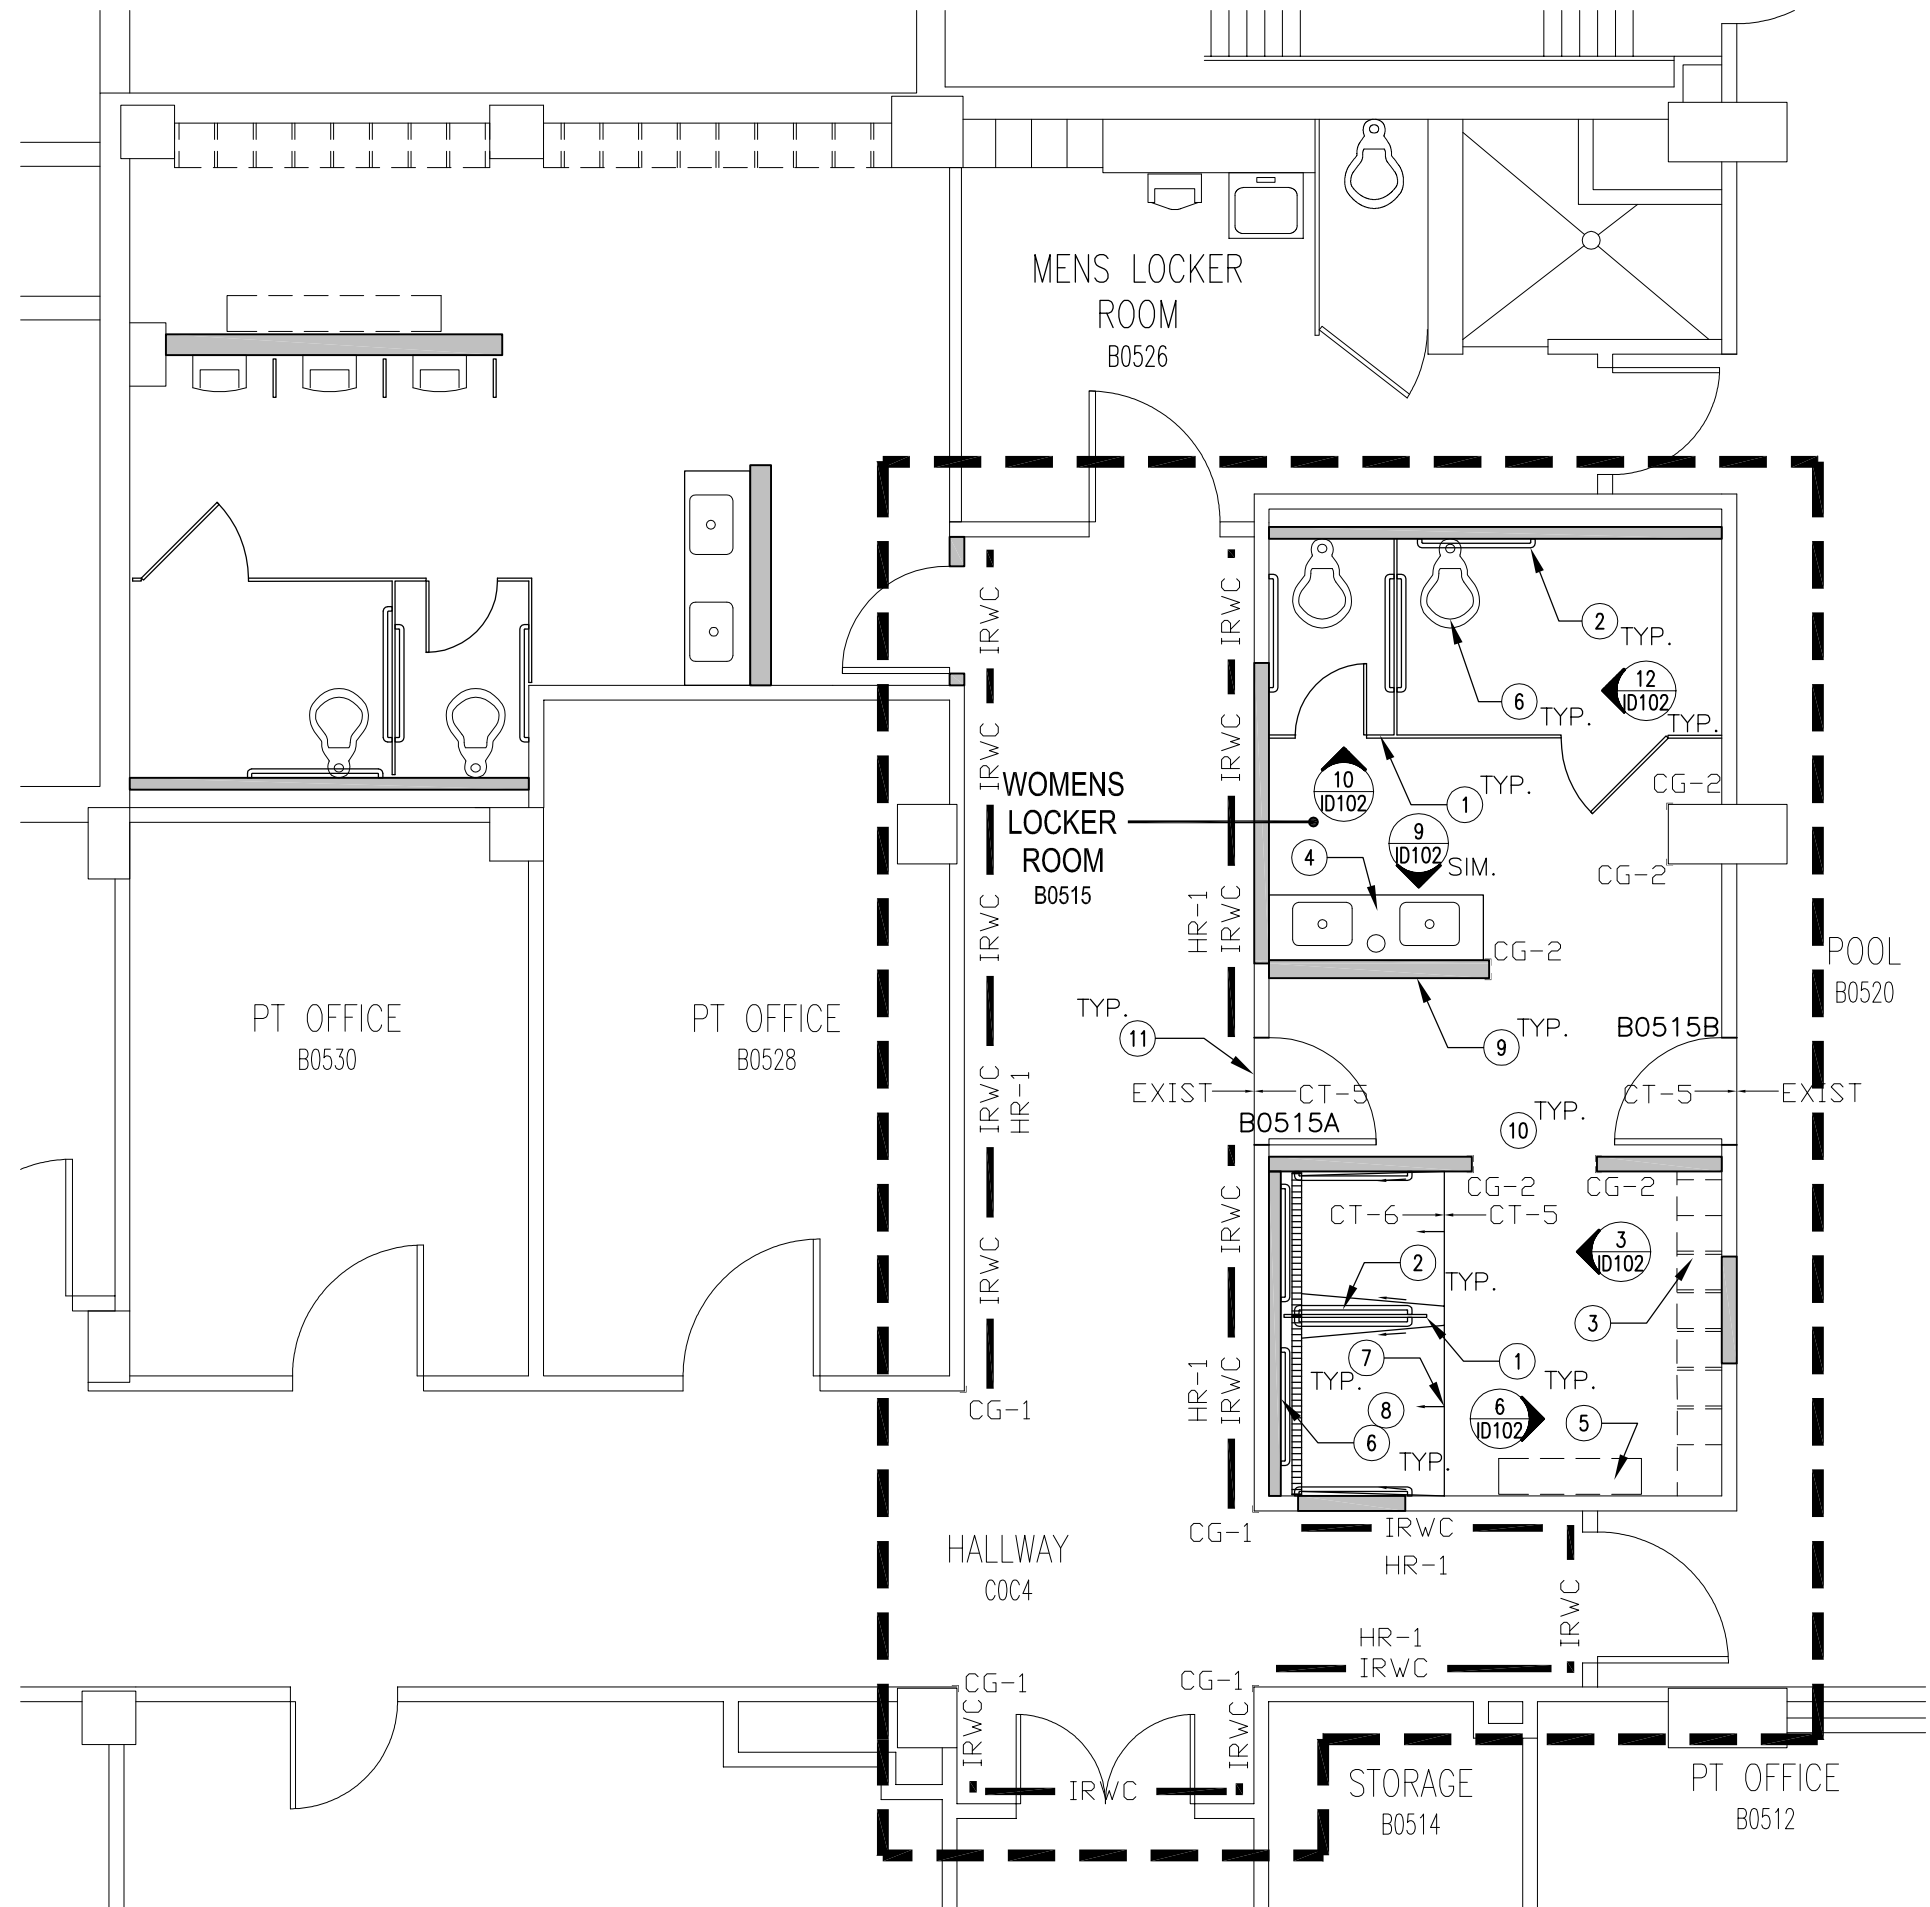

2 PLAN - PHASE 2
3/16" = 1'-0"


PLAN KEY NOTES

- 1 PROVIDE NEW TOILET PARTITIONS.
- 2 PROVIDE NEW ADA GRAB BARS AND REFER TO SHEET ID-102 FOR MOUNTING HEIGHTS.
- 3 PROVIDE NEW LOCKERS.
- 4 PROVIDE NEW DOUBLE SINK VANITY. SEE SHEET P-101 FOR FIXTURE SCHEDULE. REFER TO ELEVATIONS FOR DIMENSIONS SEE SHEET ID-102.
- 5 PROVIDE NEW FLOOR MOUNTED BENCH. COORDINATE PRECISE LOCATION WITH VA PRIOR TO INSTALLATION.
- 6 PROVIDE NEW PLUMBING FIXTURES AND REQUIRED PIPING TO BE TIED INTO EXISTING FACILITY. SEE SHEET P-101 FOR FIXTURE SCHEDULE. REFER TO ELEVATIONS SEE SHEET ID-102.
- 7 SLOPE FINISHED FLOOR BY 1% TOWARDS LINEAR DRAIN AS DESCRIBED IN MANUFACTURES SPECIFICATIONS FOR ADA ACCESSIBLE SHOWERS. ARROWS ON PLAN INDICATED DIRECTION OF FLOORING TO BE SLOPED AND WHERE SLOPE SHALL BEGIN.
- 8 SEE SHEET ID-102/13 FOR TYPICAL WALL TILE PATTERN FOR SHOWER AREA.
- 9 SEE SHEET ID-102/11 FOR TYPICAL WALL TILE PATTERN.
- 10 SEE SHEET ID-103 FOR TYPICAL FLOOR TILE PATTERN.
- 11 CONTRACTOR TO INSTALL SCHLUTER EDGE BETWEEN TILE FLOOR AND CORRIDOR FLOORING AS SPECIFIED BY MANUFACTURERS SPECIFICATIONS.

GENERAL NOTES

1. REFER TO DETAIL PLANS FOR ADDITIONAL PARTITION INFORMATION, SEE SHEET A-000.
2. INTERIOR DIMENSIONS ARE TO FINISH FACE TO FINISH FACE U.N.O.
3. INSTALL 5/8" TYPE X GYPSUM WALL BOARD AND ACOUSTICAL INSULATION IN ALL ROOMS, FINISH TO GRADE #5.
4. ALL SWITCHES, THERMOSTATS, AND OTHER ENVIRONMENTAL CONTROLS SHALL BE MOUNTED AT 40" A.F.F., TELEPHONE AND POWER OUTLETS SHALL BE AT 18" AFF. THESE CONTROLS SHALL BE LINED UP AT THE SAME HEIGHT AND WHERE MORE THAN ONE ARE ADJACENT, THEY SHALL BE EVENLY SPACED. GROUP MULTIPLE DEVICES IN A SINGLE COVER PLATE WHERE POSSIBLE.
5. VERIFY ALL UTILITIES AND CONNECTION LOCATIONS.
6. ALL PENETRATIONS IN RATED WALLS, SHALL BE RATED, TESTED ASSEMBLIES AS REQUIRED BY CODE.
7. SEAL ALL PENETRATIONS IN SMOKE BARRIERS IN ACCORDANCE WITH CODES AND REQUIREMENTS.
8. CONTRACTOR SHALL VERIFY ALL EXISTING CONDITIONS AND DIMENSIONS PRIOR TO BEGINNING CONSTRUCTION.
9. CORNER GUARDS ARE REQUIRED AT ALL OUTSIDE CORNERS, SOME LOCATIONS MAY NOT BE INDICATED ON DRAWINGS. SEE THIS SHEET FOR ADDITIONAL LOCATIONS.
10. REPLACE DOORS, LOCKS, KICK PLATES, CLOSER, BUMPER GUARDS, DOOR STOPS, AND HARDWARE, SEE SHEET A-000. RESTORE DOOR FRAME TO SMOOTH FINISH AND REPAINT.
11. ALL WALL HUNG CASEWORK, SHELVING AND EQUIPMENT ATTACHED TO WALLS SHALL BE ANCHORED BETWEEN STUDS.
12. REFER TO INTERIOR FLOOR FINISH PLAN, THIS SHEET.
13. REFER TO INTERIOR WALL FINISH PLAN, THIS SHEET.
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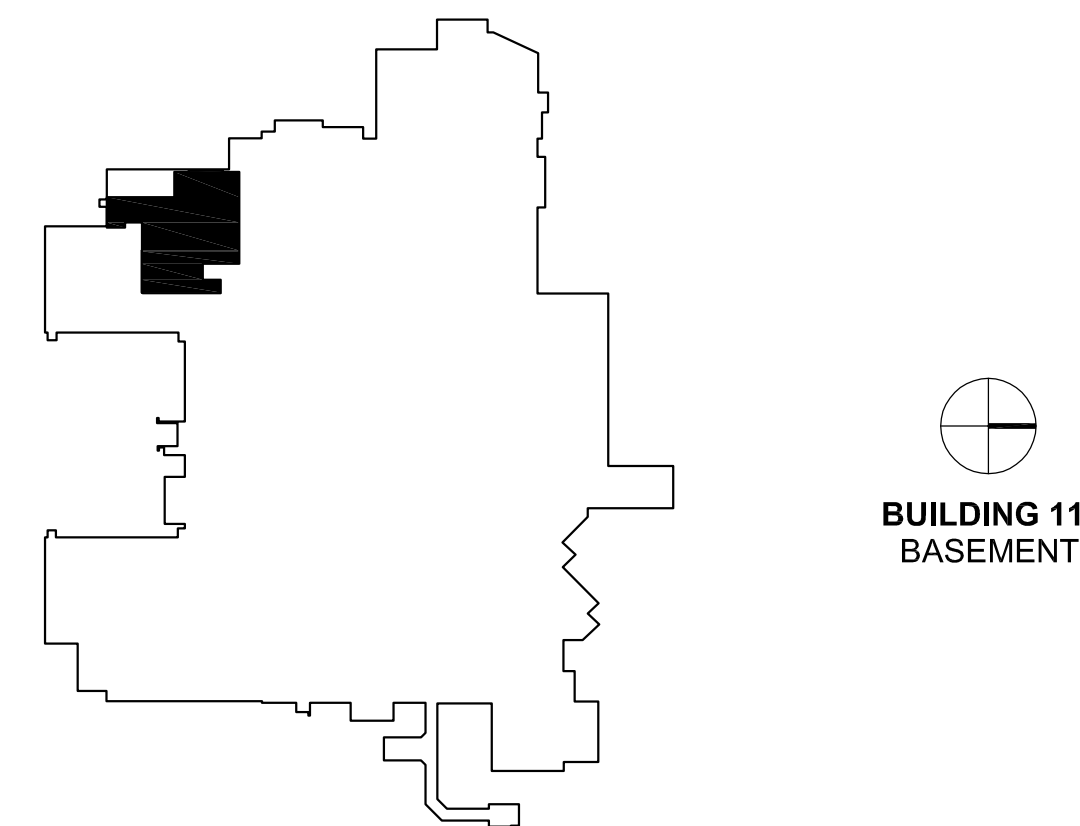
GRAPHIC LEGEND

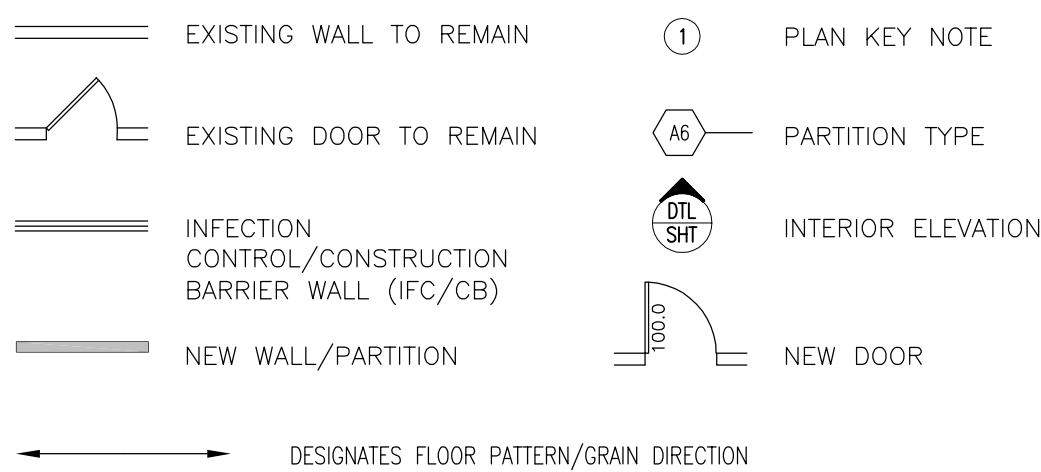

FINISH PLAN GENERAL NOTES

1. PRIOR TO FLOORING INSTALLATION, SCHEDULE A PRE-INSTALLATION CONFERENCE ON SITE WITH INTERIOR DESIGNER/ARCHITECT TO COORDINATE LAYOUT.
2. RESILIENT BASE PROFILE TO BE COVED ON HARD SURFACE FLOORING AND STRAIGHT ON CARPET.
3. EPOXY FLOORING TO BE COVED 6" ABOVE FLOORING. PROVIDE ALUMINUM TOP CAP WITH CLEAR SILICONE BEAD.
4. PROVIDE A FLUSH TRANSITION BETWEEN DIFFERENT FLOORING MATERIALS OF VARYING HEIGHTS. PROVIDE TRANSITION STRIPS AS NECESSARY. INTERIOR DESIGNER TO SELECT COLOR FROM MANUFACTURER'S FULL COLOR LINE.
5. VINYL COMPOSITION TILE TO BE INSTALLED TO MATCH EXISTING CONDITION.
6. FOR EACH SHEET VINYL PRODUCT SPECIFIED, PROVIDE MANUFACTURER'S RECOMMENDED MATCHING WELD ROD. SUBMIT SAMPLE TO ARCHITECT FOR APPROVAL.
7. REFER TO THIS SHEET FOR FINISH SCHEDULE.
8. REFER TO SHEET 11/ID-102 FOR TYPICAL TILE PATTERN AT SHOWER AND 13/ID-102 WALL CONDITIONS. REFER TO FINISH SCHEDULE ON SHEET A-000 FOR SPECIFICATIONS.
9. AT ALL LOCATIONS WHERE NEW FLOOR FINISH MEETS EXISTING FLOOR FINISH, THE CONTRACTOR SHALL FLASH PATCH OR GRIND THE EXISTING FLOOR AS NECESSARY TO ALLOW FOR FINISHES TO BE FLUSH.

KEY PLAN



| | | | |
|--|--|---|--|
| | | Dept. of Veterans Affairs Medical Center 5000 W. National Avenue Milwaukee, WI | |
| ARCHITECT: | | CLEMENT J. ZABLOCKI VA MEDICAL CENTER OFFICE OF CONSTRUCTION AND FACILITIES MANAGEMENT | |
| Drawing Title | | PHASE 1 - 3: INTERIOR FINISH PLANS AND SCHEDULE | |
| Approved: Project Director | | Troy Martinson, PE | |
| Project Title | | 111 Upgrade Pool Locker Rooms | |
| Location | | VA Medical Center, Milwaukee, WI | |
| Date | | August 28, 2015 | |
| Checked | | AJ | |
| Drawn | | AJ | |
| Project Number | | 695-14-114 | |
| Building Number | | Building 111 | |
| Drawing Number | | ID-101 | |
| Office of Construction and Facilities Management | | Department of Veterans Affairs | |


GENERAL NOTES

1. ALL EXPOSED CORNERS ON COUNTERS ARE TO HAVE A 1 1/2" RADIUS MINIMUM UNLESS OTHERWISE NOTED.
2. REFER TO ROOM FINISH SCHEDULE FOR ALL FINISHES. SEE SHEET ID-101.
3. VERIFY LOCATION OF OWNER PROVIDED/CONTRACTOR INSTALLED ACCESSORIES PRIOR TO INSTALLATION.


PLAN KEY NOTES

- ① 4" HIGH SOLID SURFACE BACKSPLASH (SS-1).
- ② SOLID SURFACE COUNTERTOP (SS-1).
- ③ PRIVACY PANEL AND APRON (PLAM-1).
- ④ SURFACE MOUNTED SOAP DISPENSER - VA PROVIDED CONTRACTOR INSTALLED.
- ⑤ GEORGIA PACIFIC EMMOTION TOWEL DISPENSER MODEL 59462. CONTRACTOR PROVIDED AND INSTALLED.
- ⑥ NOT USED.
- ⑦ FRAMELESS MIRROR 1'-6" X 3'-4".
- ⑧ SURFACE MOUNTED TOILET PAPER DISPENSER VA PROVIDED CONTRACTOR INSTALLED.
- ⑨ ADA STAINLESS STEEL GRAB BAR, CONTRACTOR TO PROVIDE WALL BACKING WHERE REQUIRED OR STEEL PLATE WHEN MOUNTED BACK TO BACK ON PRIVACY PANEL.
- ⑩ TOILET PARTITION (TP-1).
- ⑪ ADDITIONAL BACKING MATERIAL REQUIRED.
- ⑫ LOCKERS (LK-1).
- ⑬ BENCHES (B-1).
- ⑭ NURSE CALL, ALARM AT VA POLICE.
- ⑮ GFCI OUTLET.


KEY PLAN

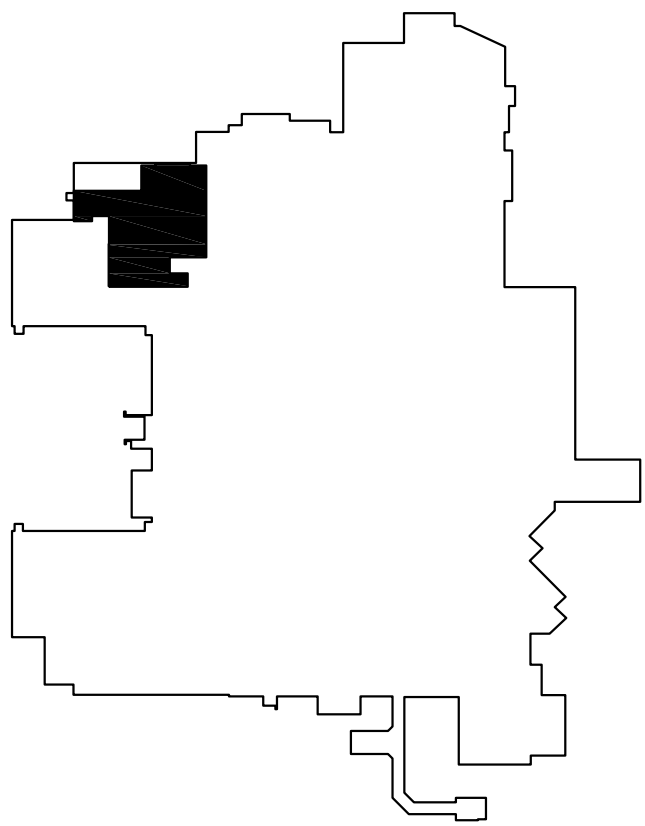


BUILDING 111
BASEMENT

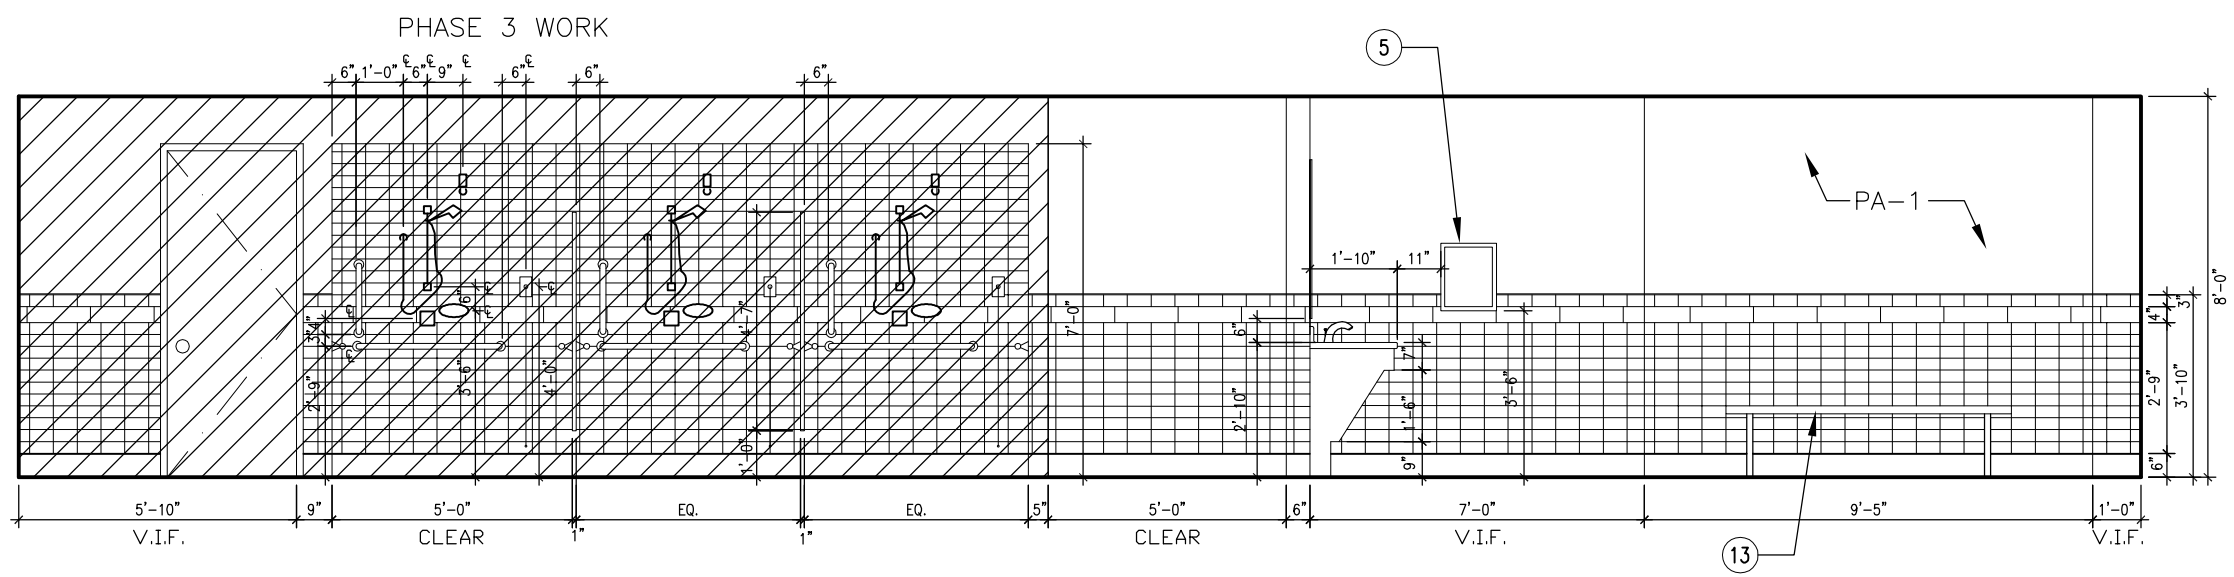


1 MEN'S RESTROOM
1/4" = 1'-0"

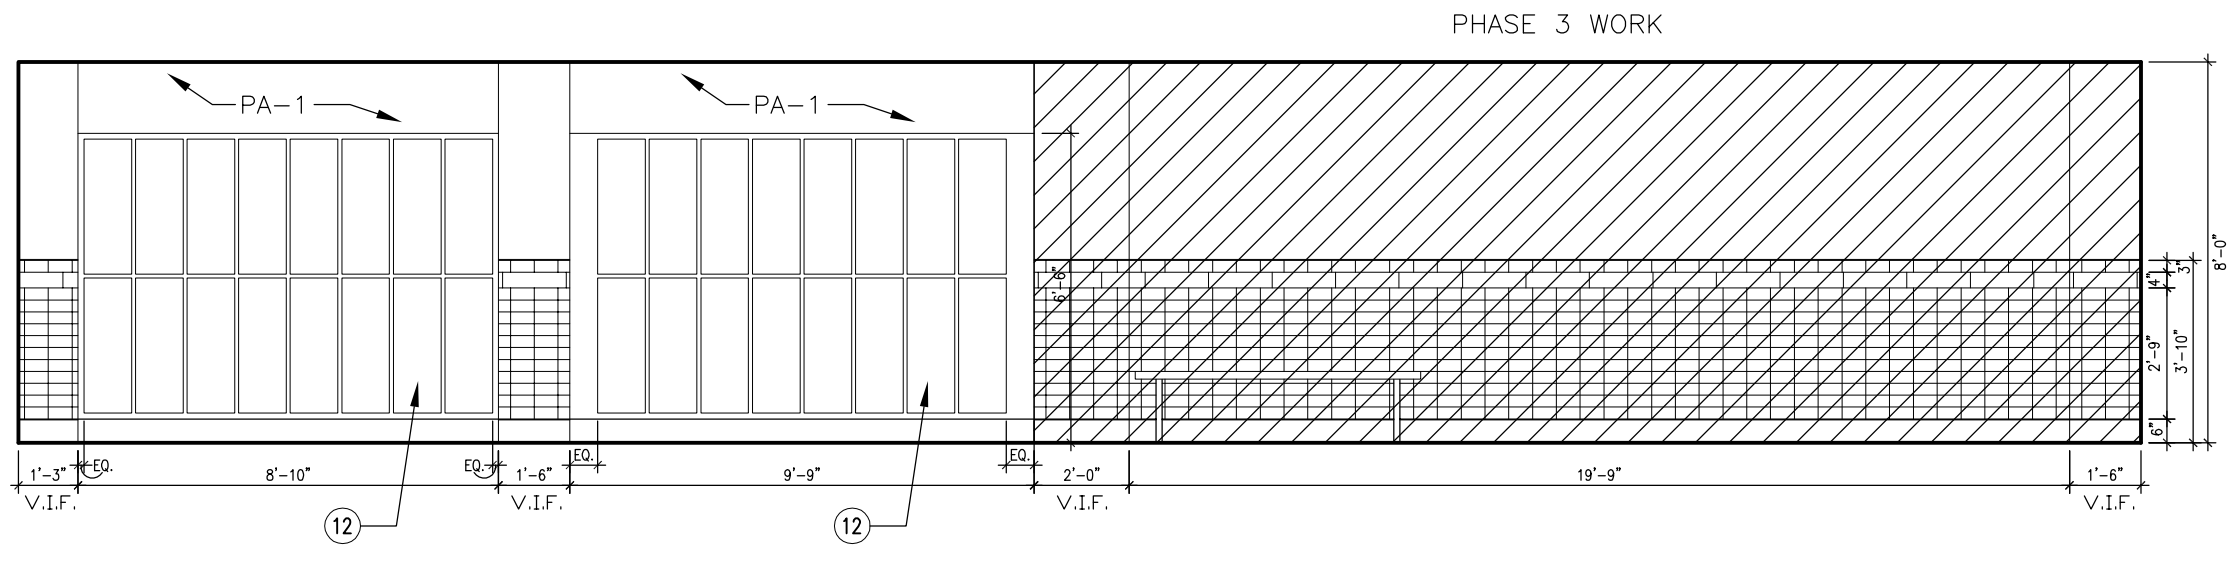


2 MEN'S LOCKER AREA
1/4" = 1'-0"

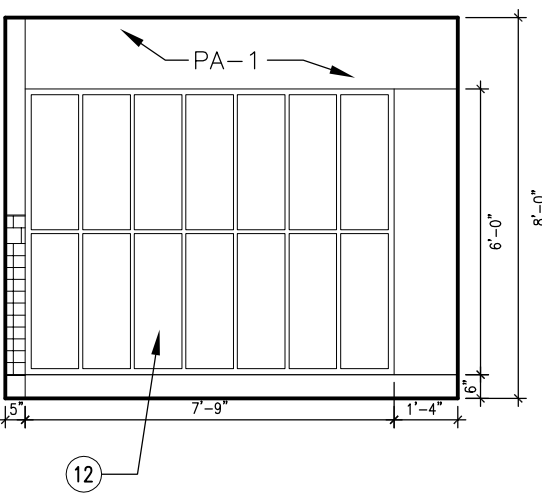


6 WOMEN'S LOCKER AREA
1/4" = 1'-0"

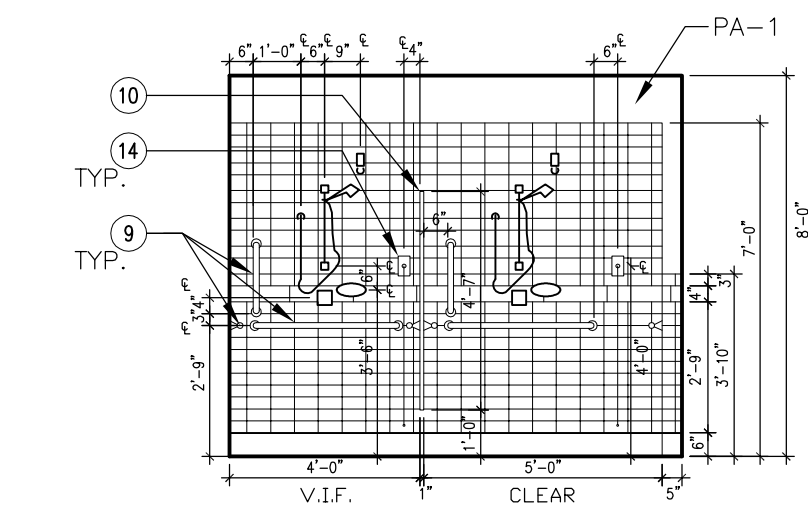


3 WOMEN'S SHOWER AREA
1/4" = 1'-0"

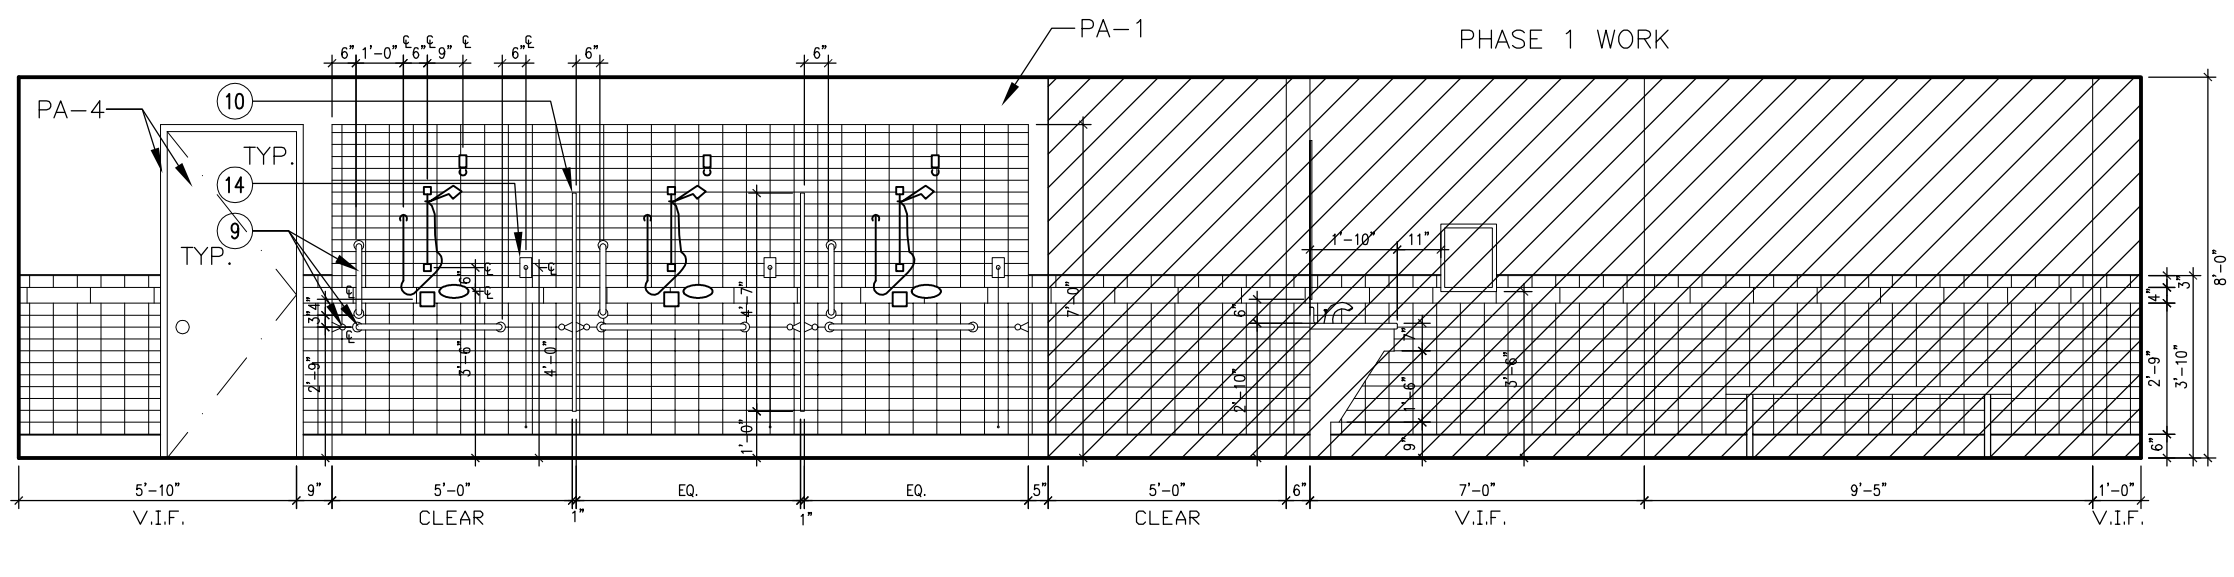


4 MEN'S SHOWER AREA
1/4" = 1'-0"

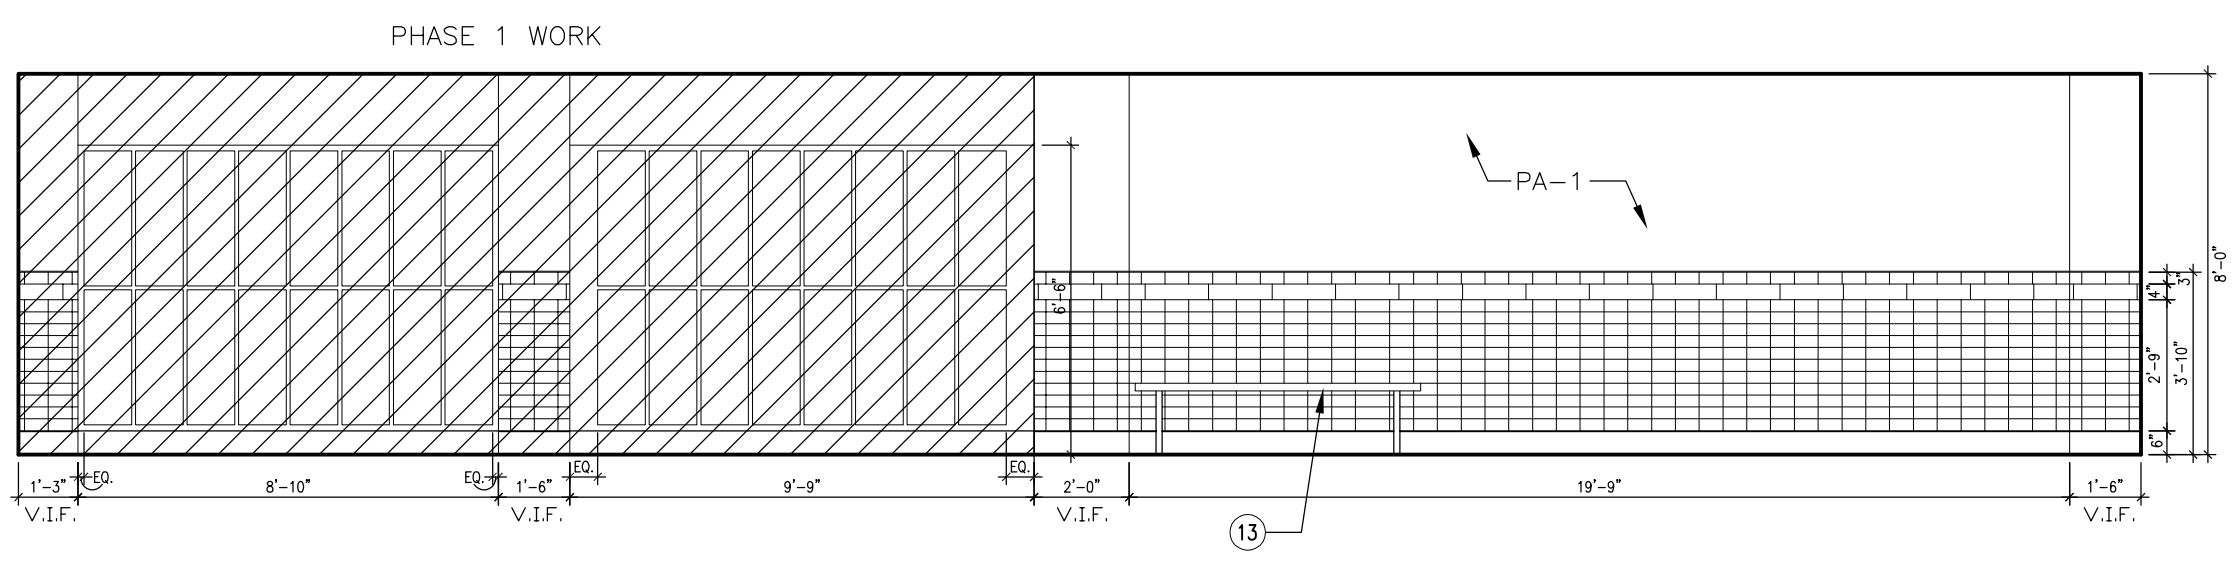


5 MEN'S SHOWER AREA
1/4" = 1'-0"

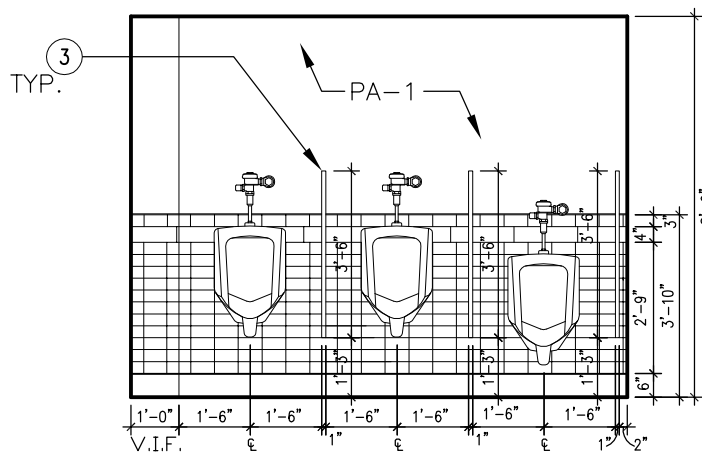


7 MEN'S RESTROOM
1/4" = 1'-0"

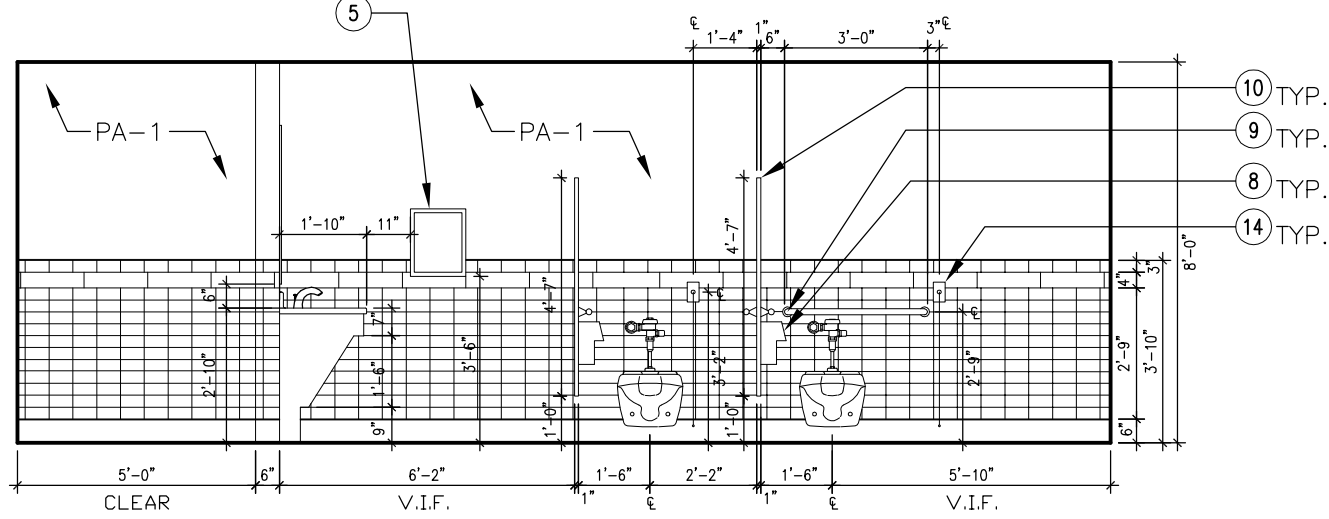


8 MEN'S RESTROOM
1/4" = 1'-0"

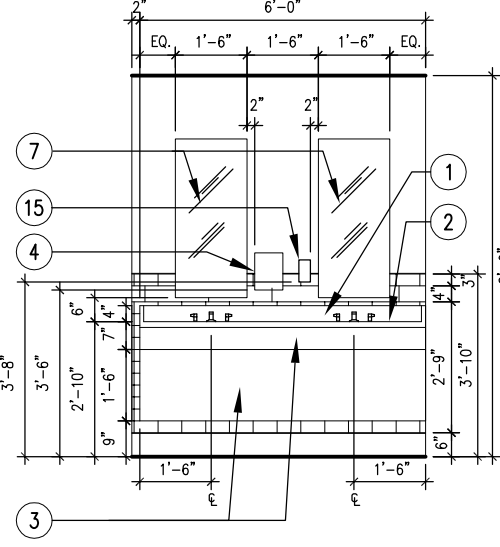

9 TYPICAL MEN'S & WOMEN'S SINK
1/4" = 1'-0"

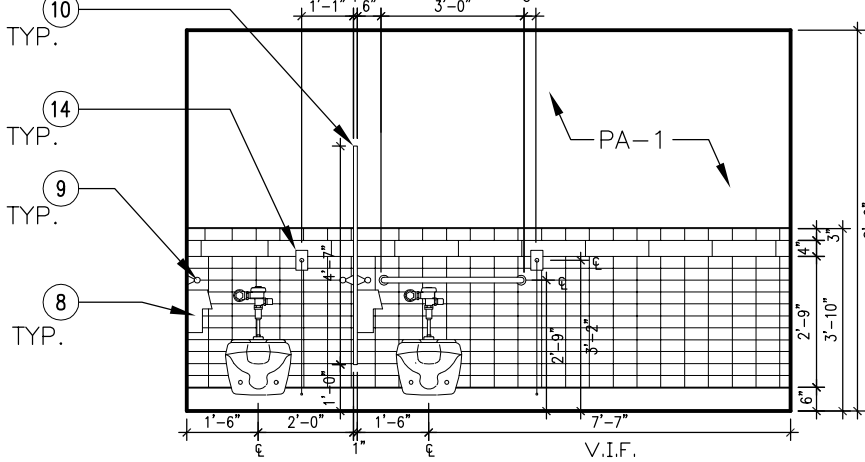


10 WOMEN'S RESTROOM
1/4" = 1'-0"

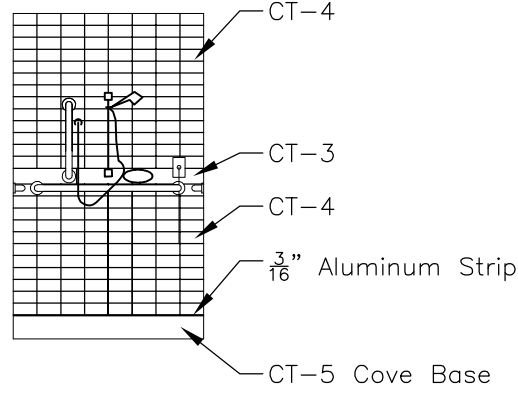


11 TYPICAL WALL TILE PATTERN AT SHOWER
1/4" = 1'-0"

NOTE: DESIGN INTENT. CONTRACTOR TO PROVIDE SHOP DRAWINGS FOR TILE PATTERN PRIOR TO INSTALLATION FOR VA APPROVAL PRIOR TO WORK.

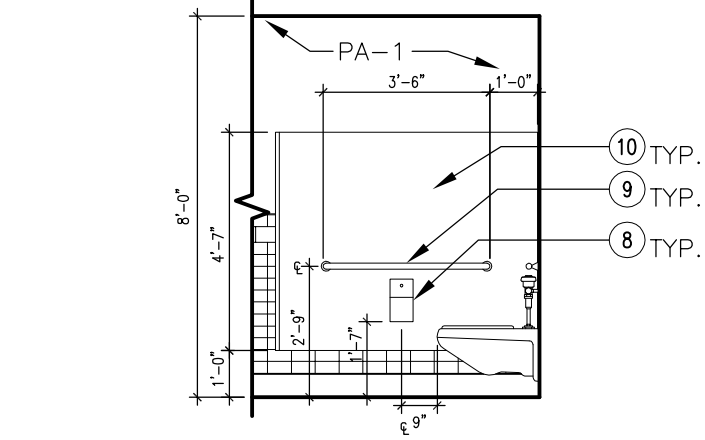

12 TYPICAL TOILET PARTITION
1/4" = 1'-0"

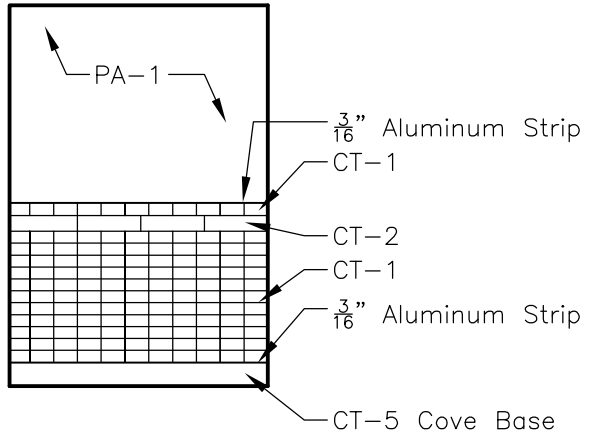

13 TYPICAL WALL TILE PATTERN
1/4" = 1'-0"

NOTE: DESIGN INTENT. CONTRACTOR TO PROVIDE SHOP DRAWINGS FOR TILE PATTERN PRIOR TO INSTALLATION FOR VA APPROVAL PRIOR TO WORK.



ARCHITECT:

CLEMENT J. ZABLOCKI VA MEDICAL CENTER
OFFICE OF CONSTRUCTION AND FACILITIES MANAGEMENT

Drawing Title

PHASE 1 - 3:
INTERIOR ELEVATIONS

Approved: Project Director

Troy Martinson, PE

Project Title

111 Upgrade Pool Locker
Rooms

Location

VA Medical Center, Milwaukee, WI

Date

August 28, 2015

Checked

Drawn

AJ

Project Number

695-14-114

Building Number

Building 111

Drawing Number

ID-102

Office of
Construction
and Facilities
Management



Department of
Veterans Affairs

A

B

C

D

E

F

L

A


B

C


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E


F

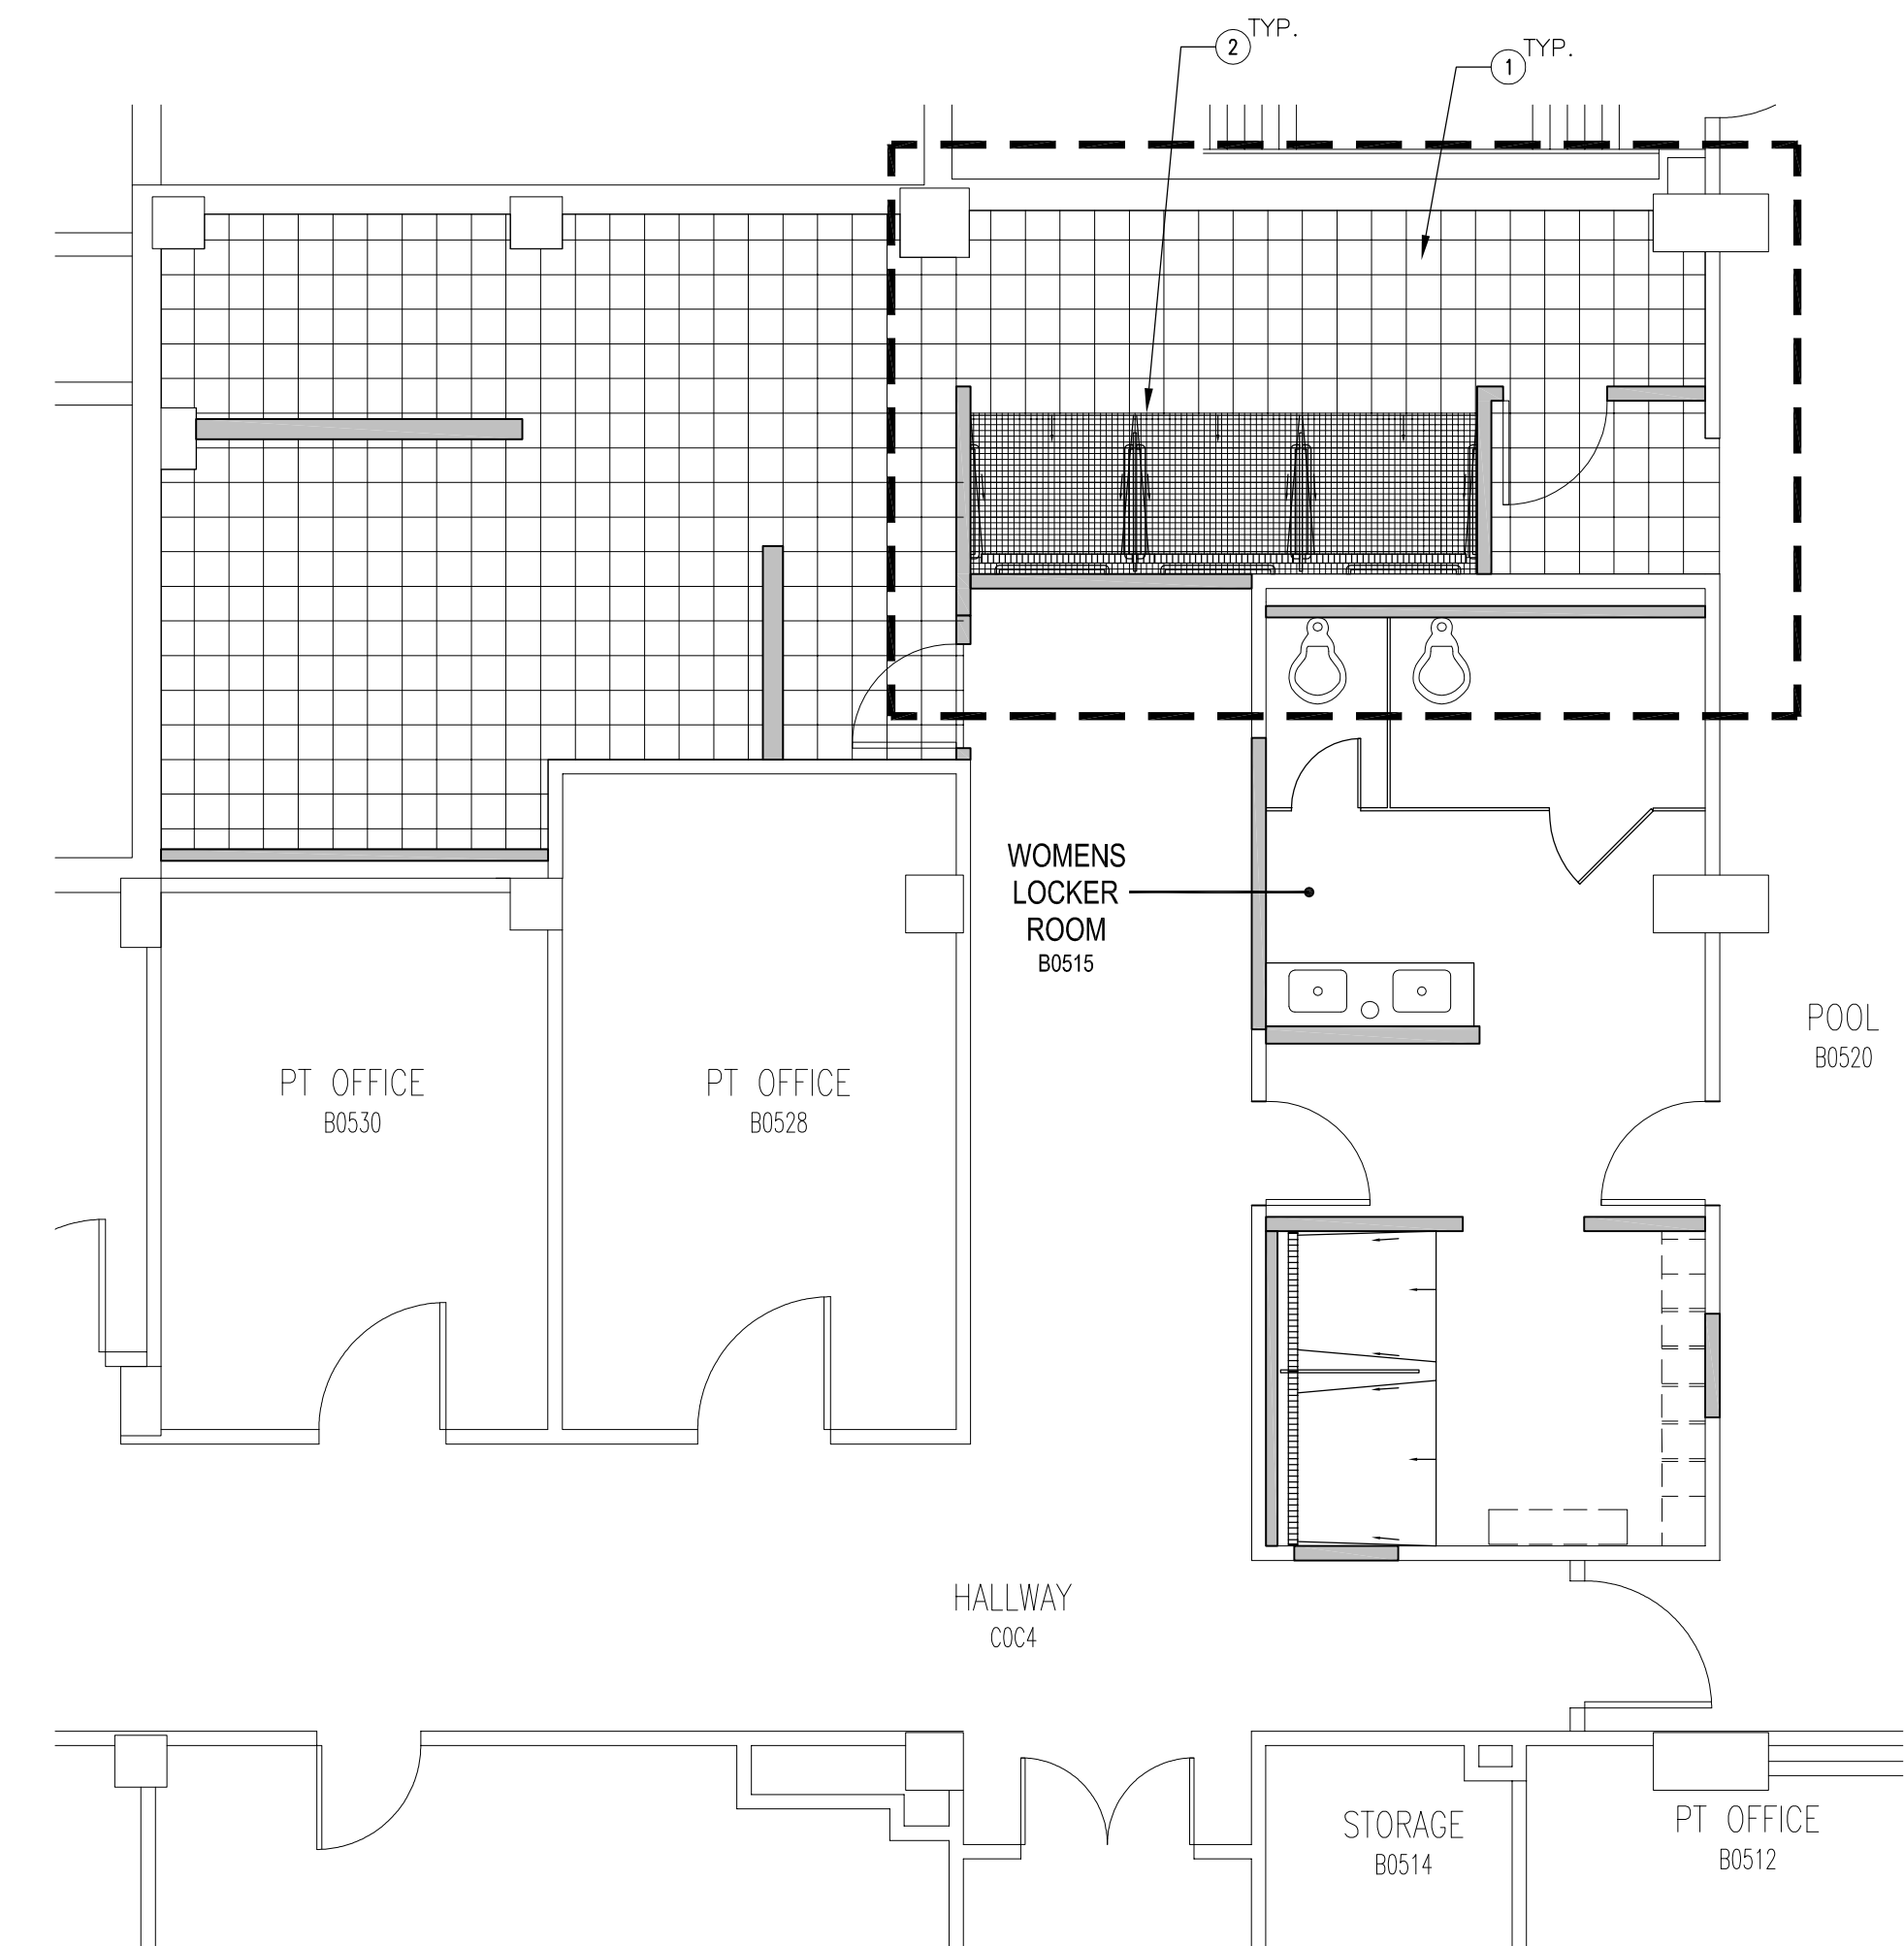

3 TILE PLAN - PHASE 3
3/16" = 1'-0"

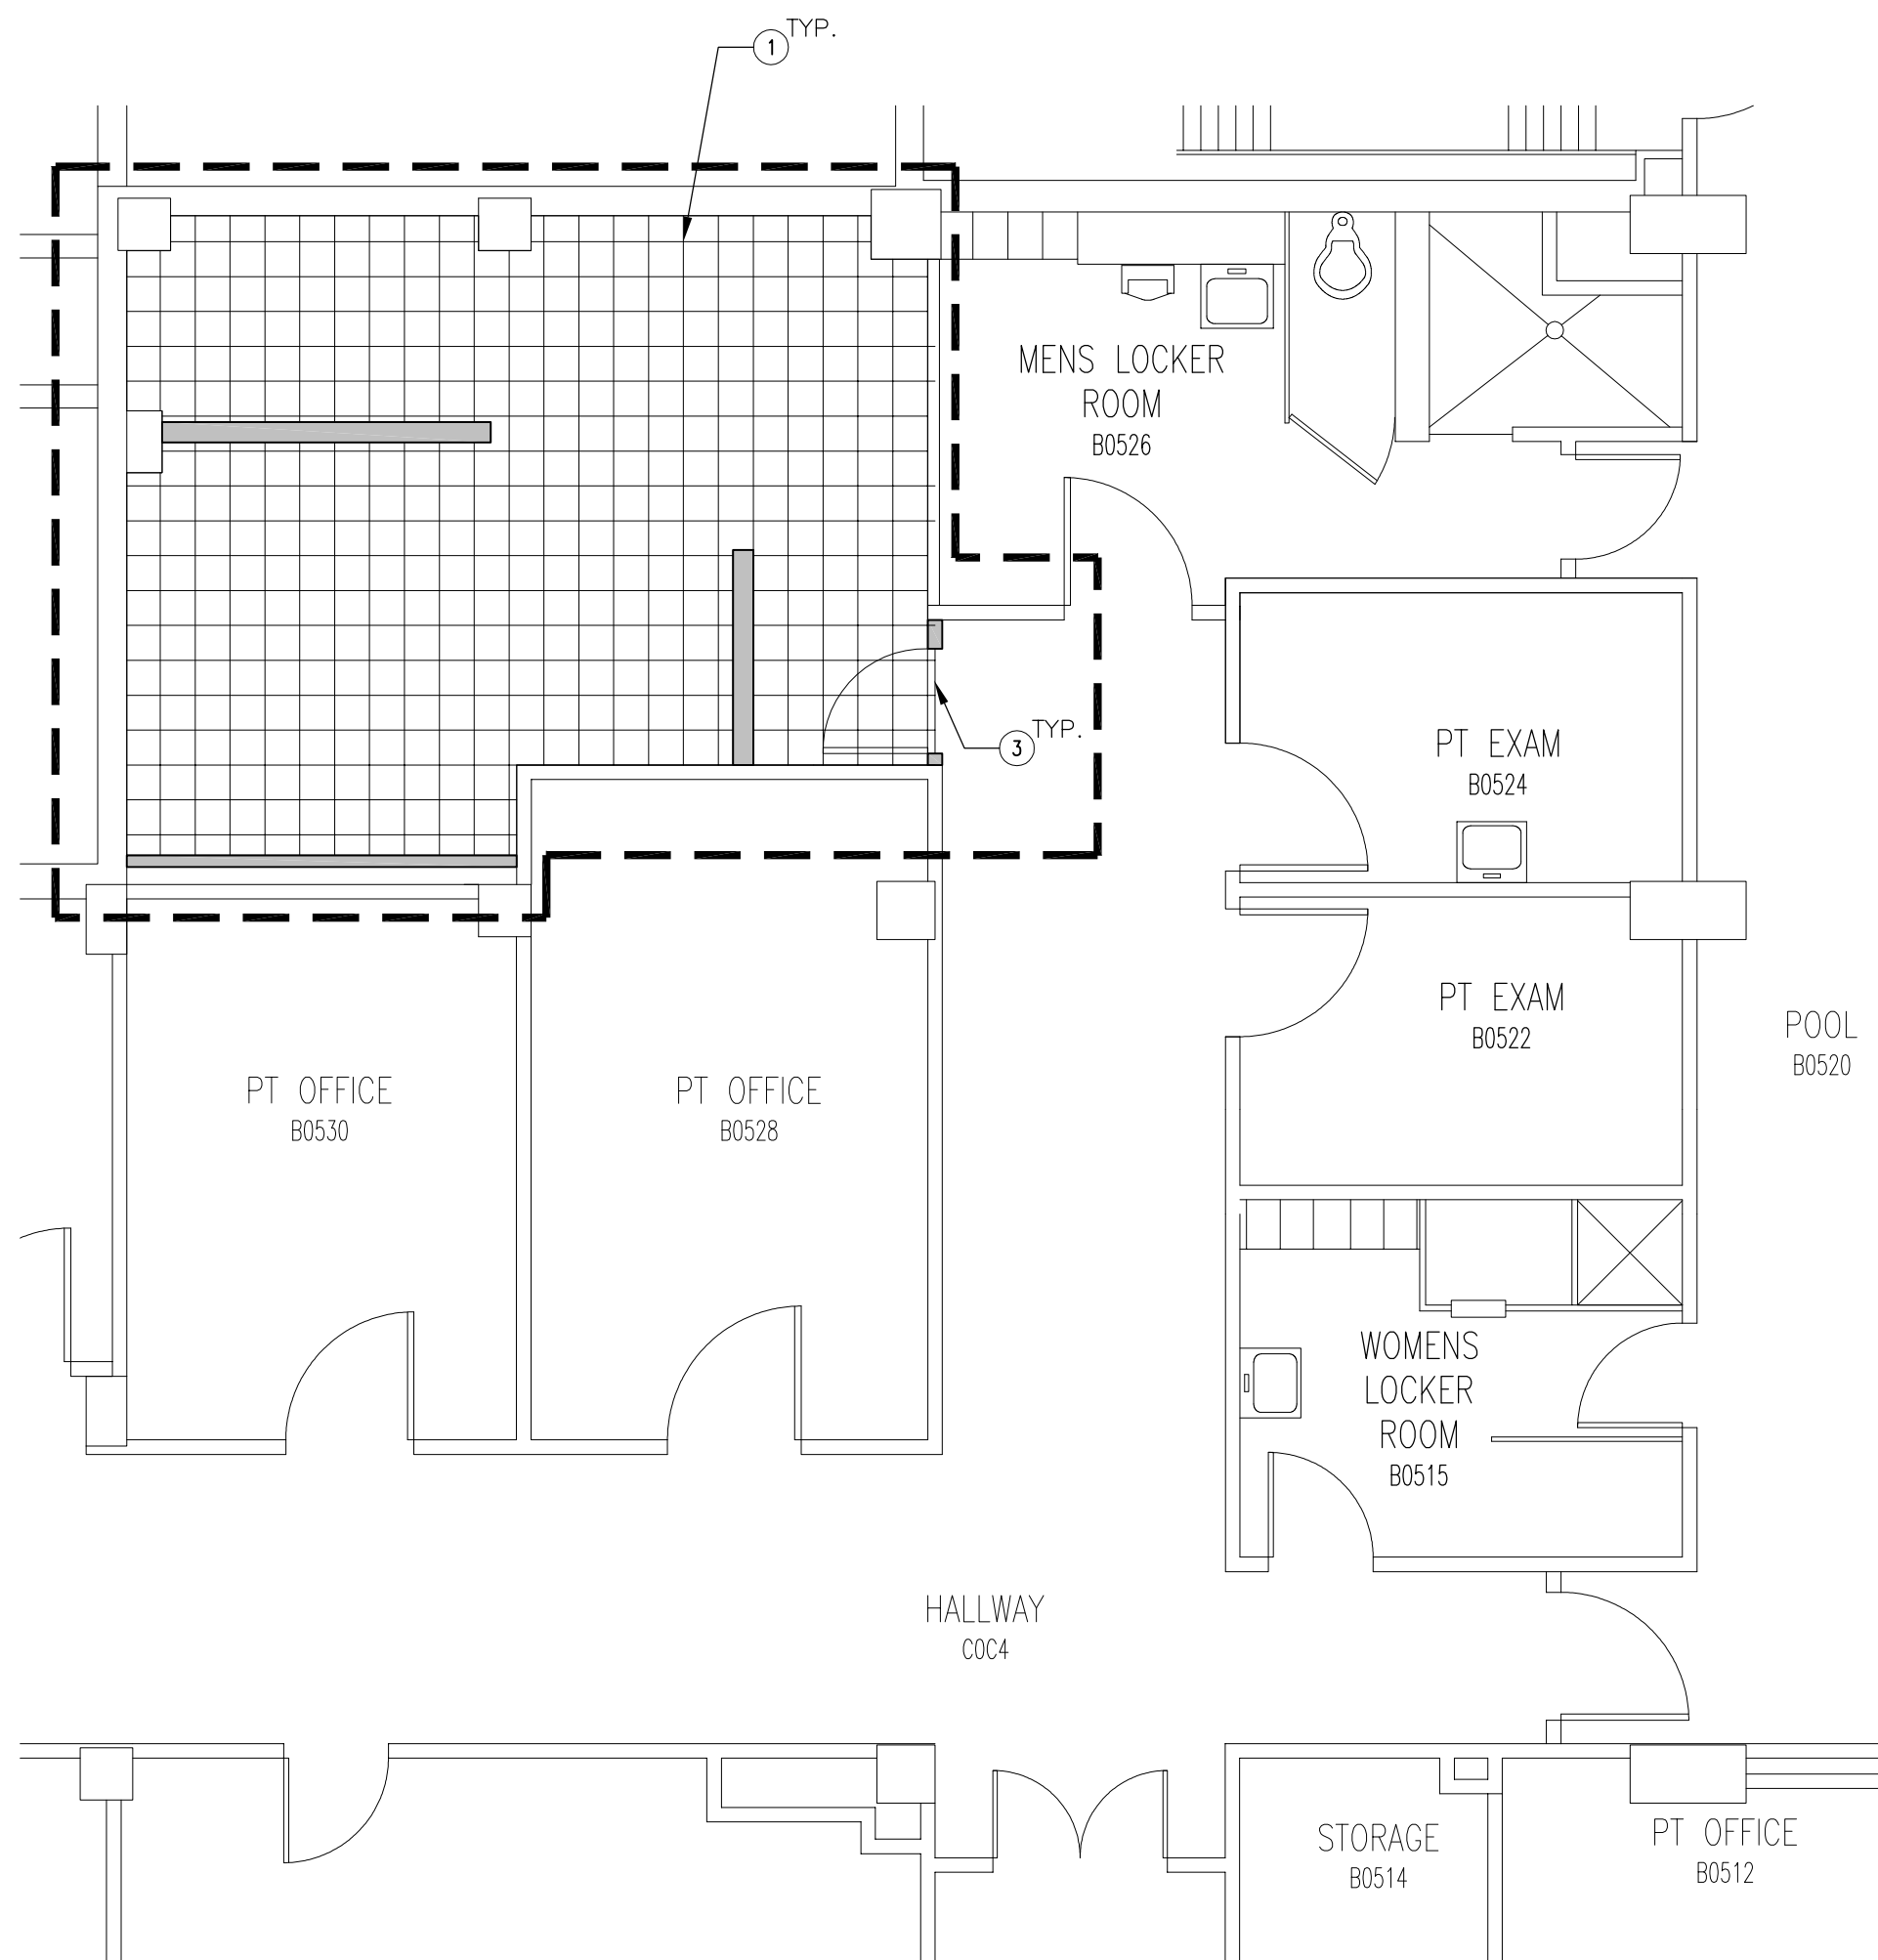

1 TILE PLAN - PHASE 1
3/16" = 1'-0"

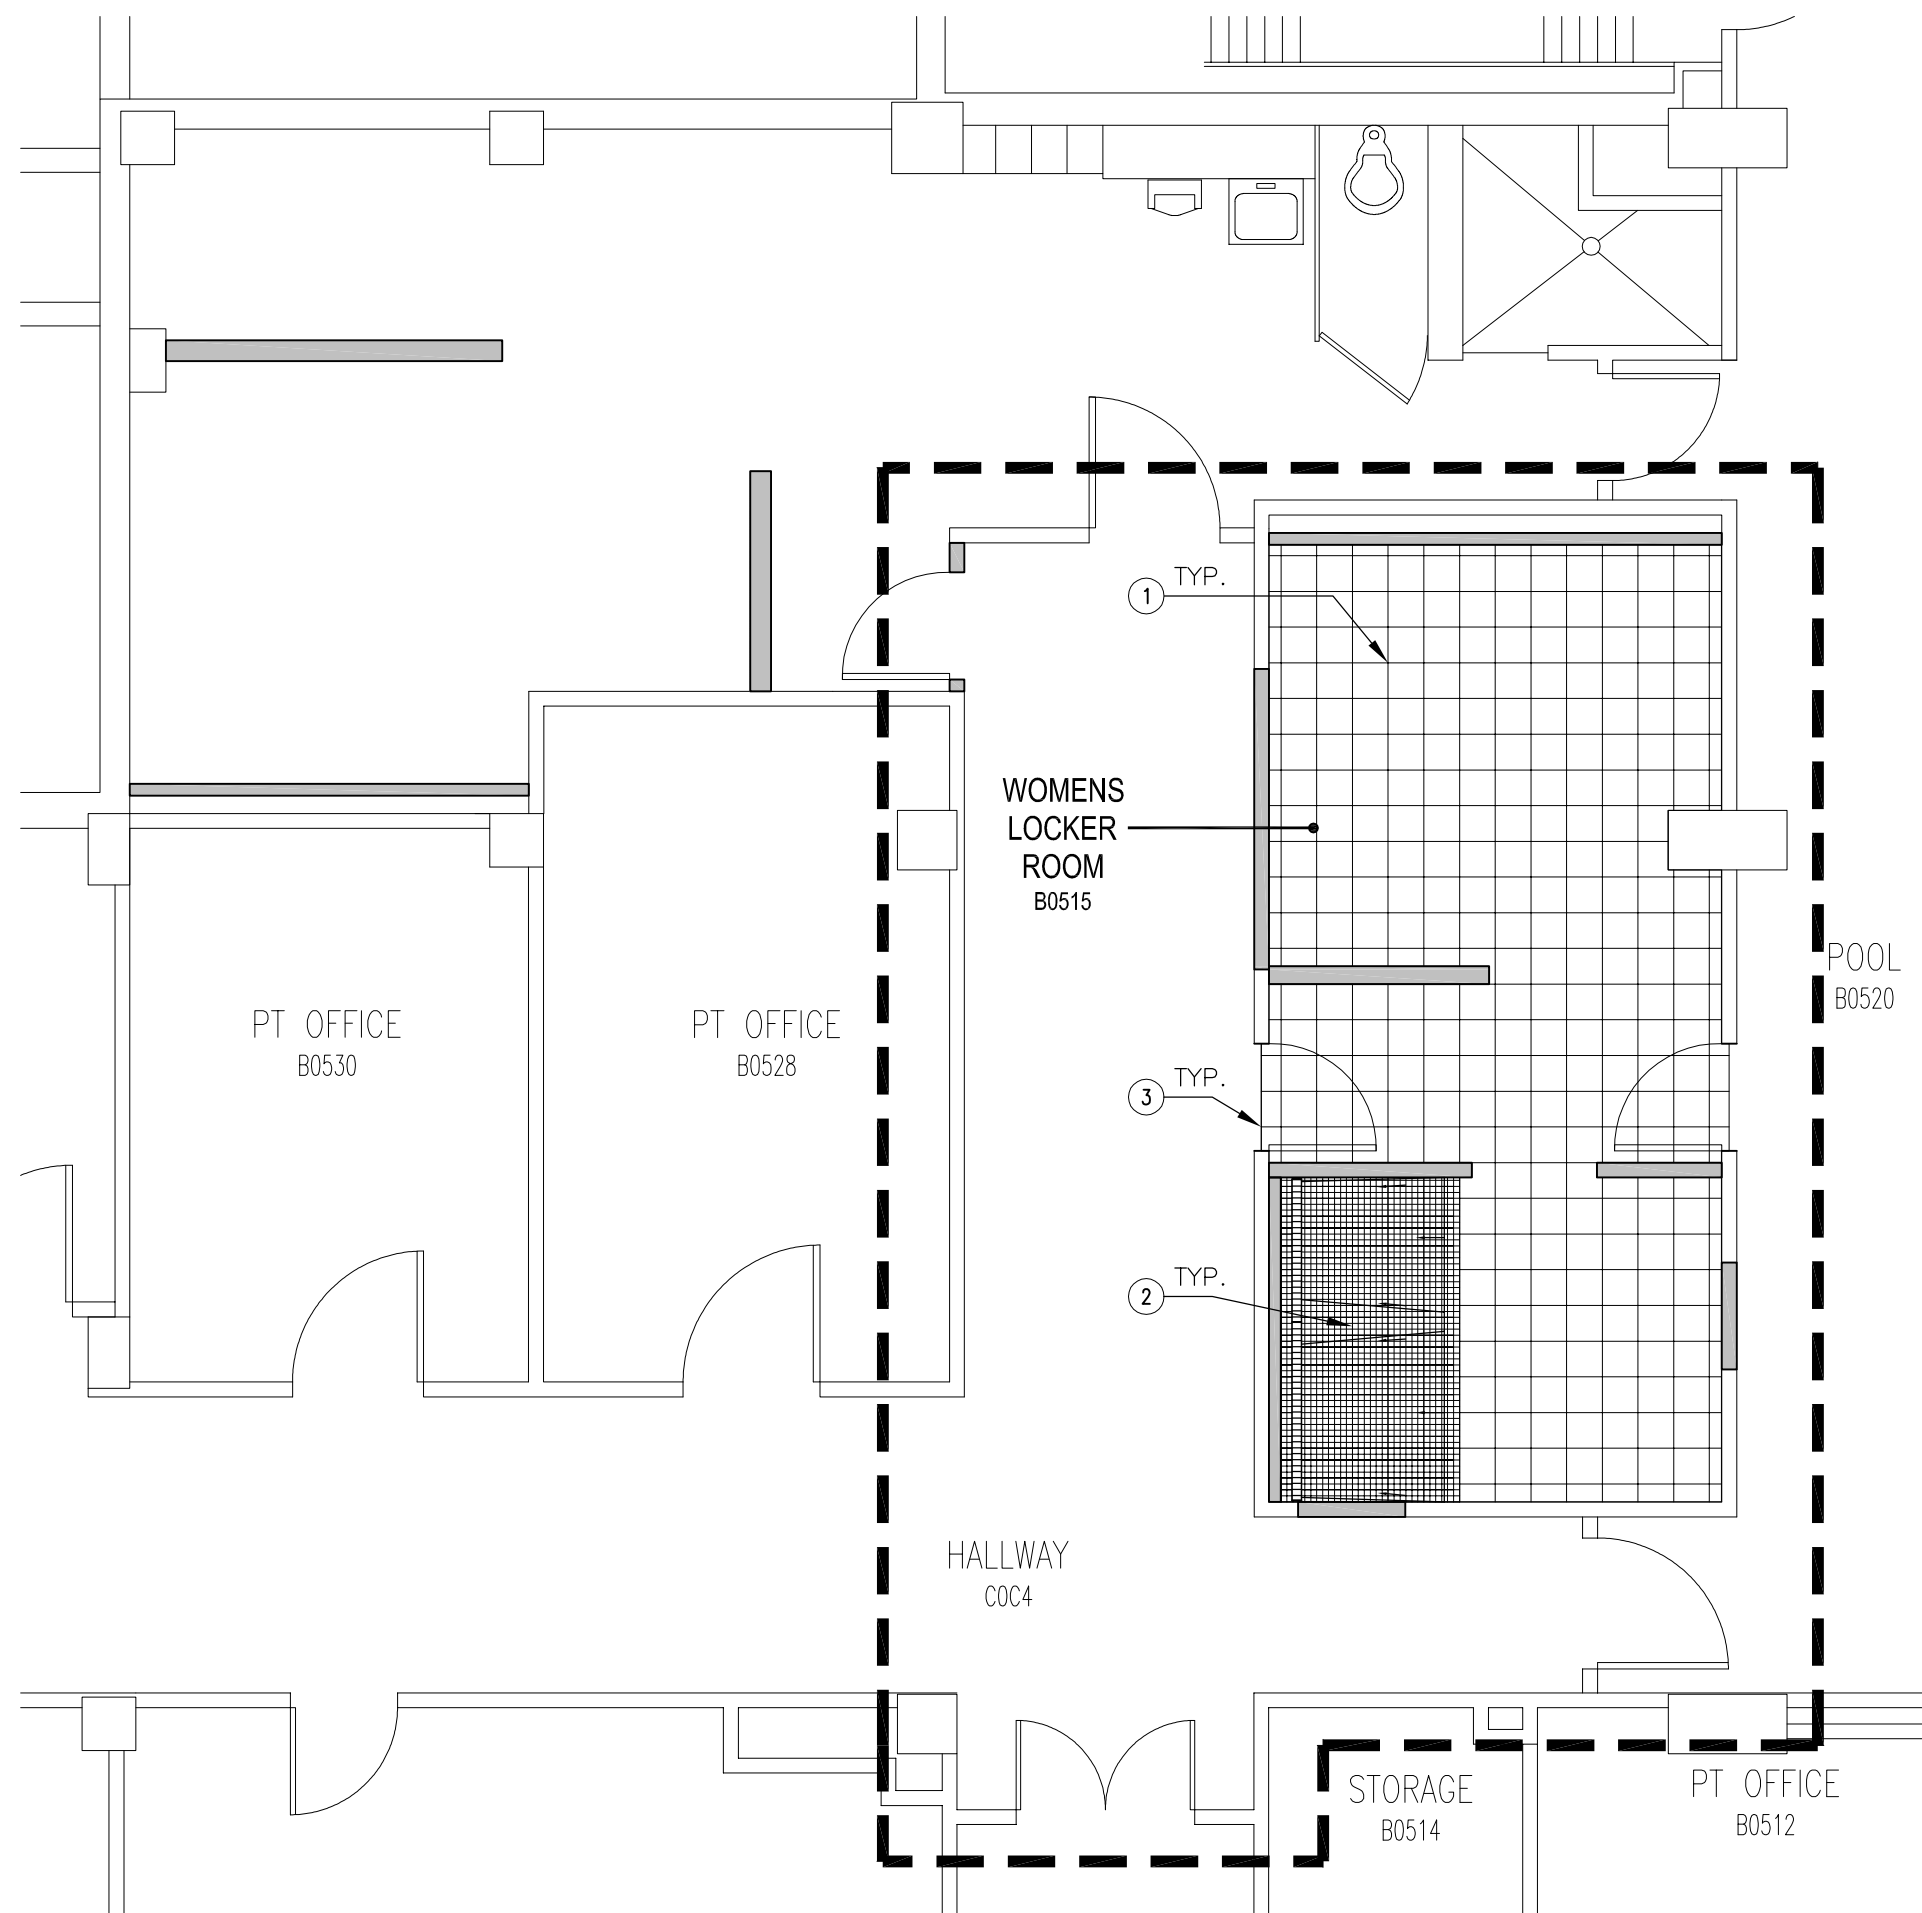

2 TILE PLAN - PHASE 2
3/16" = 1'-0"


PLAN KEY NOTES

- CT-5, 12" X 12" TILE WITH 6" X 12" COVE BASE AND 3/4" GROUT. SEE SHEET ID-101 FOR FINISH SCHEDULE. TILE PATTERN IS BASED ON DESIGN INTENT. CONTRACTOR TO PROVIDE SHOP DRAWINGS PRIOR TO INSTALLATION OF ANY TILE FOR VA APPROVAL.
- CT-6, 2 X 2 MOSAIC TILE WITH 6" X 12" COVE BASE AND 3/4" GROUT. SEE SHEET ID-101 FOR FINISH SCHEDULE AND SHEET A-101 PLAN KEY NOTE #11. TILE PATTERN IS BASED ON DESIGN INTENT. CONTRACTOR TO PROVIDE SHOP DRAWINGS PRIOR TO INSTALLATION OF ANY TILE FOR VA APPROVAL.
- PROVIDE SCHLUTER EDGE BETWEEN TILE AND CORRIDOR FLOORING PER MANUFACTURERS SPECIFICATIONS.

GENERAL NOTES

- REFER TO DETAIL PLANS FOR ADDITIONAL PARTITION INFORMATION, SEE SHEET A-000.
- INTERIOR DIMENSIONS ARE TO FINISH FACE TO FINISH FACE U.N.O.
- INSTALL 5/8" TYPE X GYPSUM WALL BOARD AND ACOUSTICAL INSULATION IN ALL ROOMS, FINISH TO GRADE #5.
- ALL SWITCHES, THERMOSTATS, AND OTHER ENVIRONMENTAL CONTROLS SHALL BE MOUNTED AT 40" A.F.F., TELEPHONE AND POWER OUTLETS SHALL BE AT 18" AFF. THESE CONTROLS SHALL BE LINED UP AT THE SAME HEIGHT AND WHERE MORE THAN ONE ARE ADJACENT, THEY SHALL BE EVENLY SPACED. GROUP MULTIPLE DEVICES IN A SINGLE COVER PLATE WHERE POSSIBLE.
- VERIFY ALL UTILITIES AND CONNECTION LOCATIONS.
- ALL PENETRATIONS IN RATED WALLS, SHALL BE RATED, TESTED ASSEMBLIES AS REQUIRED BY CODE.
- SEAL ALL PENETRATIONS IN SMOKE BARRIERS IN ACCORDANCE WITH CODES AND REQUIREMENTS.
- CONTRACTOR SHALL VERIFY ALL EXISTING CONDITIONS AND DIMENSIONS PRIOR TO BEGINNING CONSTRUCTION.
- CORNER GUARDS ARE REQUIRED AT ALL OUTSIDE CORNERS, SOME LOCATIONS MAY NOT BE INDICATED ON DRAWINGS. SEE THIS SHEET FOR ADDITIONAL LOCATIONS.
- REPLACE DOORS, LOCKS, KICK PLATES, CLOSER, BUMPER GUARDS, DOOR STOPS, AND HARDWARE, SEE SHEET A-000. RESTORE DOOR FRAME TO SMOOTH FINISH AND REPAINT.
- ALL WALL HUNG CASEWORK, SHELVING AND EQUIPMENT ATTACHED TO WALLS SHALL BE ANCHORED BETWEEN STUDS.
- REFER TO INTERIOR FLOOR FINISH PLAN, THIS SHEET.
- REFER TO INTERIOR WALL FINISH PLAN, THIS SHEET.
- REFER TO INTERIOR SIGNAGE PLAN, SHEET A-000.
- VERIFY FIELD DIMENSIONS, COORDINATE ACTUAL DIMENSIONS WITH CONTRACTOR AND VA.
- SUBMIT CONCRETE AND STEEL SHOP DRAWINGS INDICATING ACTUAL FILED DIMENSIONS, CONTRACTOR RESPONSIBLE TO DIMENSION OF STRUCTURE TO FIT EXISTING CONDITIONS.
- WALL TYPES SEE A-000
- DIMENSIONS ON FLOOR PLAN ARE BASED ON FACE OF FINISHED WALL TO FACE OF FINISHED WALL (NOMINAL), U.N.O.
- VERIFY ALL DIMENSIONS AND CONDITIONS AT JOB SITE. PORTIONS OF EXISTING CONSTRUCTION MAY HAVE BEEN REMOVED BY OWNER.
- MAINTAIN CONTINUOUS UTILITY SERVICE TO ALL SPACES IN THE BUILDING NOT AFFECTED BY THIS WORK. COORDINATE WITH OWNER ANY DISRUPTION IN SERVICES REQUIRED TO PERFORM WORK OR TO MODIFY EXISTING PIPING, DUCTWORK OR ANY ASSOCIATED EQUIPMENT.
- REFER TO THIS SHEET FOR FINISH AND MATERIAL SCHEDULE.
- REFER TO SHEET A-000 FOR DOOR SCHEDULE, DOOR TYPES, HARDWARE AND NOTES.


GRAPHIC LEGEND

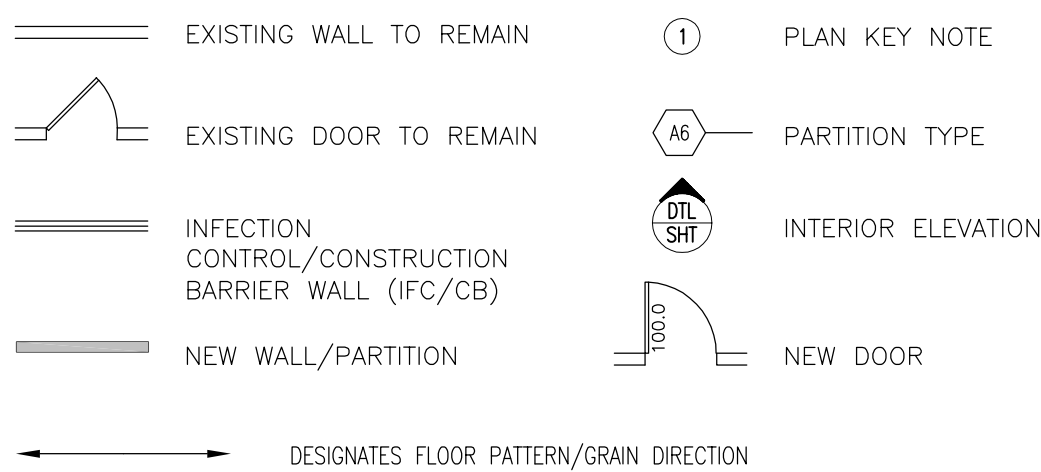

FINISH PLAN GENERAL NOTES

- PRIOR TO FLOORING INSTALLATION, SCHEDULE A PRE-INSTALLATION CONFERENCE ON SITE WITH INTERIOR DESIGNER/ARCHITECT TO COORDINATE LAYOUT.
- RESILIENT BASE PROFILE TO BE COVED ON HARD SURFACE FLOORING AND STRAIGHT ON CARPET.
- EPDXY FLOORING TO BE COVED 6" ABOVE FLOORING. PROVIDE ALUMINUM TOP CAP WITH CLEAR SILICONE BEAD.
- PROVIDE A FLUSH TRANSITION BETWEEN DIFFERENT FLOORING MATERIALS OF VARYING HEIGHTS. PROVIDE TRANSITION STRIPS AS NECESSARY. INTERIOR DESIGNER TO SELECT COLOR FROM MANUFACTURER'S FULL COLOR LINE.
- VINYL COMPOSITION TILE TO BE INSTALLED TO MATCH EXISTING CONDITION.
- FOR EACH SHEET VINYL PRODUCT SPECIFIED, PROVIDE MANUFACTURER'S RECOMMENDED MATCHING WELD ROD. SUBMIT SAMPLE TO ARCHITECT FOR APPROVAL.
- REFER TO THIS SHEET FOR FINISH SCHEDULE.
- REFER TO SHEET 11/ID-102 FOR TYPICAL TILE PATTERN AT SHOWER AND 13/ID-102 WALL CONDITIONS. REFER TO FINISH SCHEDULE ON SHEET A-000 FOR SPECIFICATIONS.
- AT ALL LOCATIONS WHERE NEW FLOOR FINISH MEETS EXISTING FLOOR FINISH, THE CONTRACTOR SHALL FLASH PATCH OR GRIND THE EXISTING FLOOR AS NECESSARY TO ALLOW FOR FINISHES TO BE FLUSH.

KEY PLAN

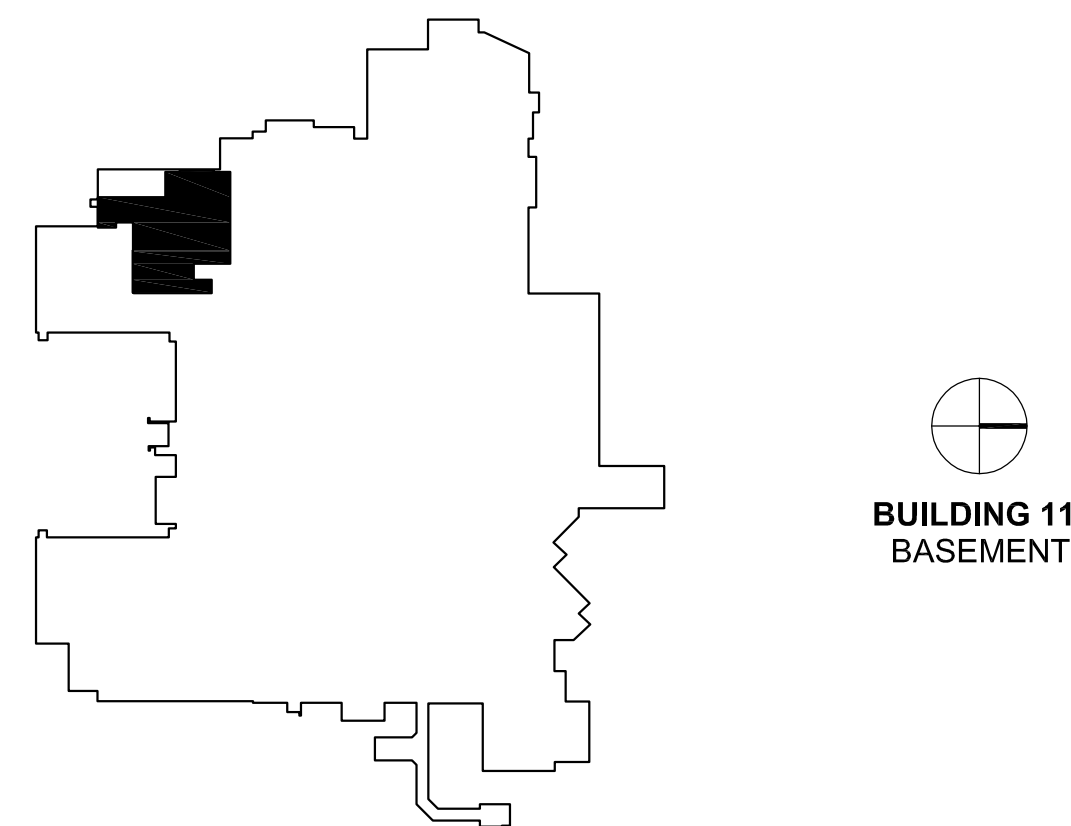

BUILDING 111
BASEMENT



ARCHITECT:

CLEMENT J. ZABLOCKI VA MEDICAL CENTER
OFFICE OF CONSTRUCTION AND FACILITIES MANAGEMENT

Drawing Title

PHASE 1 - 3: TILE FLOOR PATTERN

Approved: Project Director

Troy Martinson, PE

Project Title

111 Upgrade Pool Locker
Rooms

Location

VA Medical Center, Milwaukee, WI

Date

August 28, 2015

Checked

Drawn

AJ

Project Number

695-14-114

Building Number

Building 111

Drawing Number


ID-103

Office of
Construction
and Facilities
Management




Department of
Veterans Affairs


three inches = one foot
one and one half inches = one foot
one inch = one foot
three quarters inch = one foot
three eighths inch = one foot
one half inch = one foot
one quarter inch = one foot
one eighth inch = one foot

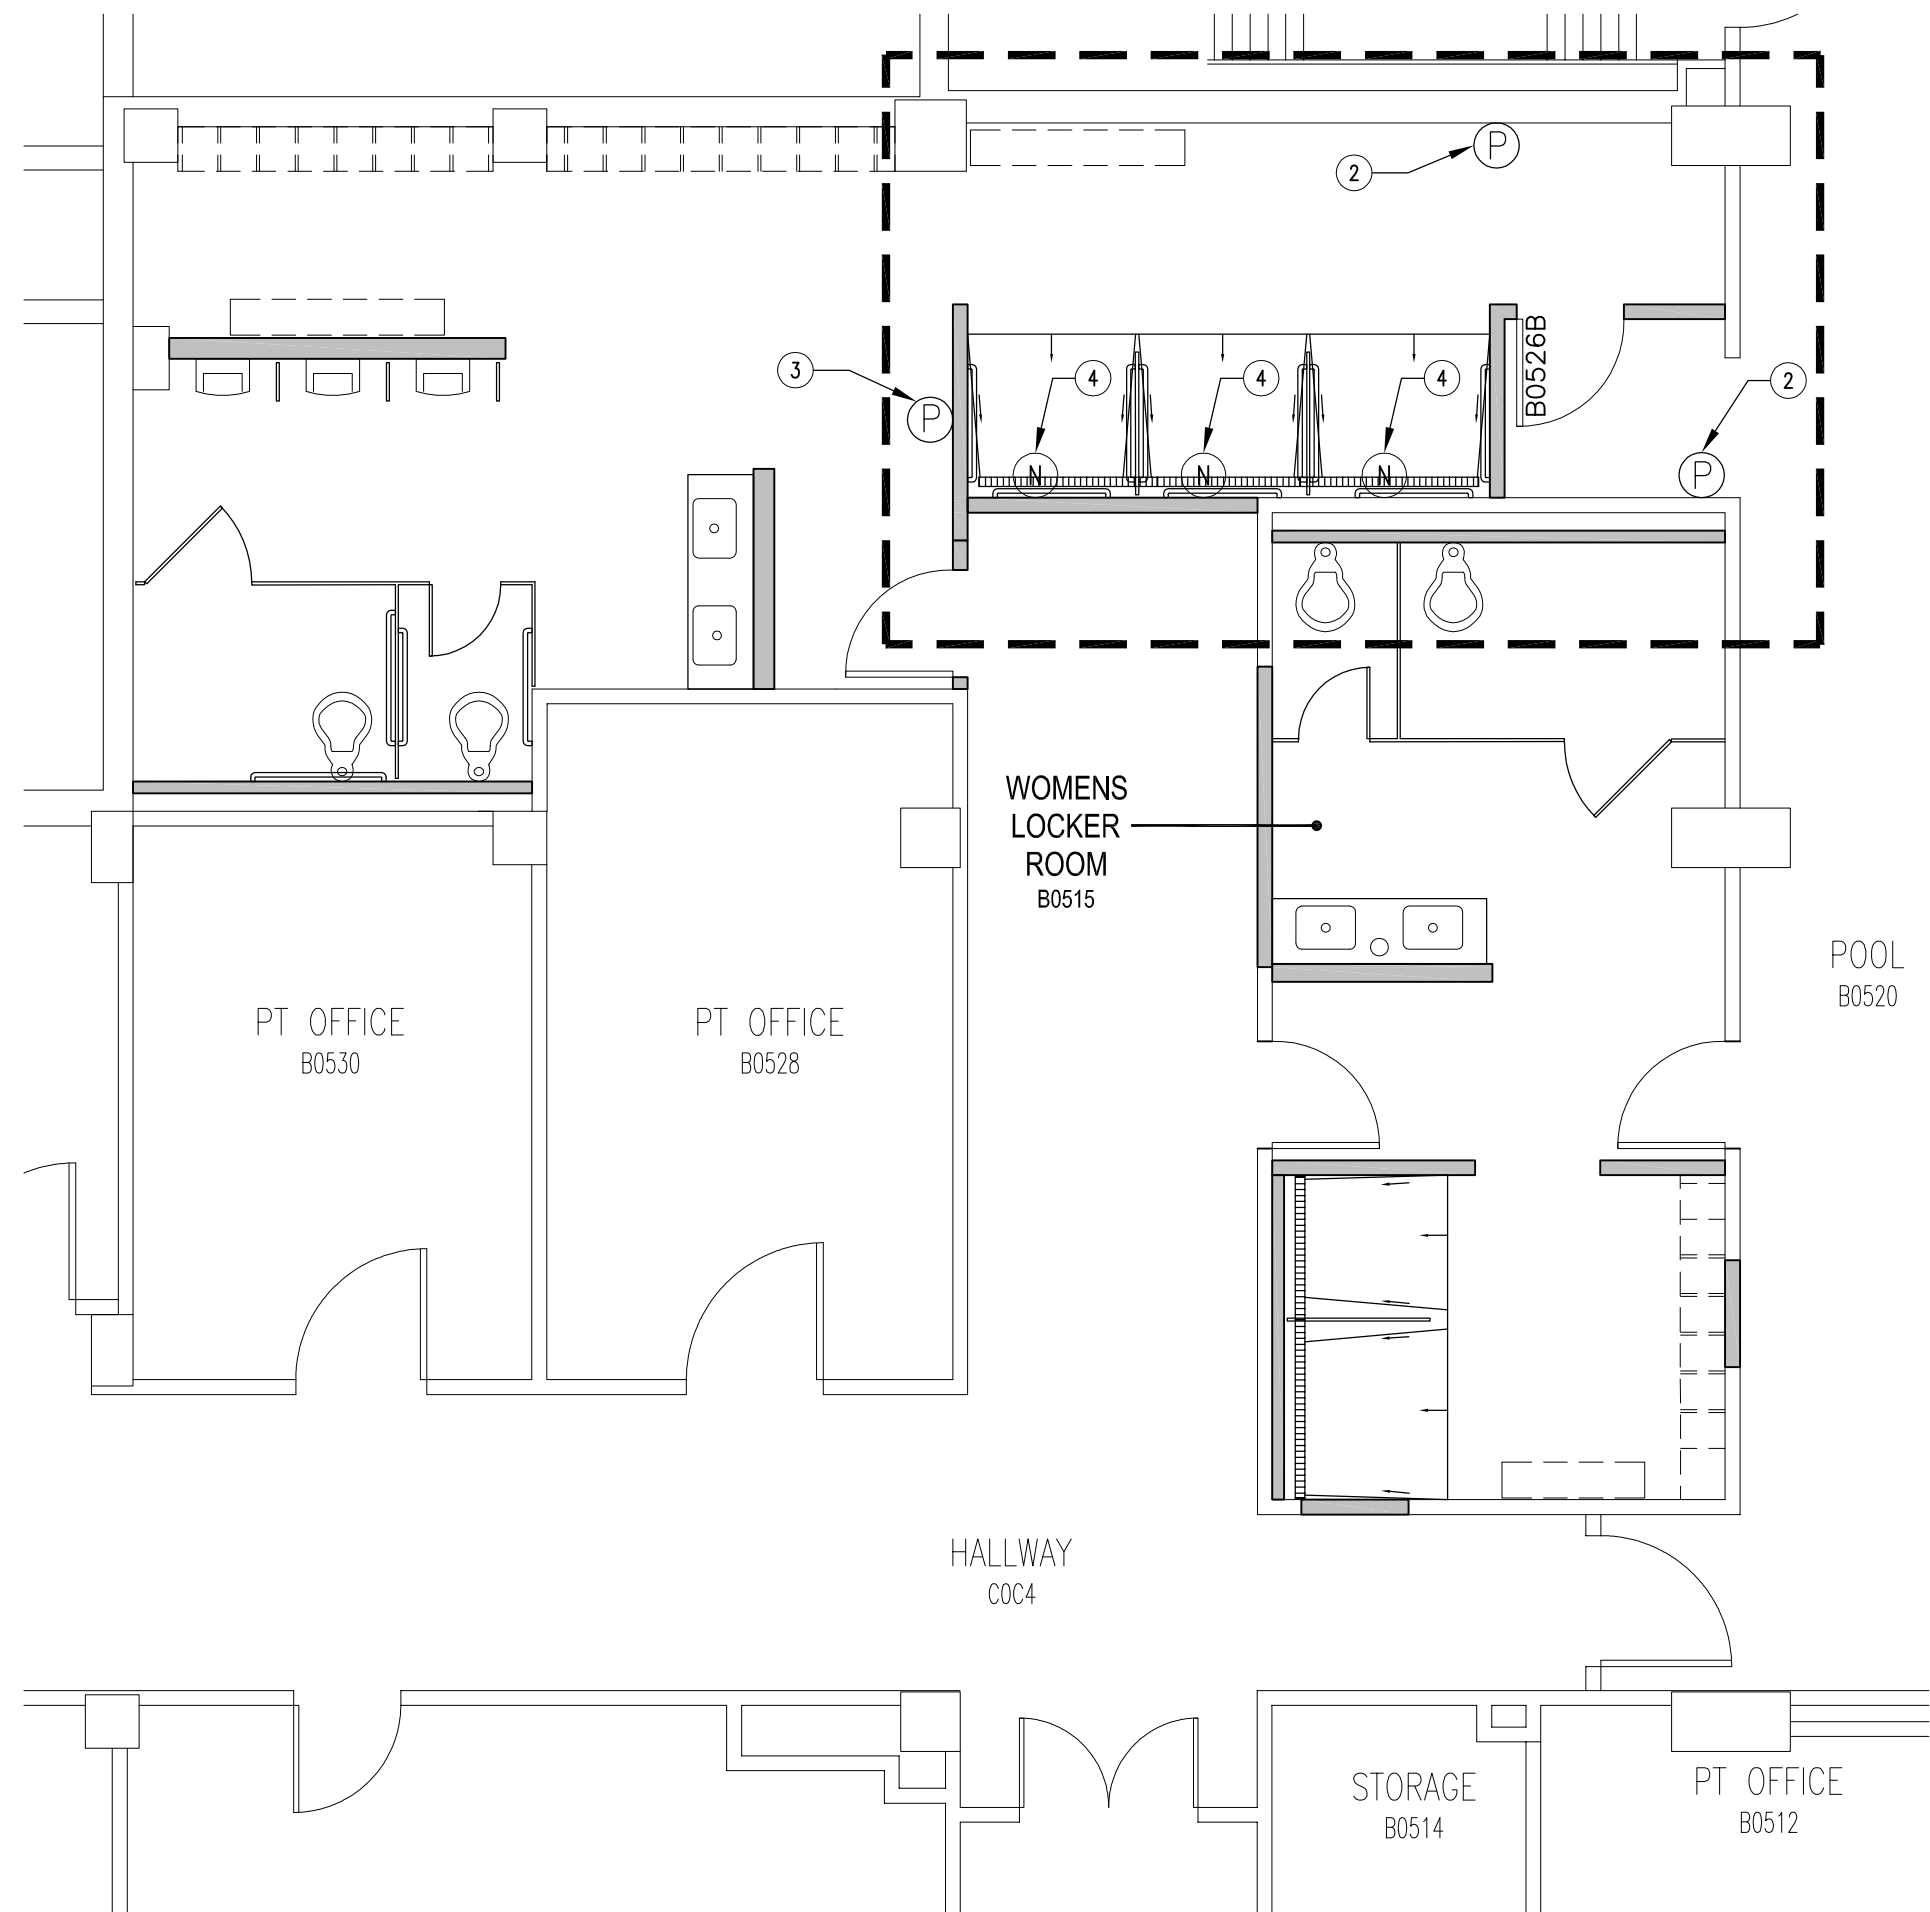

3 PLAN - PHASE 3
3/16" = 1'-0"

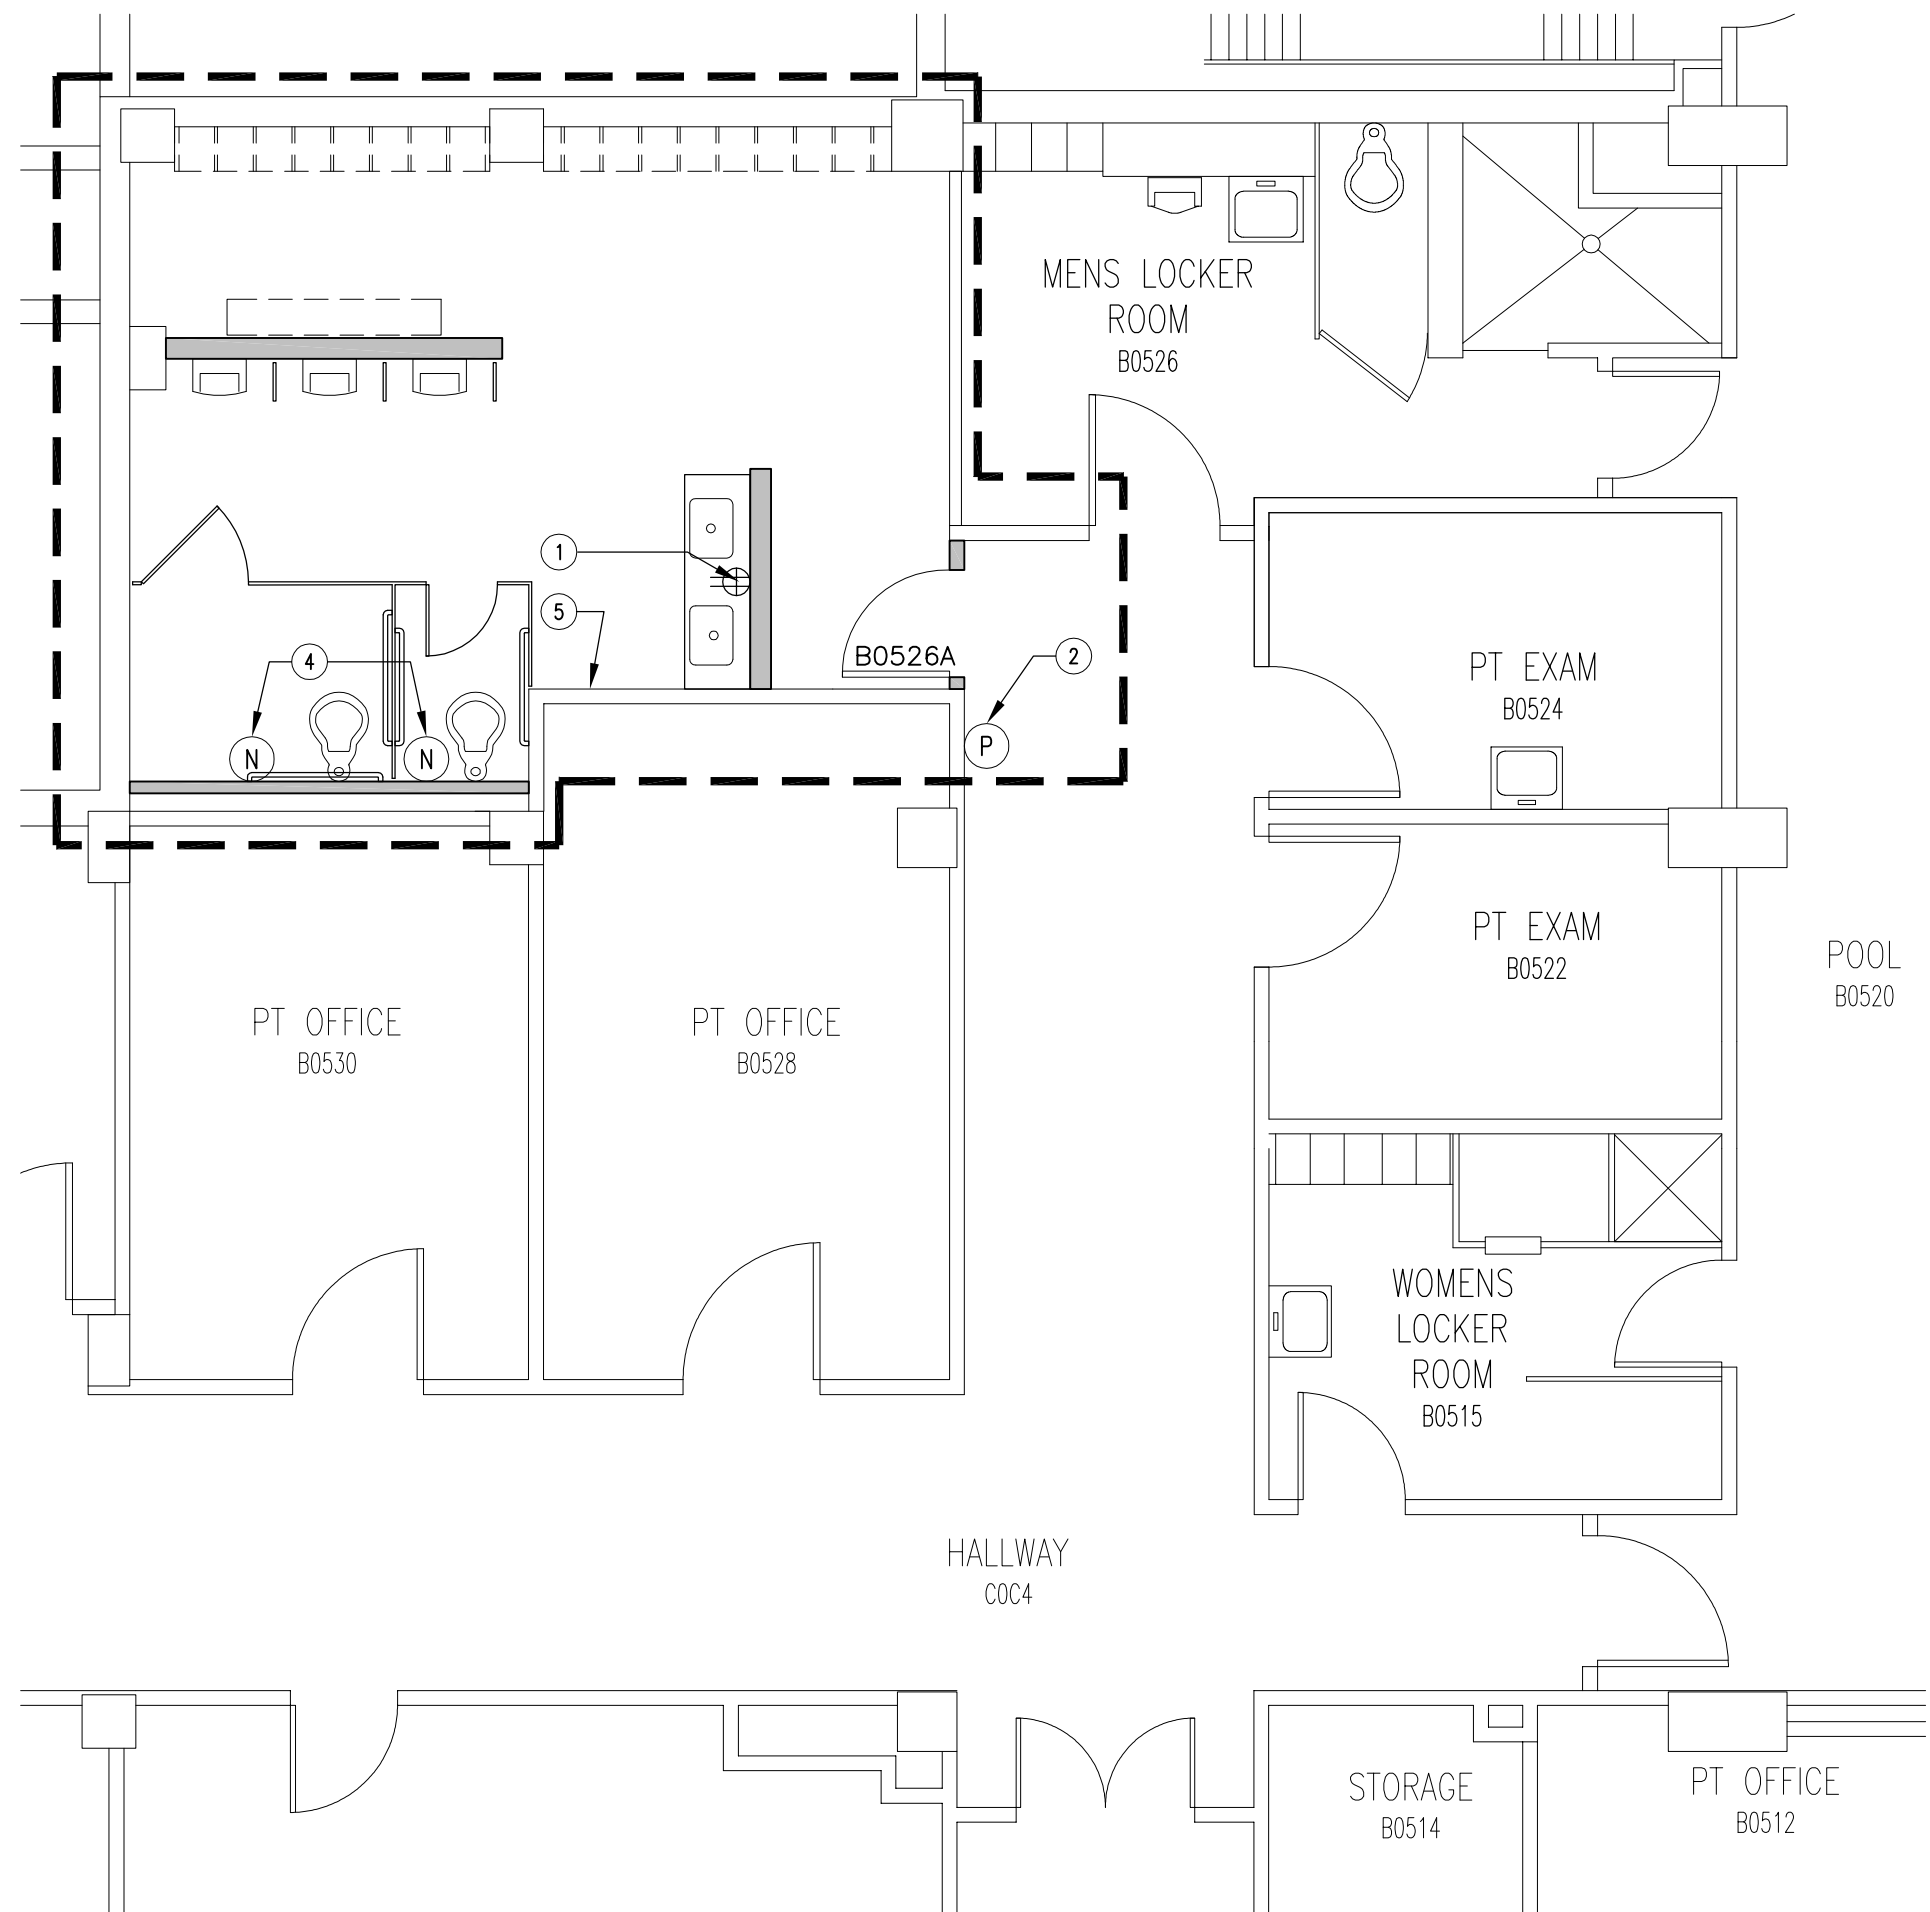

1 PLAN - PHASE 1
3/16" = 1'-0"

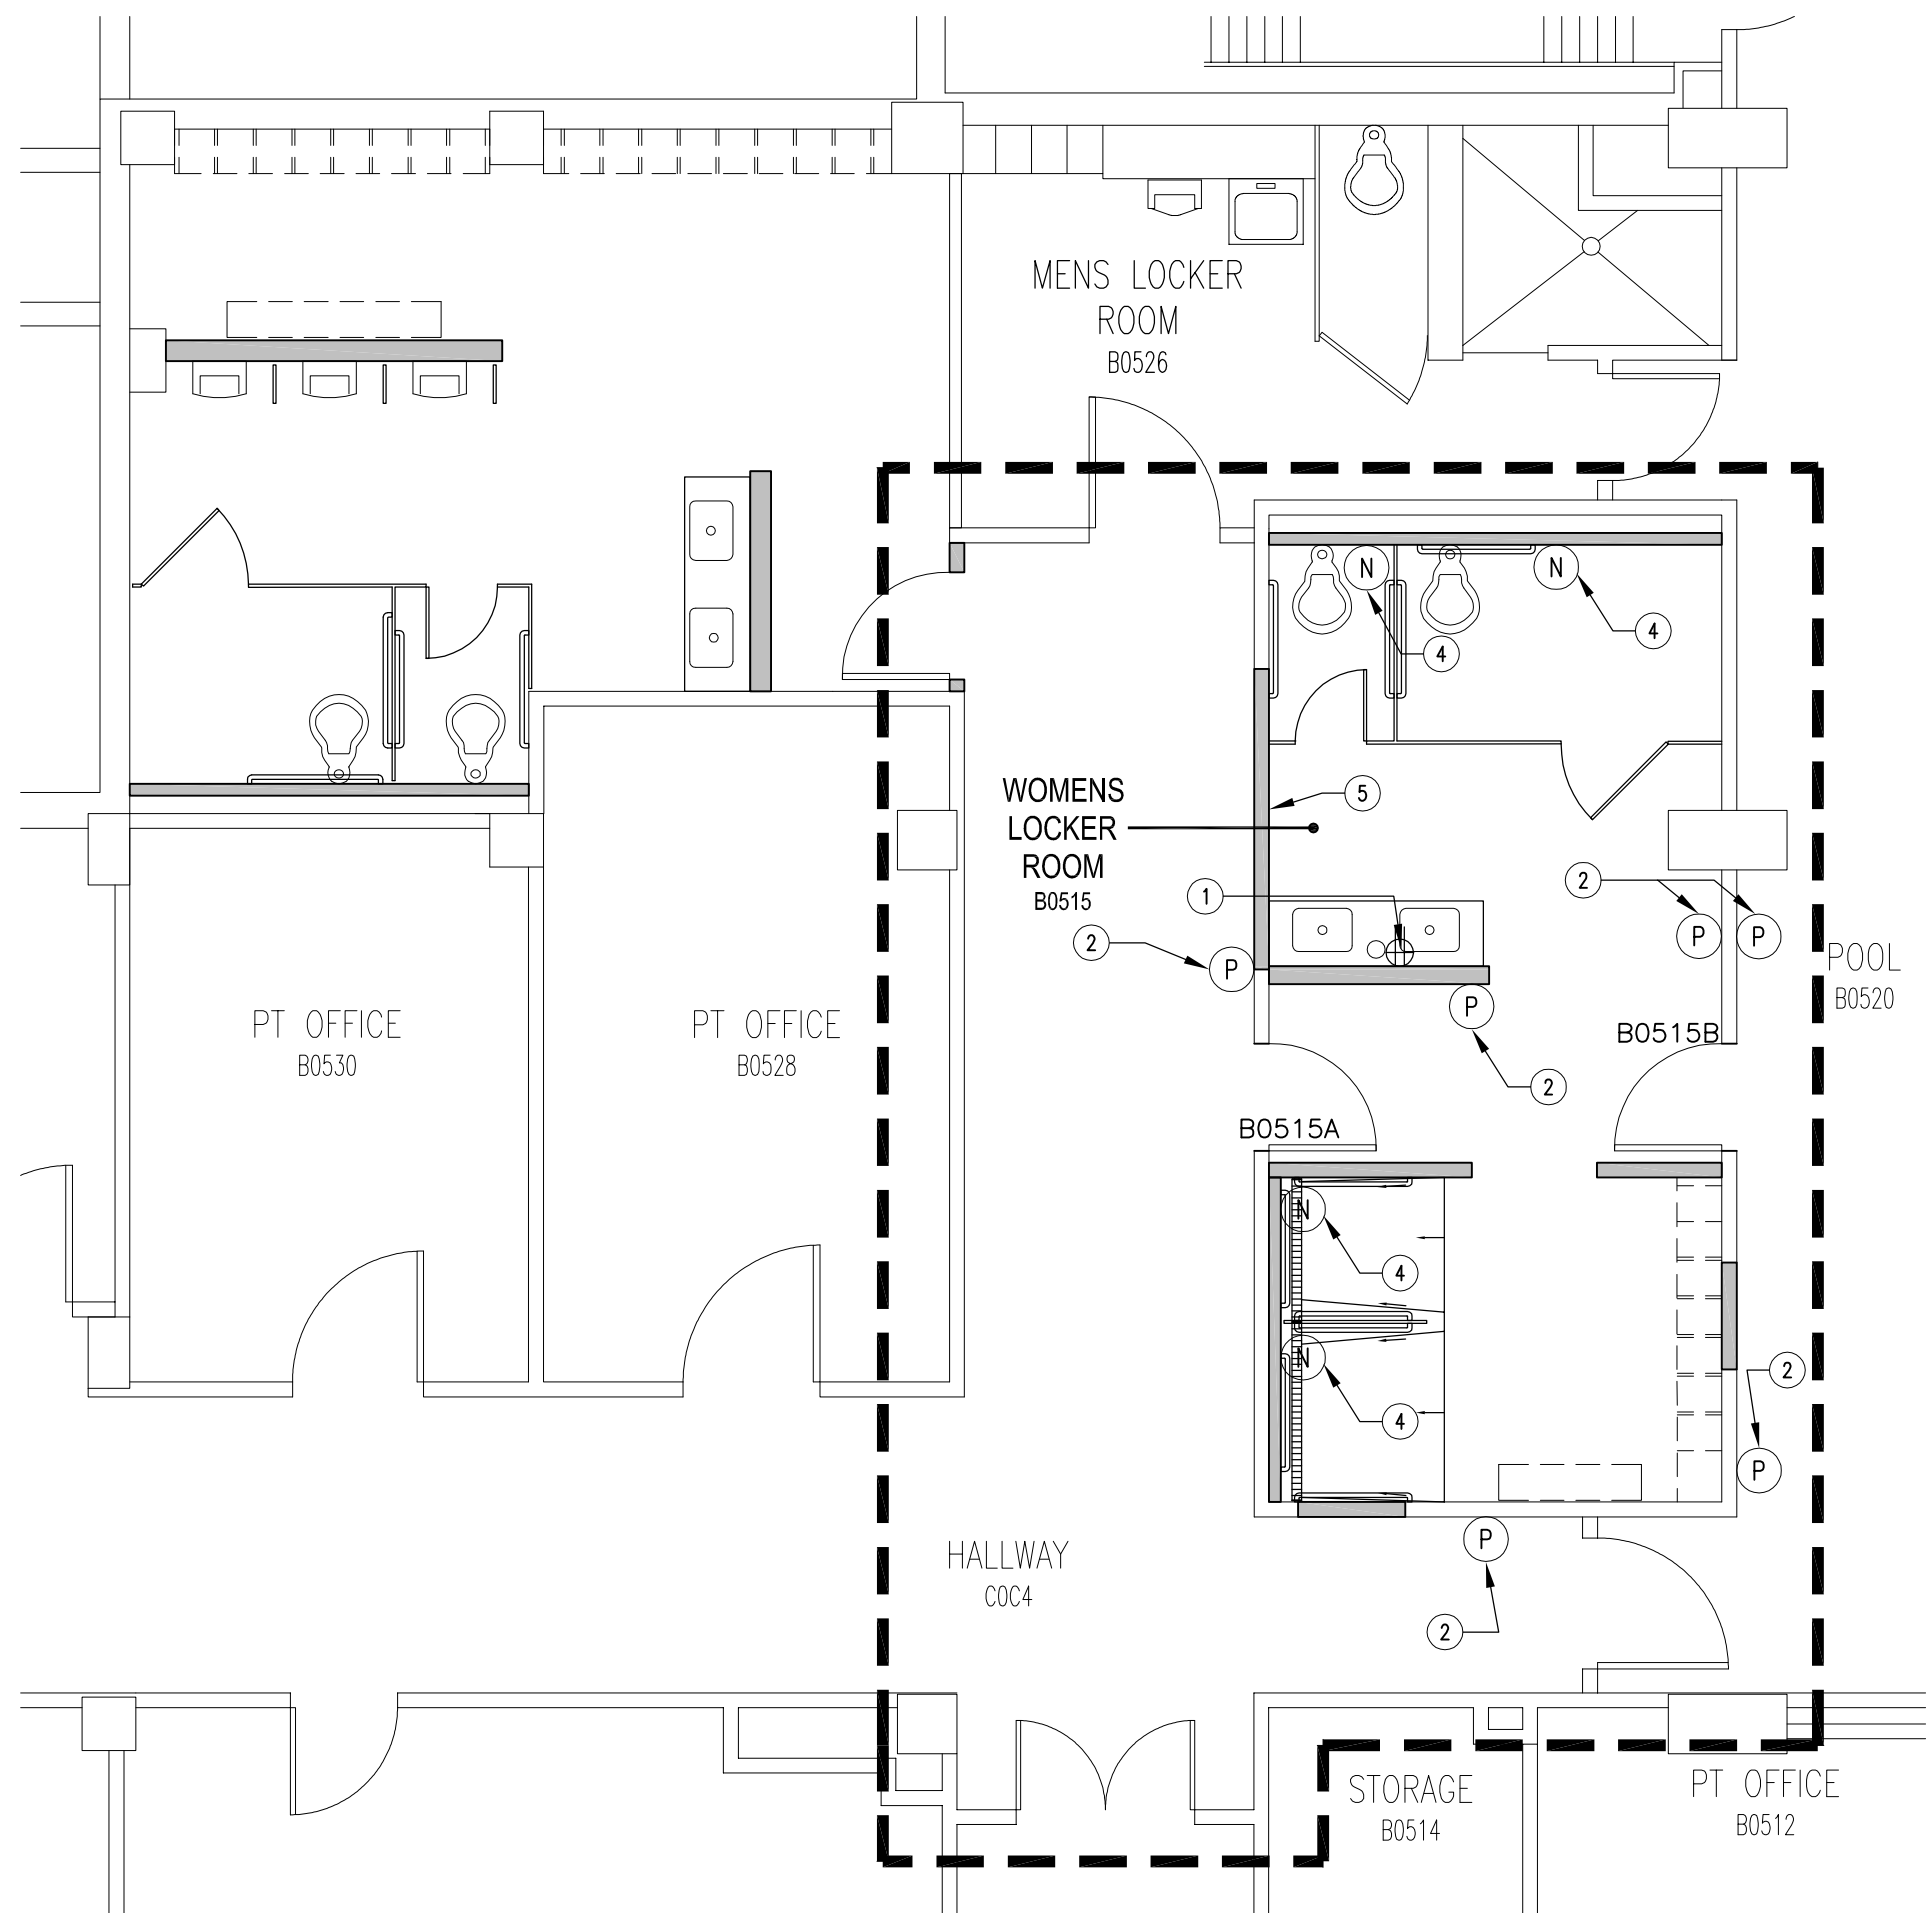

2 PLAN - PHASE 2
3/16" = 1'-0"

GRAPHIC LEGEND

- EXISTING WALL TO REMAIN
- EXISTING DOOR TO REMAIN
- INFECTION CONTROL/CONSTRUCTION BARRIER WALL (IC/CB)
- NEW WALL/PARTITION
- NEW WALL OR CEILING MOUNTED NURSE CALL BUTTON
- NEW SWITCH
- PLAN KEY NOTE
- PARTITION TYPE
- INTERIOR ELEVATION
- NEW DOOR
- NEW WALL MOUNTED ADA AUTOMATIC DOOR OPENER PUSH PLATE - EXACT LOCATION DURING MEP OUTLET BOX WALK-THROUGH
- NEW IVORY RECEPTACLE, DUPLEX WITH GROUND FAULT CIRCUIT INTERRUPTER, HOSPITAL GRADE


PLAN KEY NOTES

- PROVIDE (1) GFI DUPLEX OUTLET ABOVE FINISHED MILLWORK. SEE SHEET ID-102 FOR LOCATION. CONTRACTOR TO PROVIDE OUTLET LABEL SEE SHEET A-000/6. CONTRACTOR TO COORDINATE PRECISE LOCATION WITH MILLWORK PRIOR TO INSTALLATION.
- PROVIDE AUTOMATIC DOOR OPENER ON BOTH PUSH AND PULL SIDE. SEE DOOR SCHEDULE ON SHEET A-000. COORDINATE PRECISE LOCATION WITH VA PRIOR TO INSTALLATION.
- PROVIDE AUTOMATIC DOOR OPENER FOR DOOR B0526A WHICH WAS INSTALLED IN PHASE 1. SEE DOOR SCHEDULE ON SHEET A-000. COORDINATE PRECISE LOCATION WITH VA PRIOR TO INSTALLATION.
- PROVIDE NURSE CALL BUTTON. SEE SHEET ID-102 FOR PRECISE LOCATION.
- RELOCATED EXISTING HAND DRYER. CONTRACTOR TO ENSURE IN PROPER WORKING ORDER AND INSTALL ALL REQUIRED ELECTRICAL WIRING AND CONDUIT TO NEAREST ELECTRICAL PANEL. COORDINATE PRECISE LOCATION WITH VA PRIOR TO ROUGH-IN.
- ALL ELECTRICAL WORK SHALL BE INSTALLED IN STRICT ACCORDANCE WITH THE APPLICABLE ADDITIONS OF NATIONAL ELECTRIC CODE, THE STATE BUILDING CODE, AND OTHER LOCAL, STATE OR FEDERAL CODES, ORDINANCES, OR AUTHORITY INTERPRETATIONS THAT MAY APPLY. A CERTIFICATE OF FINAL ELECTRICAL INSPECTION SHALL BE OBTAINED BY THE CONTRACTOR AT THE COMPLETION OF THE WORK AND PRESENTED TO THE RESIDENT ENGINEER.
- THE CONTRACTOR SHALL FURNISH AND INSTALL COMPLETE AND SATISFACTORY OPERATING SYSTEMS AS INDICATED ON THE CONTRACT DOCUMENTS. IT IS NOTED THAT THE DRAWINGS ARE DIAGRAMMATIC AND INDICATE GENERAL ARRANGEMENTS OF SYSTEMS AND WORK. CIRCUIT NUMBERS, INTERCONNECTIONS, HOME RUNS AND SWITCH LEGS HAVE BEEN SHOWN AND THE CONTRACTOR SHALL FURNISH AND INSTALL CONDUIT AND WIRING AS REQUIRED TO ACCOMPLISH THE FUNCTIONS INDICATED. SPECIAL SYSTEMS DEVICES (FIRE ALARM, COMMUNICATIONS, AND SECURITY) HAVE BEEN SHOWN AND THE CONTRACTOR SHALL FURNISH AND INSTALL THE REQUIRED QUANTITIES AND TYPES OF CABLES, CONDUCTORS, RACEWAY, REMOTE POWER SUPPLIES, AND CONNECTIONS, SHIELDING REQUIREMENTS, AND ETC., AS REQUIRED BY THE SYSTEM MANUFACTURER, THE SPECIFICATIONS, AND ANY APPLICABLE CODES. ALL WIRING SHOWN ON ONE-LINE OR RISER SHALL BE FURNISHED AND INSTALLED REGARDLESS OF WHETHER THESE ITEMS ARE SHOWN ON THE PLANS.
- THE CONTRACTOR SHALL COORDINATE THE ELECTRICAL WORK WITH THE WORK OF ALL OTHER TRADES AND EXISTING CONDITIONS SO AS TO AVOID CONFLICTS. RESOLVE ALL CONFLICTS THROUGH THE RESIDENT ENGINEER PRIOR TO ROUGH-IN. FAILURE TO PROVIDE SUCH COORDINATION PRIOR TO BEING INSTALLED SHALL NOT BE CAUSE FOR ADDITIONAL COMPENSATION TO THE CONTRACTOR, AND MAY RESULT IN REJECTION OF THE WORK. IT IS THE CONTRACTORS RESPONSIBILITY TO COORDINATE SUBSTITUTIONS WITH OTHER TRADES.
- ALL MATERIALS SHALL BE NEW, SHALL BE SUITABLE FOR THE APPLICATION INTENDED AND SHALL BEAR LABELS OR MARKINGS INDICATING THIRD PARTY TESTING LABORATORY LISTINGS ACCEPTABLE TO THE AUTHORITY HAVING JURISDICTION UNLESS OTHERWISE NOTED.
- VERIFY LOCATIONS OF WIRING DEVICES IN FURNISHED SPACES, MILLWORK, AND CASEWORK WITH THE ARCHITECTURAL DRAWINGS, DETAILS AND ELEVATIONS AND WITH THE OWNERS EQUIPMENT LAYOUT PRIOR TO ROUGH-IN. DEVICE BOXES SHALL NOT BE INSTALLED BACK TO BACK.
- ALL WIRING FOR POWER AND LIGHTING SYSTEMS SHALL BE INSTALLED IN METALLIC RACEWAY SYSTEMS UNLESS OTHERWISE NOTED. ALL CONDUCTORS SHALL BE COPPER, SHALL BE #12 AWG MINIMUM, AND SHALL HAVE 600V TYPE THHN/THWN INSULATION, UNLESS OTHERWISE NOTED. ALL RACEWAYS AND CIRCUITS SHALL INCLUDE INSULATED GROUND CONDUCTORS SIZED AS INDICATED OR AS REQUIRED BY THE NEC. MINIMUM RACEWAY SIZE SHALL BE 1" UNLESS OTHERWISE NOTED.
- RACEWAYS SHALL NOT CONTAIN MORE THAN THREE PHASE CONDUCTORS, THREE NEUTRALS, AND ONE GROUND CONDUCTOR, UNLESS OTHERWISE NOTED. CONTRACTOR SHALL PROVIDE SEPARATE NEUTRALS FOR ALL 20A/1P CIRCUIT BREAKERS, PROVIDING MULTI-POLE CIRCUIT BREAKERS IN CONJUNCTION WITH SHARED NEUTRALS IN A MULTI-WIRE CIRCUIT IN ACCORDANCE WITH NEC 210.4 SHALL BE APPROVED BY THE RESIDENT ENGINEER.
- EXPOSED RACEWAY UP TO 8'-0" AFF OR GRADE OR ELEVATION OR ANY RACEWAY SUBJECT TO DAMAGE SHALL BE RMC.
- ALL CONNECTIONS FOR ELECTRICALLY POWERED EQUIPMENT, INCLUDING BUT NOT LIMITED TO MECHANICAL AND OWNER SUPPLIED EQUIPMENT, SHALL BE FURNISHED AND INSTALLED. WHERE NOT INDICATED AS TO BE PROVIDED WITH THE EQUIPMENT, ALL REQUIRED DISCONNECTING MEANS SHALL BE FURNISHED AND INSTALLED AS PART OF THE ELECTRICAL WORK. COORDINATE LOCATIONS OF DISCONNECTING AND CONTROLLING MEANS WITH EQUIPMENT TO MAINTAIN CODE AND INSTALLATION REQUIREMENTS.
- ALL RACEWAY SHALL BE CONCEALED IN FURNISHED SPACES AND MAY BE INSTALLED EXPOSED IN MECHANICAL AND ELECTRICAL ROOMS OR AS INDICATED. ALL RACEWAY AND WIRING WHETHER CONCEALED OR EXPOSED SHALL BE RUN EITHER PERPENDICULAR OR PARALLEL TO THE BUILDING'S STRUCTURAL COMPONENTS.
- PROVIDE PULL AND JUNCTION BOXES AS REQUIRED TO MEET CODE AND INSTALLATION REQUIREMENTS. PULL AND JUNCTION BOXES SHALL BE CONCEALED IN FURNISHED SPACES AND LOCATIONS SHALL BE COORDINATED WITH THE WORK OF ALL OTHER TRADES SO AS TO AVOID CONFLICTS.
- ALL CONDUCTORS SHALL BE IDENTIFIED AT EACH JUNCTION BOX, OUTLET BOX, CABINET, PULL BOX ETC. WITH VINYL SELF ADHESIVE TAGS INDICATING PANEL AND CIRCUIT NUMBER, CONTROL WIRE IDENTIFICATION NUMBER, OR OTHER APPROPRIATE INFORMATION. ALL PULL AND JUNCTION BOXES SHALL BE LABELED AS TO FUNCTION.
- ALL EQUIPMENT SHALL BE SECURELY FASTENED BY MEANS OF ANCHORS, RODS, HANGERS, SUPPORTS, GUIDES, SWAY BRACES AND ETC. TO MAINTAIN ALIGNMENT AND TO PREVENT EQUIPMENT MOVEMENT.
- ALL PENETRATION OF FIRE OR SMOKE RATED CONSTRUCTION SHALL BE SEALED WITH FIRE STOP MATERIALS APPROVED AND LISTED FOR THE RATING OF CONSTRUCTION TO BE PENETRATED. PROVIDE DOCUMENTATION FOR ALL SUCH PENETRATION SEALING SYSTEMS FOR VERIFICATION OF PROPER INSTALLATION.
- TO PREVENT PERSONNEL INJURY AND POTENTIAL SYSTEM FAILURE, ELECTRICAL WORK SHALL BE PERFORMED ON DE-ENERGIZED SYSTEMS ONLY. WHERE WORK ON EXISTING SYSTEMS WILL REQUIRE INTERRUPTION OF ELECTRICAL SERVICE, THEN TEMPORARY PROVISIONS ACCEPTABLE TO THE RESIDENT ENGINEER FOR TEMPORARY POWER SHALL BE UTILIZED UNTIL THE WORK IS COMPLETE.
- WHERE 20A, 120V LIGHTING AND POWER CIRCUIT LENGTHS EXCEED 150 FEET, PROVIDE #10, PHASE AND NEUTRAL CONDUCTORS WITH #10 GND IN MINIMUM 2" CONDUIT.
- ALL RECEPTACLES SHALL BE DUPLEX NEMA 5-20R AND UL LISTED AS HOSPITAL GRADE UNLESS OTHERWISE NOTED.
- INSTALL RECEPTACLE OUTLETS 18" AFF OR 6" ABOVE COUNTER TOP AS MEASURED TO THE CENTER OF THE BOX.
- PROVIDE ALL NEW WIRING, SWITCHES, RECEPTACLES, CONDUIT, J-BOXES, ITEMS MAY BE REUSED IF THEY MEET CODE AND ARE IN GOOD CONDITION.
- CONTRACTOR TO COORDINATE WITH VA FOR PANEL LOCATION OF NEW ELECTRICAL WORK.
- CONTRACTOR IS RESPONSIBLE FOR LOWERING ALL FIRE DETECTION SYSTEMS AND OTHER OPERATIONAL SYSTEMS TO THE NEW ACT OR GYPSUM BOARD CEILINGS.
- CONTRACTOR TO PROVIDE ELECTRICAL AND FIRE ALARM TE IN TO DOORS ON MAGNETIC HOLD OPEN - SEE DOOR SCHEDULE SHEET A-000. ALL WIRING TO BE FINISHED IN DRYWALL WALLS.
- CONTRACTOR TO PROVIDE ELECTRICAL OUTLET LABEL FOR OUTLETS AS DESCRIBED IN SPECIFICATIONS AND SHEET A-000/6.
- ALL MEP IS DESIGN BUILD.

ELECTRICAL GENERAL NOTES

- ALL ELECTRICAL WORK SHALL BE INSTALLED IN STRICT ACCORDANCE WITH THE APPLICABLE ADDITIONS OF NATIONAL ELECTRIC CODE, THE STATE BUILDING CODE, AND OTHER LOCAL, STATE OR FEDERAL CODES, ORDINANCES, OR AUTHORITY INTERPRETATIONS THAT MAY APPLY. A CERTIFICATE OF FINAL ELECTRICAL INSPECTION SHALL BE OBTAINED BY THE CONTRACTOR AT THE COMPLETION OF THE WORK AND PRESENTED TO THE RESIDENT ENGINEER.
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- THE CONTRACTOR SHALL COORDINATE THE ELECTRICAL WORK WITH THE WORK OF ALL OTHER TRADES AND EXISTING CONDITIONS SO AS TO AVOID CONFLICTS. RESOLVE ALL CONFLICTS THROUGH THE RESIDENT ENGINEER PRIOR TO ROUGH-IN. FAILURE TO PROVIDE SUCH COORDINATION PRIOR TO BEING INSTALLED SHALL NOT BE CAUSE FOR ADDITIONAL COMPENSATION TO THE CONTRACTOR, AND MAY RESULT IN REJECTION OF THE WORK. IT IS THE CONTRACTORS RESPONSIBILITY TO COORDINATE SUBSTITUTIONS WITH OTHER TRADES.
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- PROVIDE PULL AND JUNCTION BOXES AS REQUIRED TO MEET CODE AND INSTALLATION REQUIREMENTS. PULL AND JUNCTION BOXES SHALL BE CONCEALED IN FURNISHED SPACES AND LOCATIONS SHALL BE COORDINATED WITH THE WORK OF ALL OTHER TRADES SO AS TO AVOID CONFLICTS.
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- TO PREVENT PERSONNEL INJURY AND POTENTIAL SYSTEM FAILURE, ELECTRICAL WORK SHALL BE PERFORMED ON DE-ENERGIZED SYSTEMS ONLY. WHERE WORK ON EXISTING SYSTEMS WILL REQUIRE INTERRUPTION OF ELECTRICAL SERVICE, THEN TEMPORARY PROVISIONS ACCEPTABLE TO THE RESIDENT ENGINEER FOR TEMPORARY POWER SHALL BE UTILIZED UNTIL THE WORK IS COMPLETE.
- WHERE 20A, 120V LIGHTING AND POWER CIRCUIT LENGTHS EXCEED 150 FEET, PROVIDE #10, PHASE AND NEUTRAL CONDUCTORS WITH #10 GND IN MINIMUM 2" CONDUIT.
- ALL RECEPTACLES SHALL BE DUPLEX NEMA 5-20R AND UL LISTED AS HOSPITAL GRADE UNLESS OTHERWISE NOTED.
- INSTALL RECEPTACLE OUTLETS 18" AFF OR 6" ABOVE COUNTER TOP AS MEASURED TO THE CENTER OF THE BOX.
- PROVIDE ALL NEW WIRING, SWITCHES, RECEPTACLES, CONDUIT, J-BOXES, ITEMS MAY BE REUSED IF THEY MEET CODE AND ARE IN GOOD CONDITION.
- CONTRACTOR TO COORDINATE WITH VA FOR PANEL LOCATION OF NEW ELECTRICAL WORK.
- CONTRACTOR IS RESPONSIBLE FOR LOWERING ALL FIRE DETECTION SYSTEMS AND OTHER OPERATIONAL SYSTEMS TO THE NEW ACT OR GYPSUM BOARD CEILINGS.
- CONTRACTOR TO PROVIDE ELECTRICAL AND FIRE ALARM TE IN TO DOORS ON MAGNETIC HOLD OPEN - SEE DOOR SCHEDULE SHEET A-000. ALL WIRING TO BE FINISHED IN DRYWALL WALLS.
- CONTRACTOR TO PROVIDE ELECTRICAL OUTLET LABEL FOR OUTLETS AS DESCRIBED IN SPECIFICATIONS AND SHEET A-000/6.
- ALL MEP IS DESIGN BUILD.


KEY PLAN

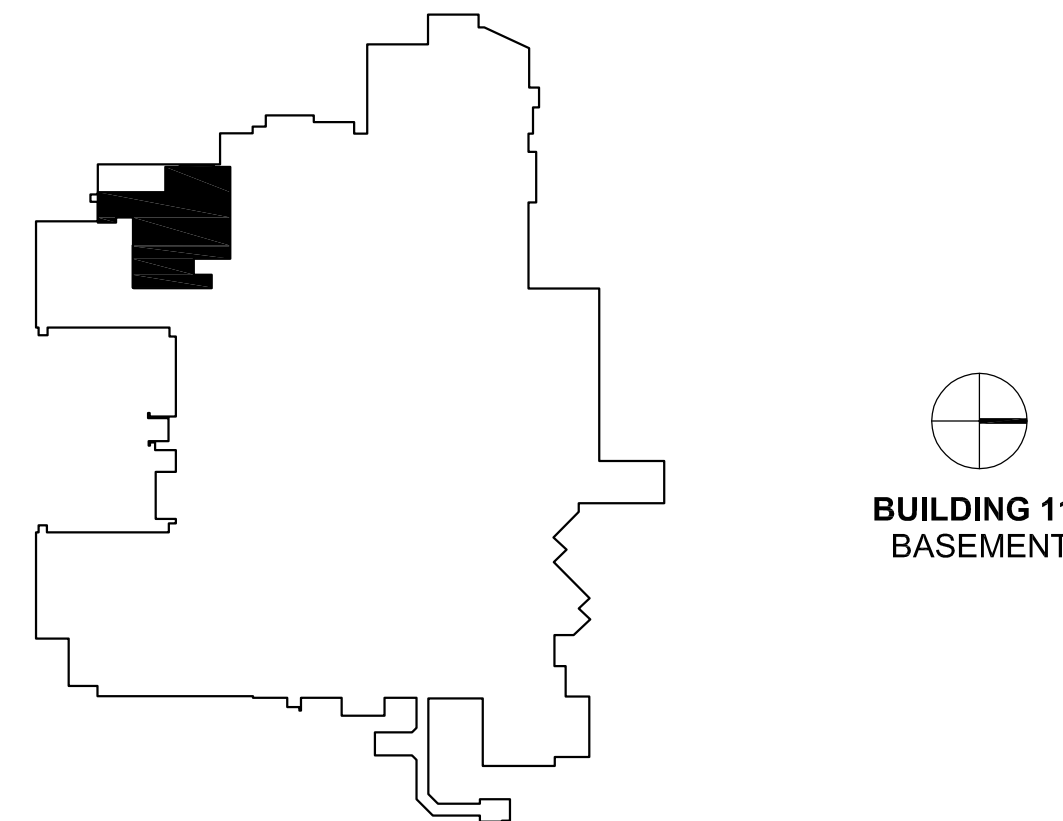


BUILDING 111
BASEMENT

| | | | | | | | |
|-----------|------|---|---|---|--|--|--|
| Revisions | Date | Dept. of Veterans Affairs Medical Center 5000 W. National Avenue Milwaukee, WI | ARCHITECT: CLEMENT J. ZABLOCKI VA MEDICAL CENTER OFFICE OF CONSTRUCTION AND FACILITIES MANAGEMENT | Drawing Title PHASE 1 - 3: ELECTRICAL POWER PLANS Approved: Project Director Troy Martinson, PE | Project Title 111 Upgrade Pool Locker Rooms Location VA Medical Center, Milwaukee, WI Date August 28, 2015 Checked Drawn AJ | Project Number 695-14-114 Building Number Building 111 Drawing Number E-101 | Office of Construction and Facilities Management Department of Veterans Affairs |
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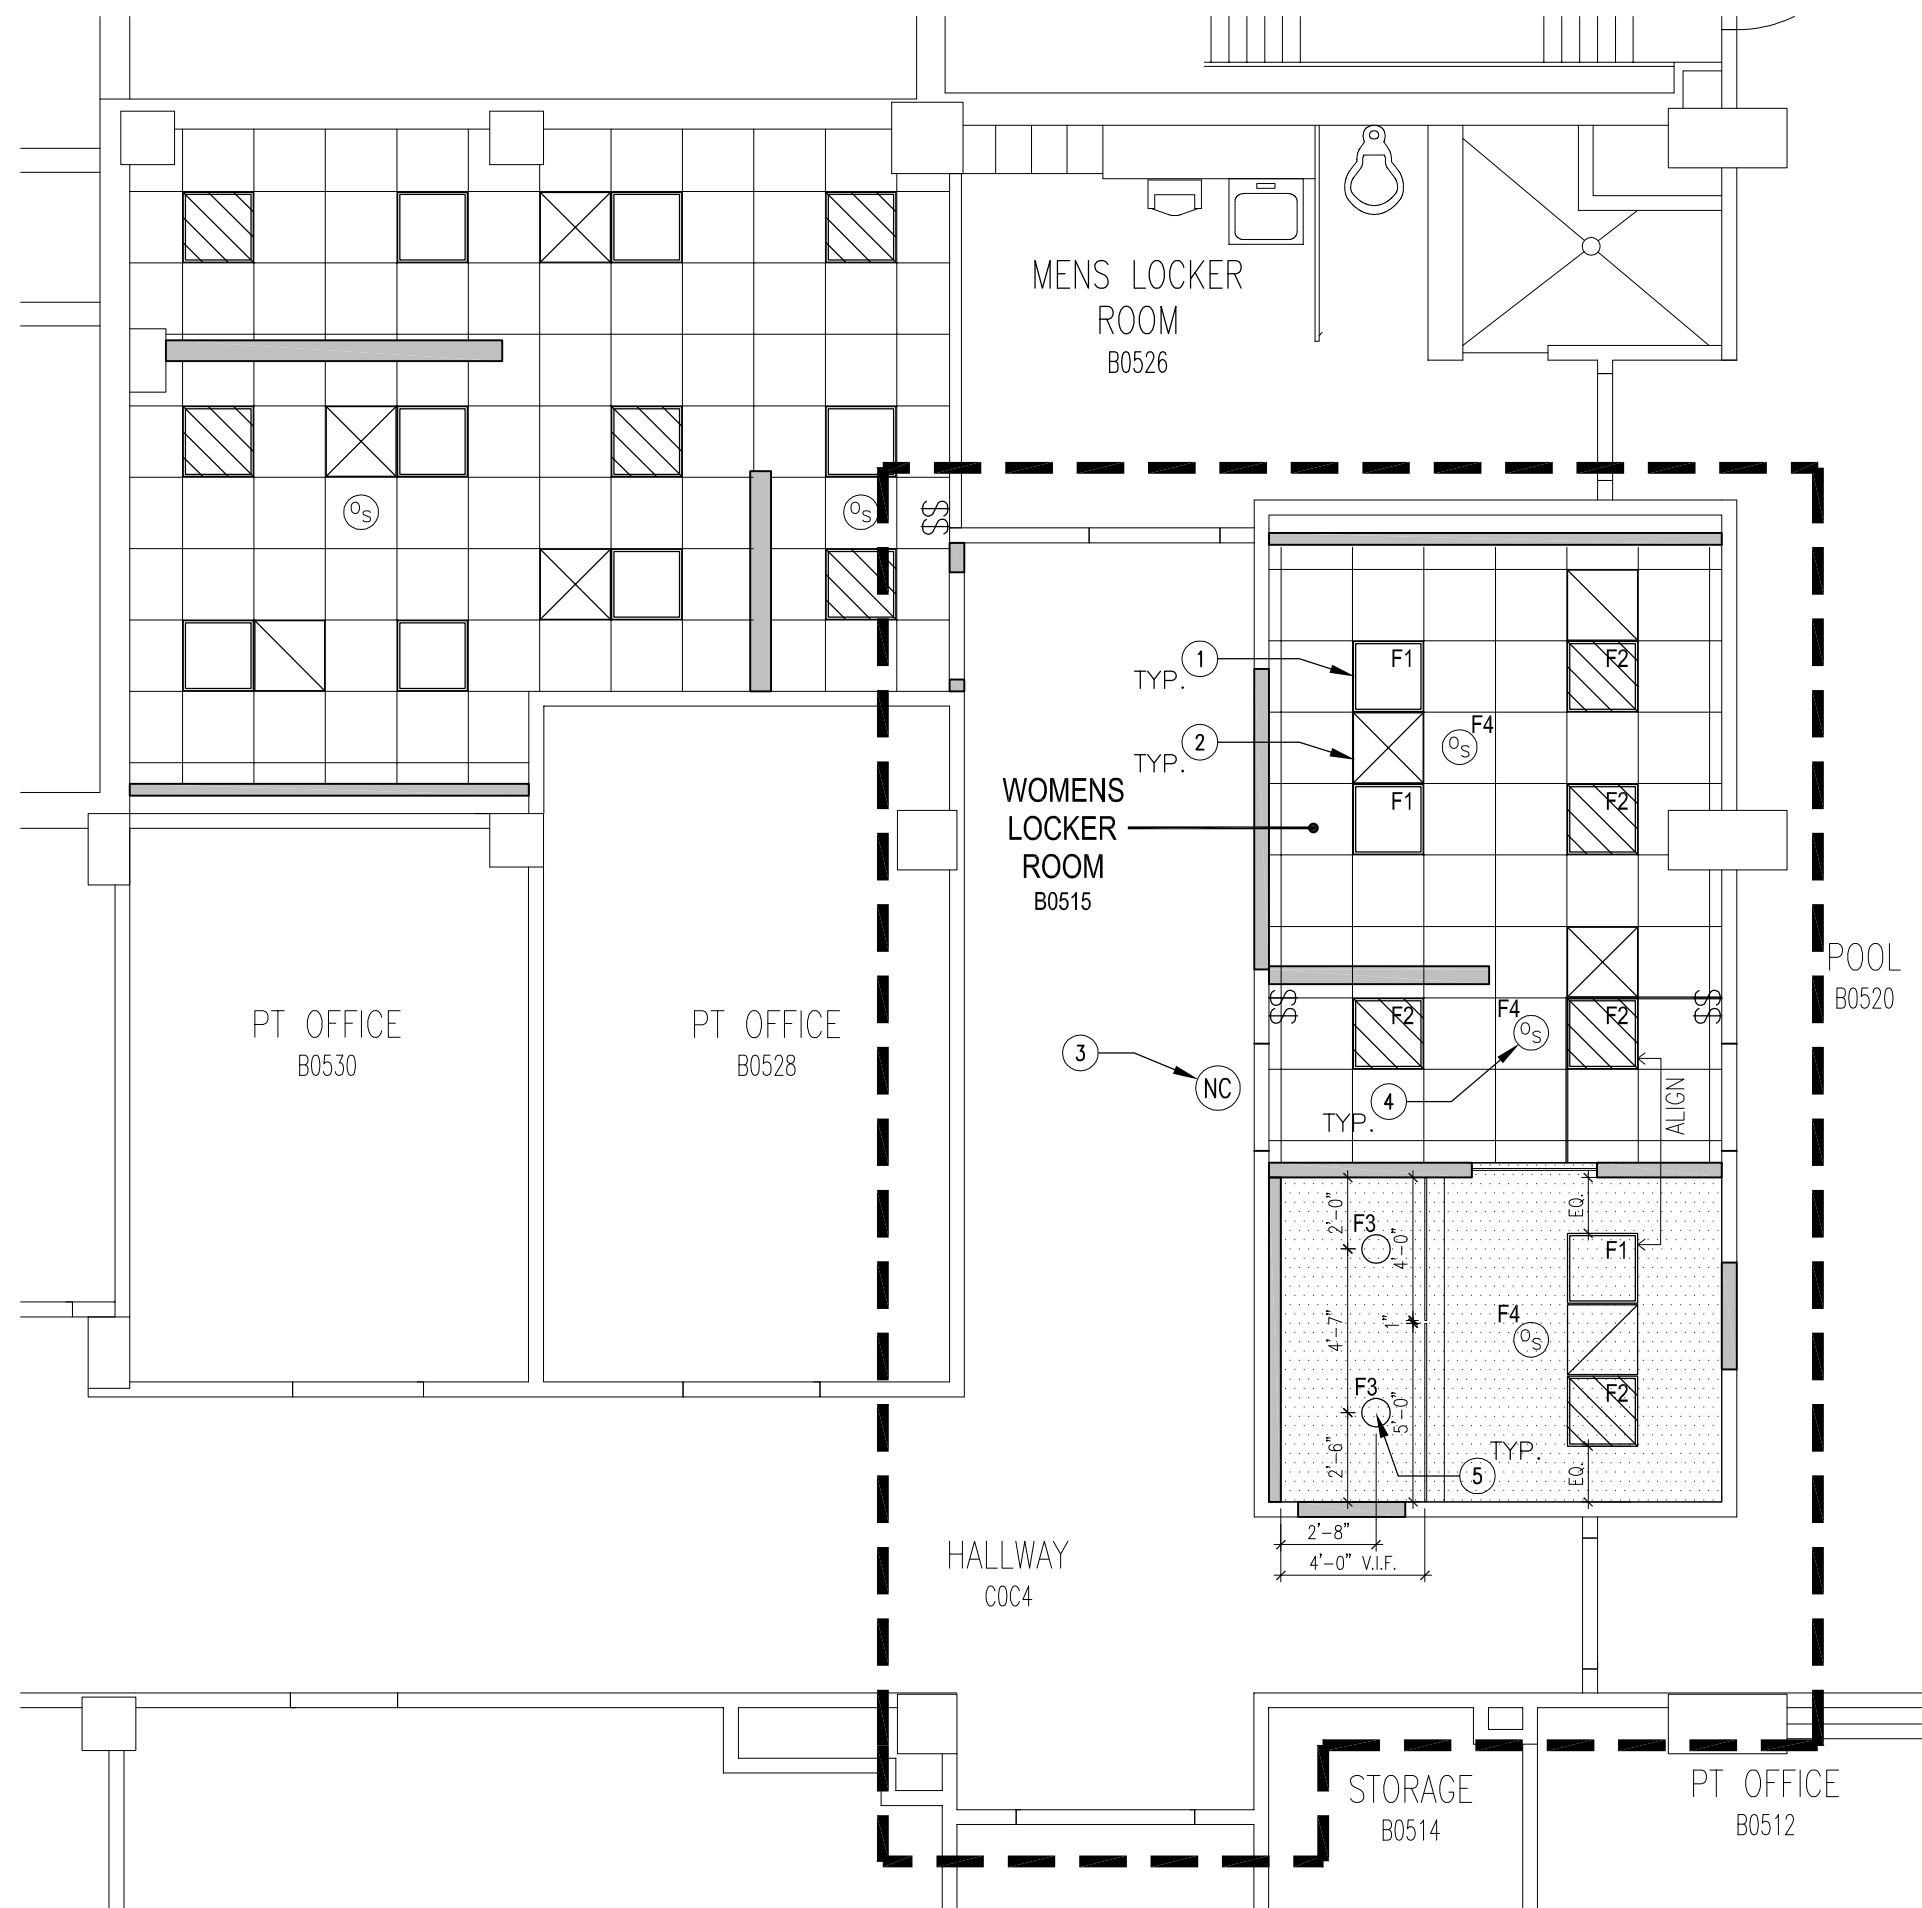
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one inch = one foot
three quarters inch = one foot
three eighths inch = one foot
one half inch = one foot
three quarters inch = one foot
one half inch = one foot
three eighths inch = one foot
one quarter inch = one foot
one eighth inch = one foot

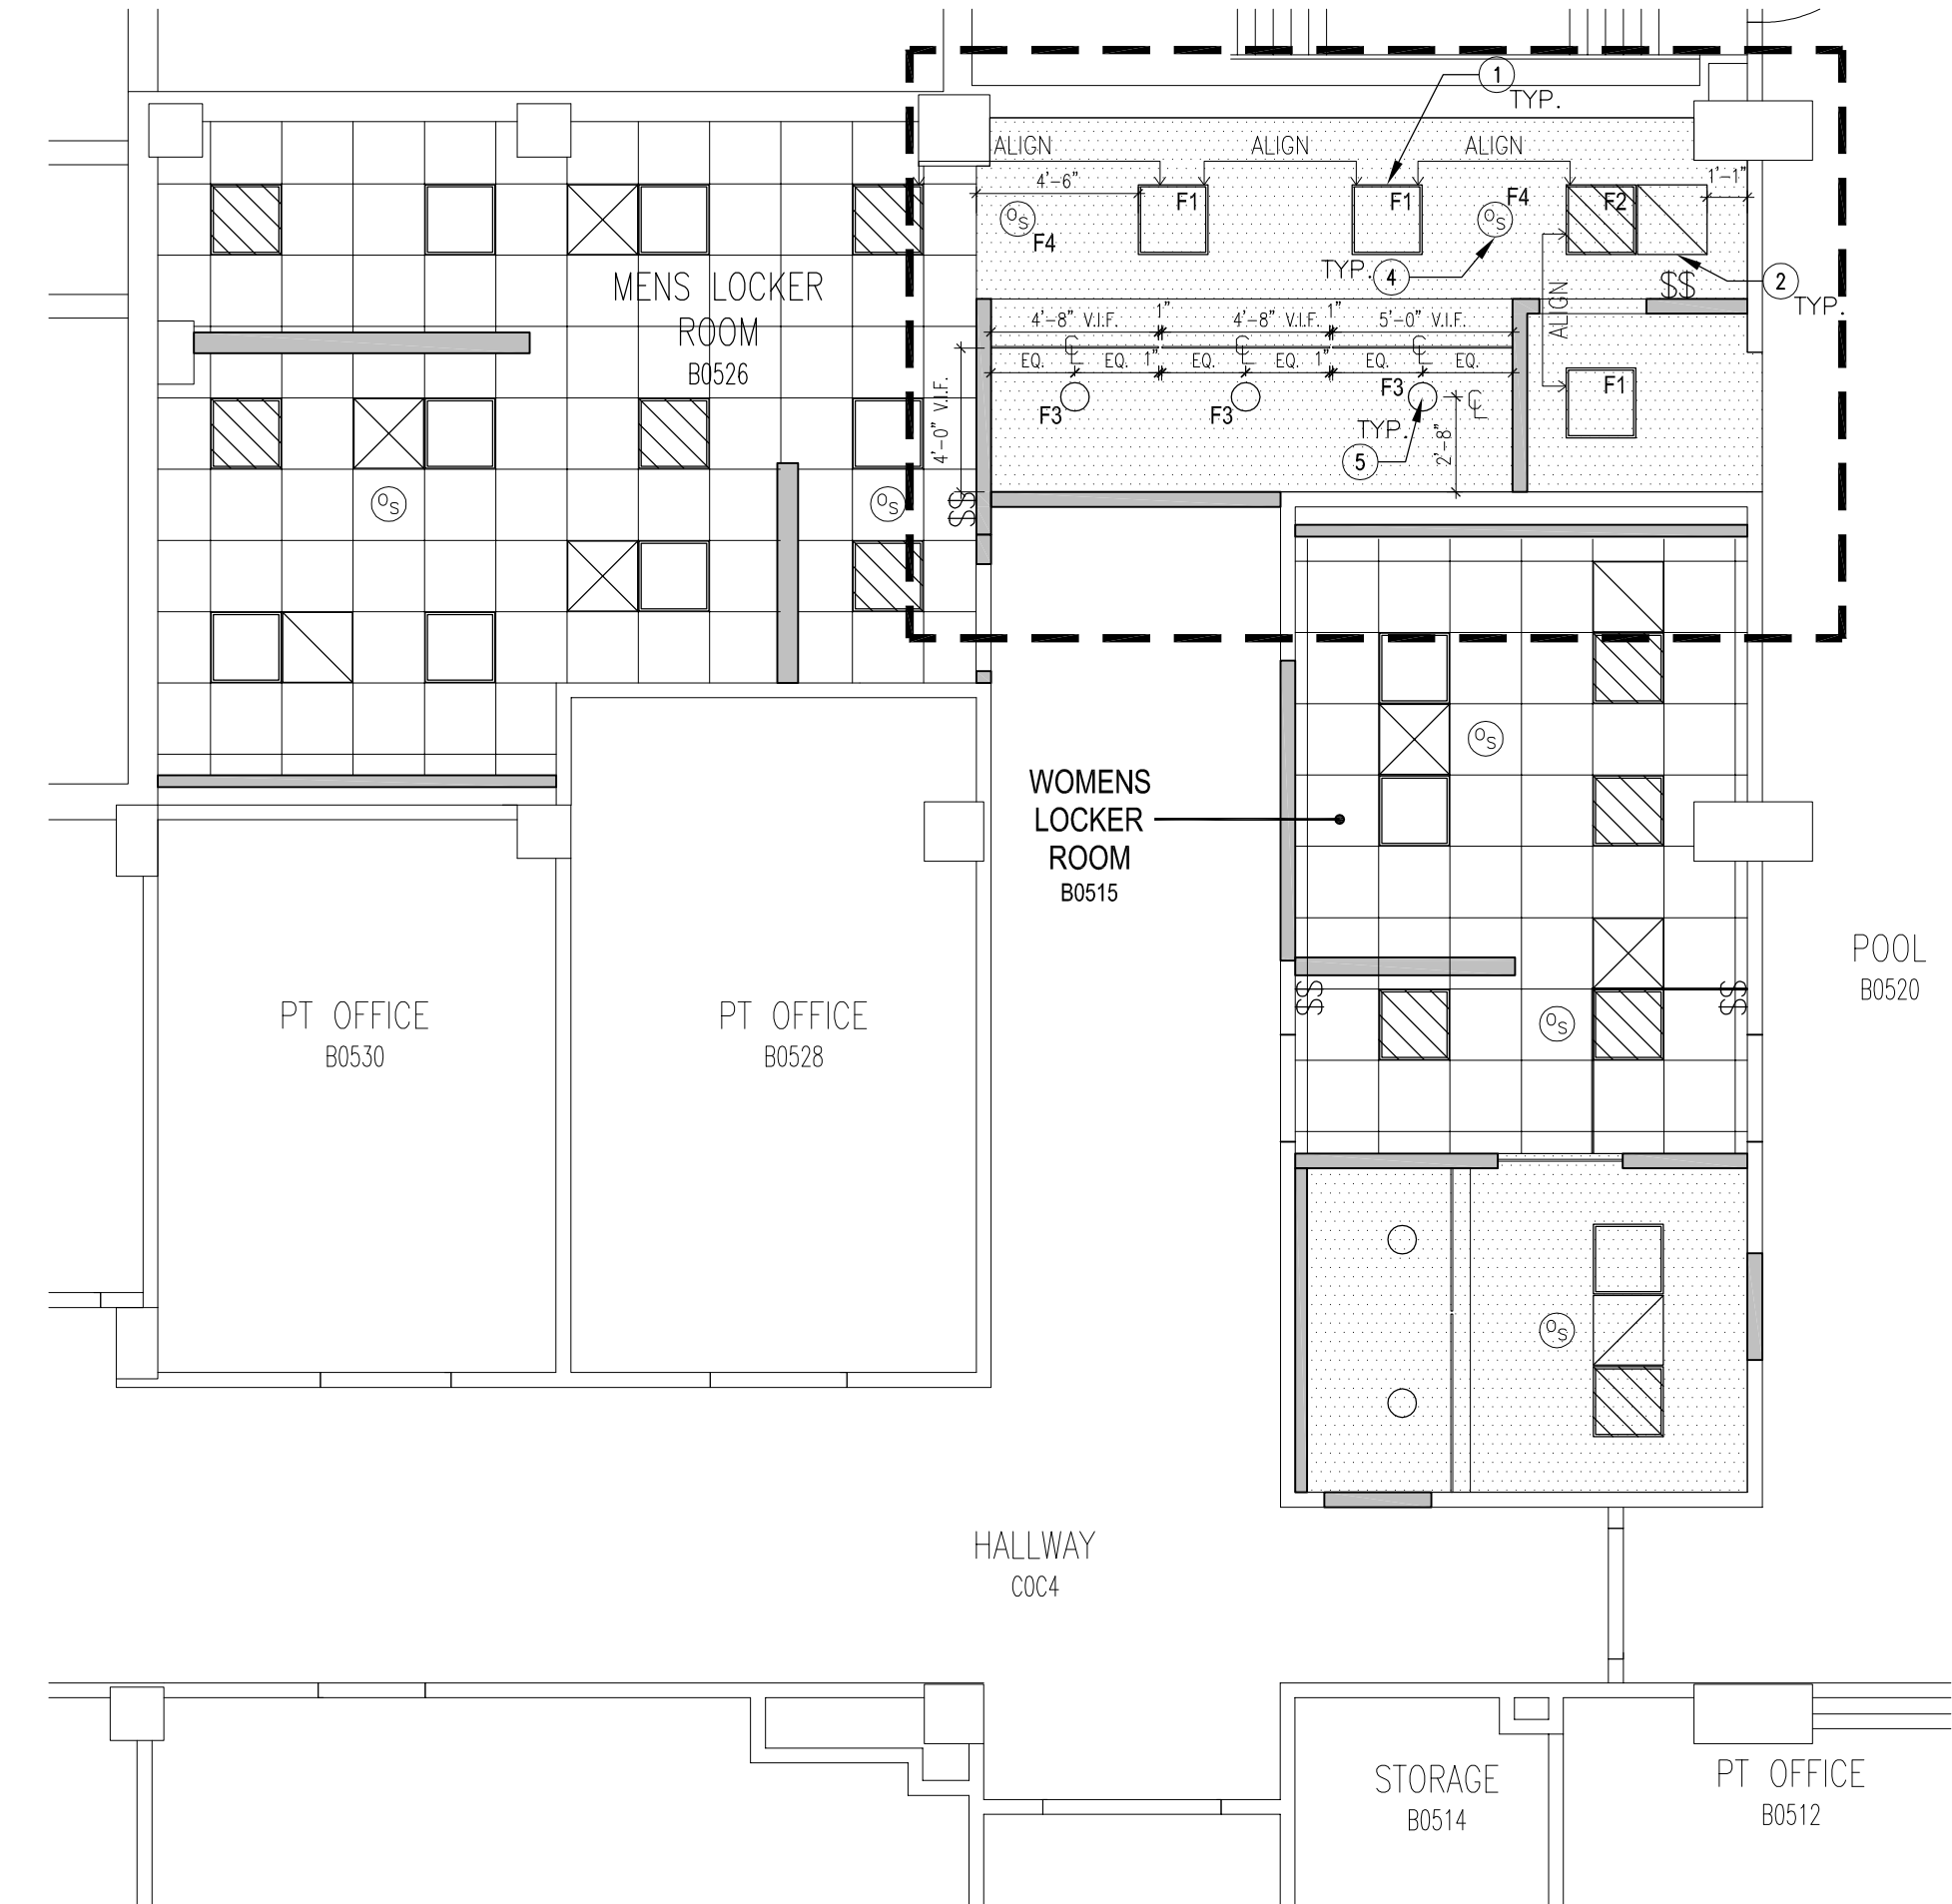

3 REFLECTED CEILING PLAN - PHASE 3
3/16" = 1'-0"

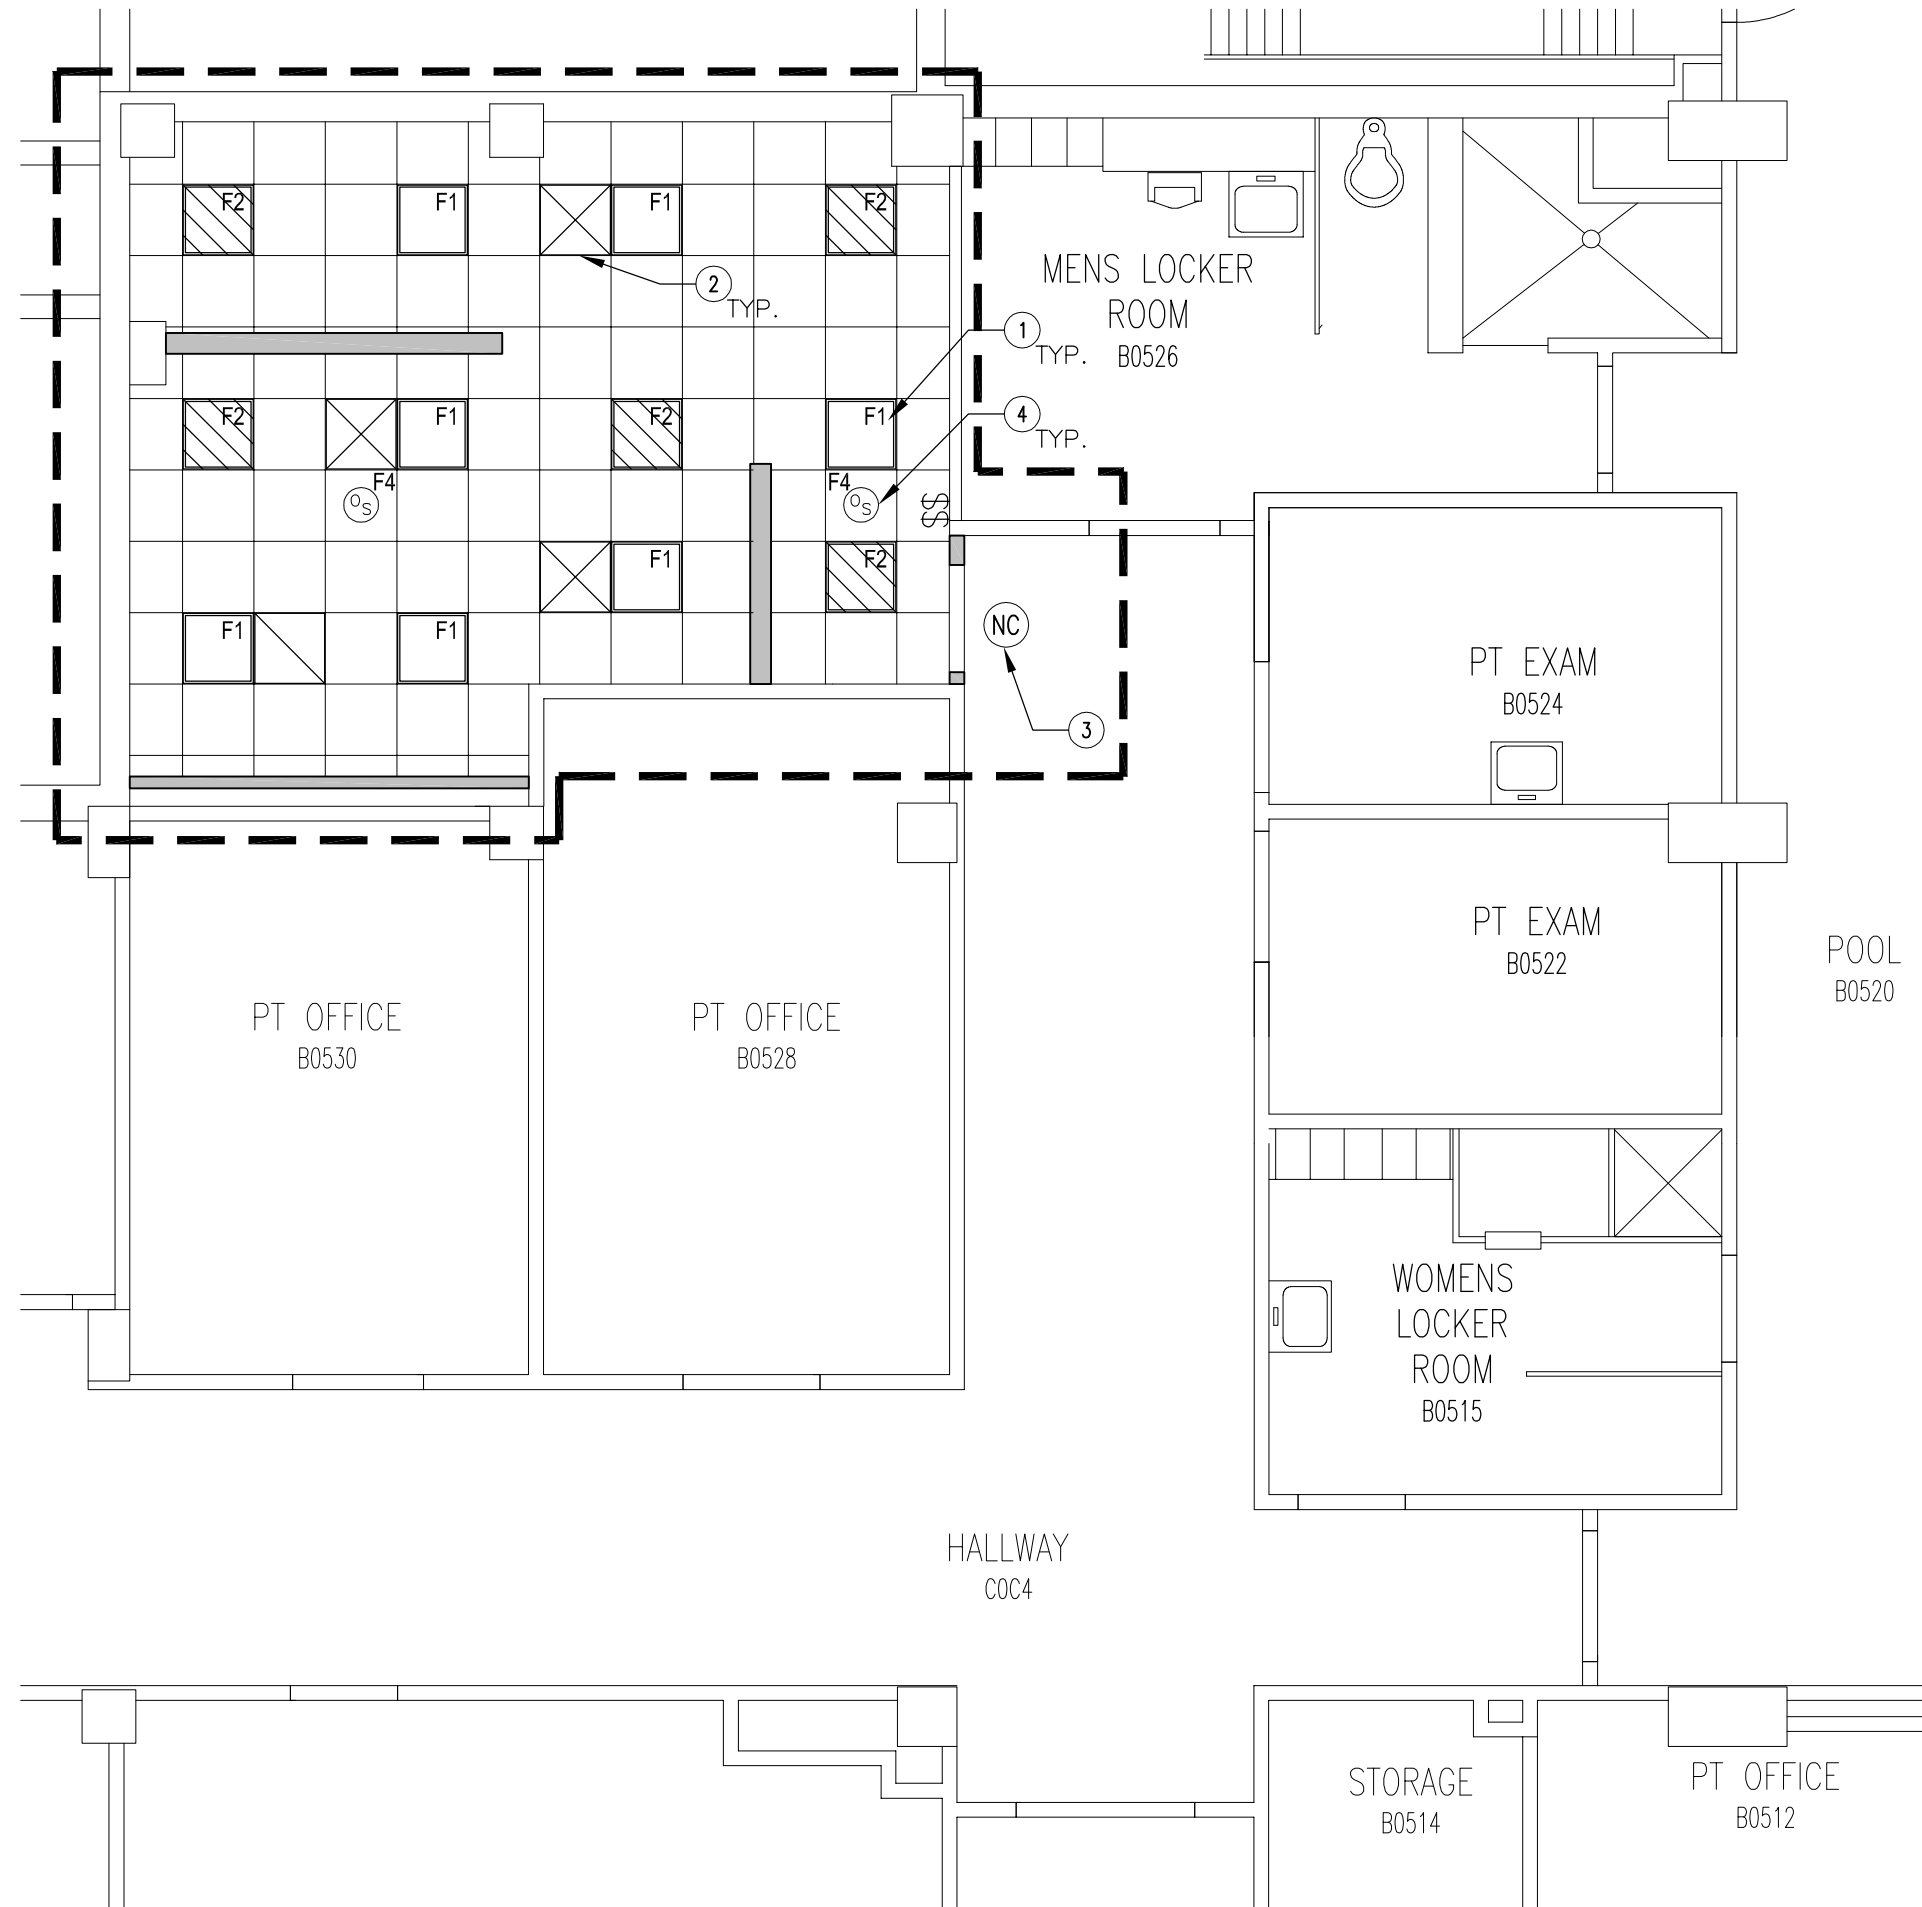

1 REFLECTED CEILING PLAN - PHASE 1
3/16" = 1'-0"



2 REFLECTED CEILING PLAN - PHASE 2
3/16" = 1'-0"

| FIXTURE SCHEDULE | | | | | | | | | | | |
|---|--|-------|-----|-------------|----------|------|-----|-------------|------|-------|---------------|
| ID | DESCRIPTION | LAMPS | | | BALLASTS | | | INPUT WATTS | VOLT | MOUNT | CEILING DEPTH |
| | | TYPE | NO. | DESCRIPTION | WATTS | K | CRI | | | | |
| F1 | 2' X 2' VOLUMETRIC RECESSED FIXTURE 2 LAMP | F | 2 | F1778 | 17 | 4100 | 82 | ET | 1 | 29 | 120 |
| F2 | 2' X 2' VOLUMETRIC RECESSED FIXTURE 2 LAMP | F | 2 | F1778 | 17 | 4100 | 82 | ET | 1 | 29 | 120 |
| F3 | 8" FLUORESCENT SHOWER FIXTURE | F | 2 | F280BX | 26 | 4100 | 82 | ET | 1 | 51 | 120 |
| F4 | OCCUPANCY SENSOR | | | | | | | | | | |
| GENERAL NOTES: | | | | | | | | | | | |
| A. SEE SPECIFICATION SECTIONS 26 50 00 AND 26 02 37 FOR ADDITIONAL INFORMATION REGARDING LIGHTING FIXTURE AND INSTALLATION REQUIREMENTS. | | | | | | | | | | | |
| B. PROVIDE OPTIONS AND ACCESSORIES REFERENCE BY THE COLUMN TITLED "NOTES". | | | | | | | | | | | |
| C. MANUFACTURERS AS ACCEPTABLE SHALL MEET ALL REQUIREMENTS AND FEATURES INDICATED. | | | | | | | | | | | |
| D. ACCEPTABLE MANUFACTURERS MUST MEET THE PHOTOMETRIC PERFORMANCE OF THE LISTED UNIT. | | | | | | | | | | | |
| E. VERIFY CEILING T-BAR WIDTH (I.E. 8" @ 1.5') WITH THE ARCHITECT/INTERIORS SPECIFICATION PRIOR TO ORDERING LAY-IN FIXTURES. | | | | | | | | | | | |
| F. IF ALL INSULATED OR FIRE RATED CEILINGS, THE EC SHALL BE RESPONSIBLE FOR THE PROPER TENCING (OR FIRE BOXING) OF THE RECESSED FIXTURES. | | | | | | | | | | | |
| NOTES: | | | | | | | | | | | |
| 1. POST PAINTED FINISH | | | | | | | | | | | |
| 2. FIXTURE ON EMERGENCY POWER | | | | | | | | | | | |
| 3. WET LOCATION CONSTRUCTION | | | | | | | | | | | |
| 4. MATTE DIFFUSE LOW IRIDESCENT REFLECTOR | | | | | | | | | | | |
| 5. FURNISH WITH PRISMATIC LENS | | | | | | | | | | | |

GRAPHIC LEGEND

- EXISTING WALL TO REMAIN
- EXISTING DOOR TO REMAIN
- INFECTION CONTROL/CONSTRUCTION BARRIER WALL (FC/CB)
- NEW WALL/PARTITION
- 2'-0" x 2'-0" SUSPENDED EXPOSED GRID ACOUSTIC CEILING TILE
- DRYWALL CEILING/SOFFIT, HEIGHT SHOWN
- RETURN, EXHAUST GRILLE
- SUPPLY GRILLE
- NEW SWITCH
- NEW LIGHT FIXTURE, RECESSED FLUORESCENT EMERGENCY, 2'X2'; USE EMERG. CST FROM CORRIDOR LIGHTING.
- NEW CEILING MOUNTED NURSE CALL INDICATOR
- PLAN KEY NOTE
- PARTITION TYPE
- INTERIOR ELEVATION
- NEW DOOR
- EXIT LIGHT
- NEW OCCUPANCY SENSOR
- CEILING HEIGHT
- NEW LIGHT FIXTURE, RECESSED FLUORESCENT, 2'X2"
- NEW RECESSED CAN LIGHT FIXTURE, LED

REFLECTED CEILING PLAN GENERAL NOTES

- PERIMETER CEILING TILES SHALL NOT BE LESS THAN 4".
- LOCATE ALL SPRINKLER HEADS, SMOKE DETECTORS, HEAT SENSORS IN THE CENTER OF CEILING TILE (OR IN THE CENTER OF A RAISED/RECESSED FIELD OF PATTERNED TILE).
- CEILING HEIGHT SHALL BE 8'-0" U.N.O. REFER TO SHEET ID-102 FOR INTERIOR ELEVATIONS.
- THE REFLECTED CEILING PLAN (RCP) MAY NOT INDICATE ALL CEILING MOUNTED DEVICES AND FIXTURES.

HVAC GENERAL NOTES

- EXHAUST 10 AIR CHANGES PER HOUR FOR LOCKER ROOMS.
- CONNECT TO EXISTING EXHAUST FANS.
- FIELD VERIFY DURING SCOPE WALK-THRU EXISTING LOCATIONS OF DUCTS.
- TEST AND BALANCE HVAC AS REQUIRED.
- HVAC IS A DESIGN BUILD PROJECT. SUPPLY AND RETURN REGISTERS ARE GRAPHICALLY SHOWN TO DEPICT IDEAL LOCATION. PRIOR TO INSTALLATION OF SUPPLY AND RETURN REGISTERS COORDINATE ALL WORK WITH VA PRIOR TO INSTALLATION.


PLAN KEY NOTES

- PROVIDE NEW LIGHT FIXTURES.
- PROVIDE NEW SUPPLY AND RETURN AIR REGISTERS.
- PROVIDE NEW NURSE CALL INDICATOR CENTERED ABOVE DOOR ON CORRIDOR SIDE. COORDINATE PRECISE LOCATION WITH VA PRIOR TO INSTALLATION.
- PROVIDE NEW OCCUPANCY SENSOR.
- PROVIDE ROUND RECESSED LIGHT FIXTURE CENTERED ABOVE EACH SHOWER ENCLOSURE. COORDINATE PRECISE LOCATION WITH VA PRIOR TO INSTALLATION.

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KEY PLAN



BUILDING 111
BASEMENT

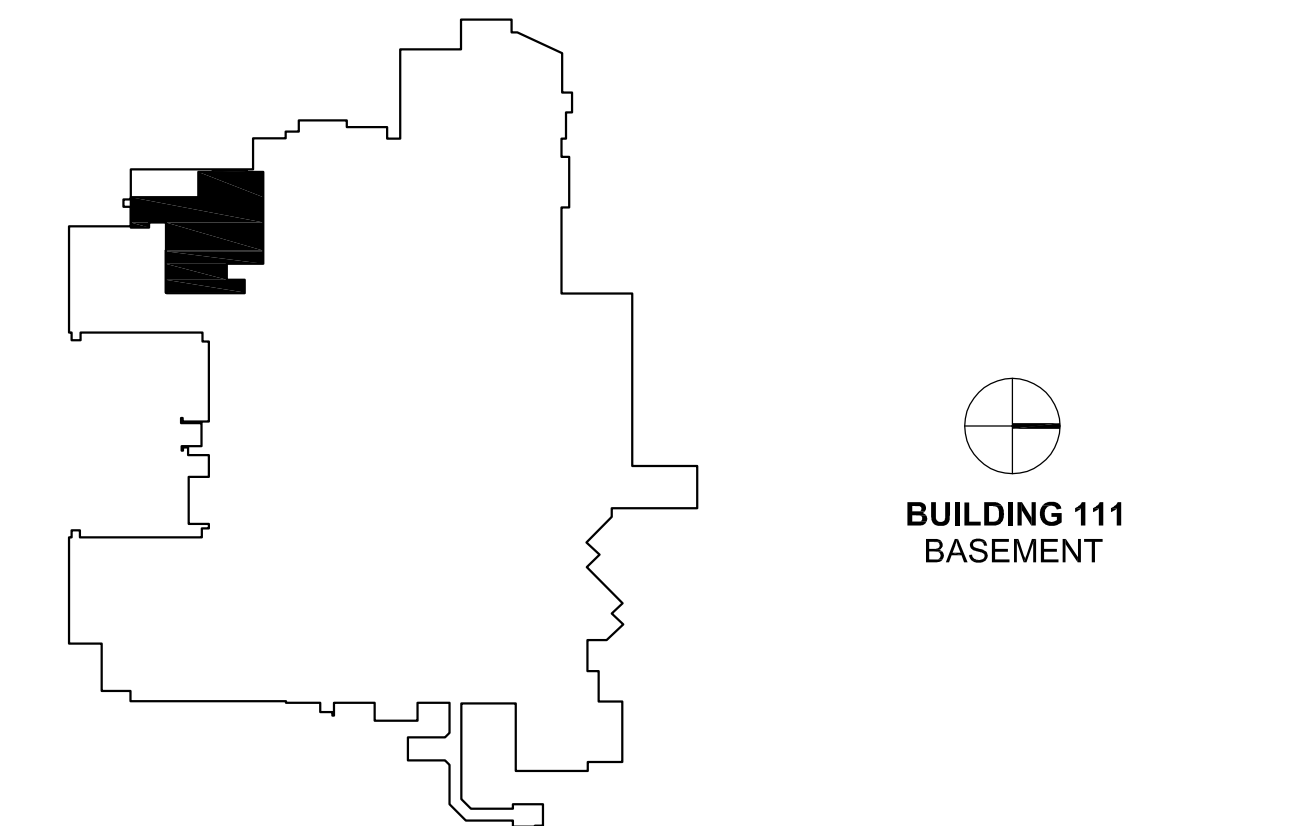

ARCHITECT:

CLEMENT J. ZABLOCKI VA MEDICAL CENTER
OFFICE OF CONSTRUCTION AND FACILITIES MANAGEMENT

Drawing Title
PHASE 1-3: ELECTRICAL
LIGHTING PLANS

Approved: Project Director
Troy Martinson, PE

Project Title
111 Upgrade Pool Locker
Rooms

Location
VA Medical Center, Milwaukee, WI

Date
August 28, 2015

Checked
AJ

Drawn
AJ

Project Number
695-14-114


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Drawing Number
E-301


Office of
Construction
and Facilities
Management

Department of
Veterans Affairs


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3 PLAN - PHASE 3
3/16" = 1'-0"

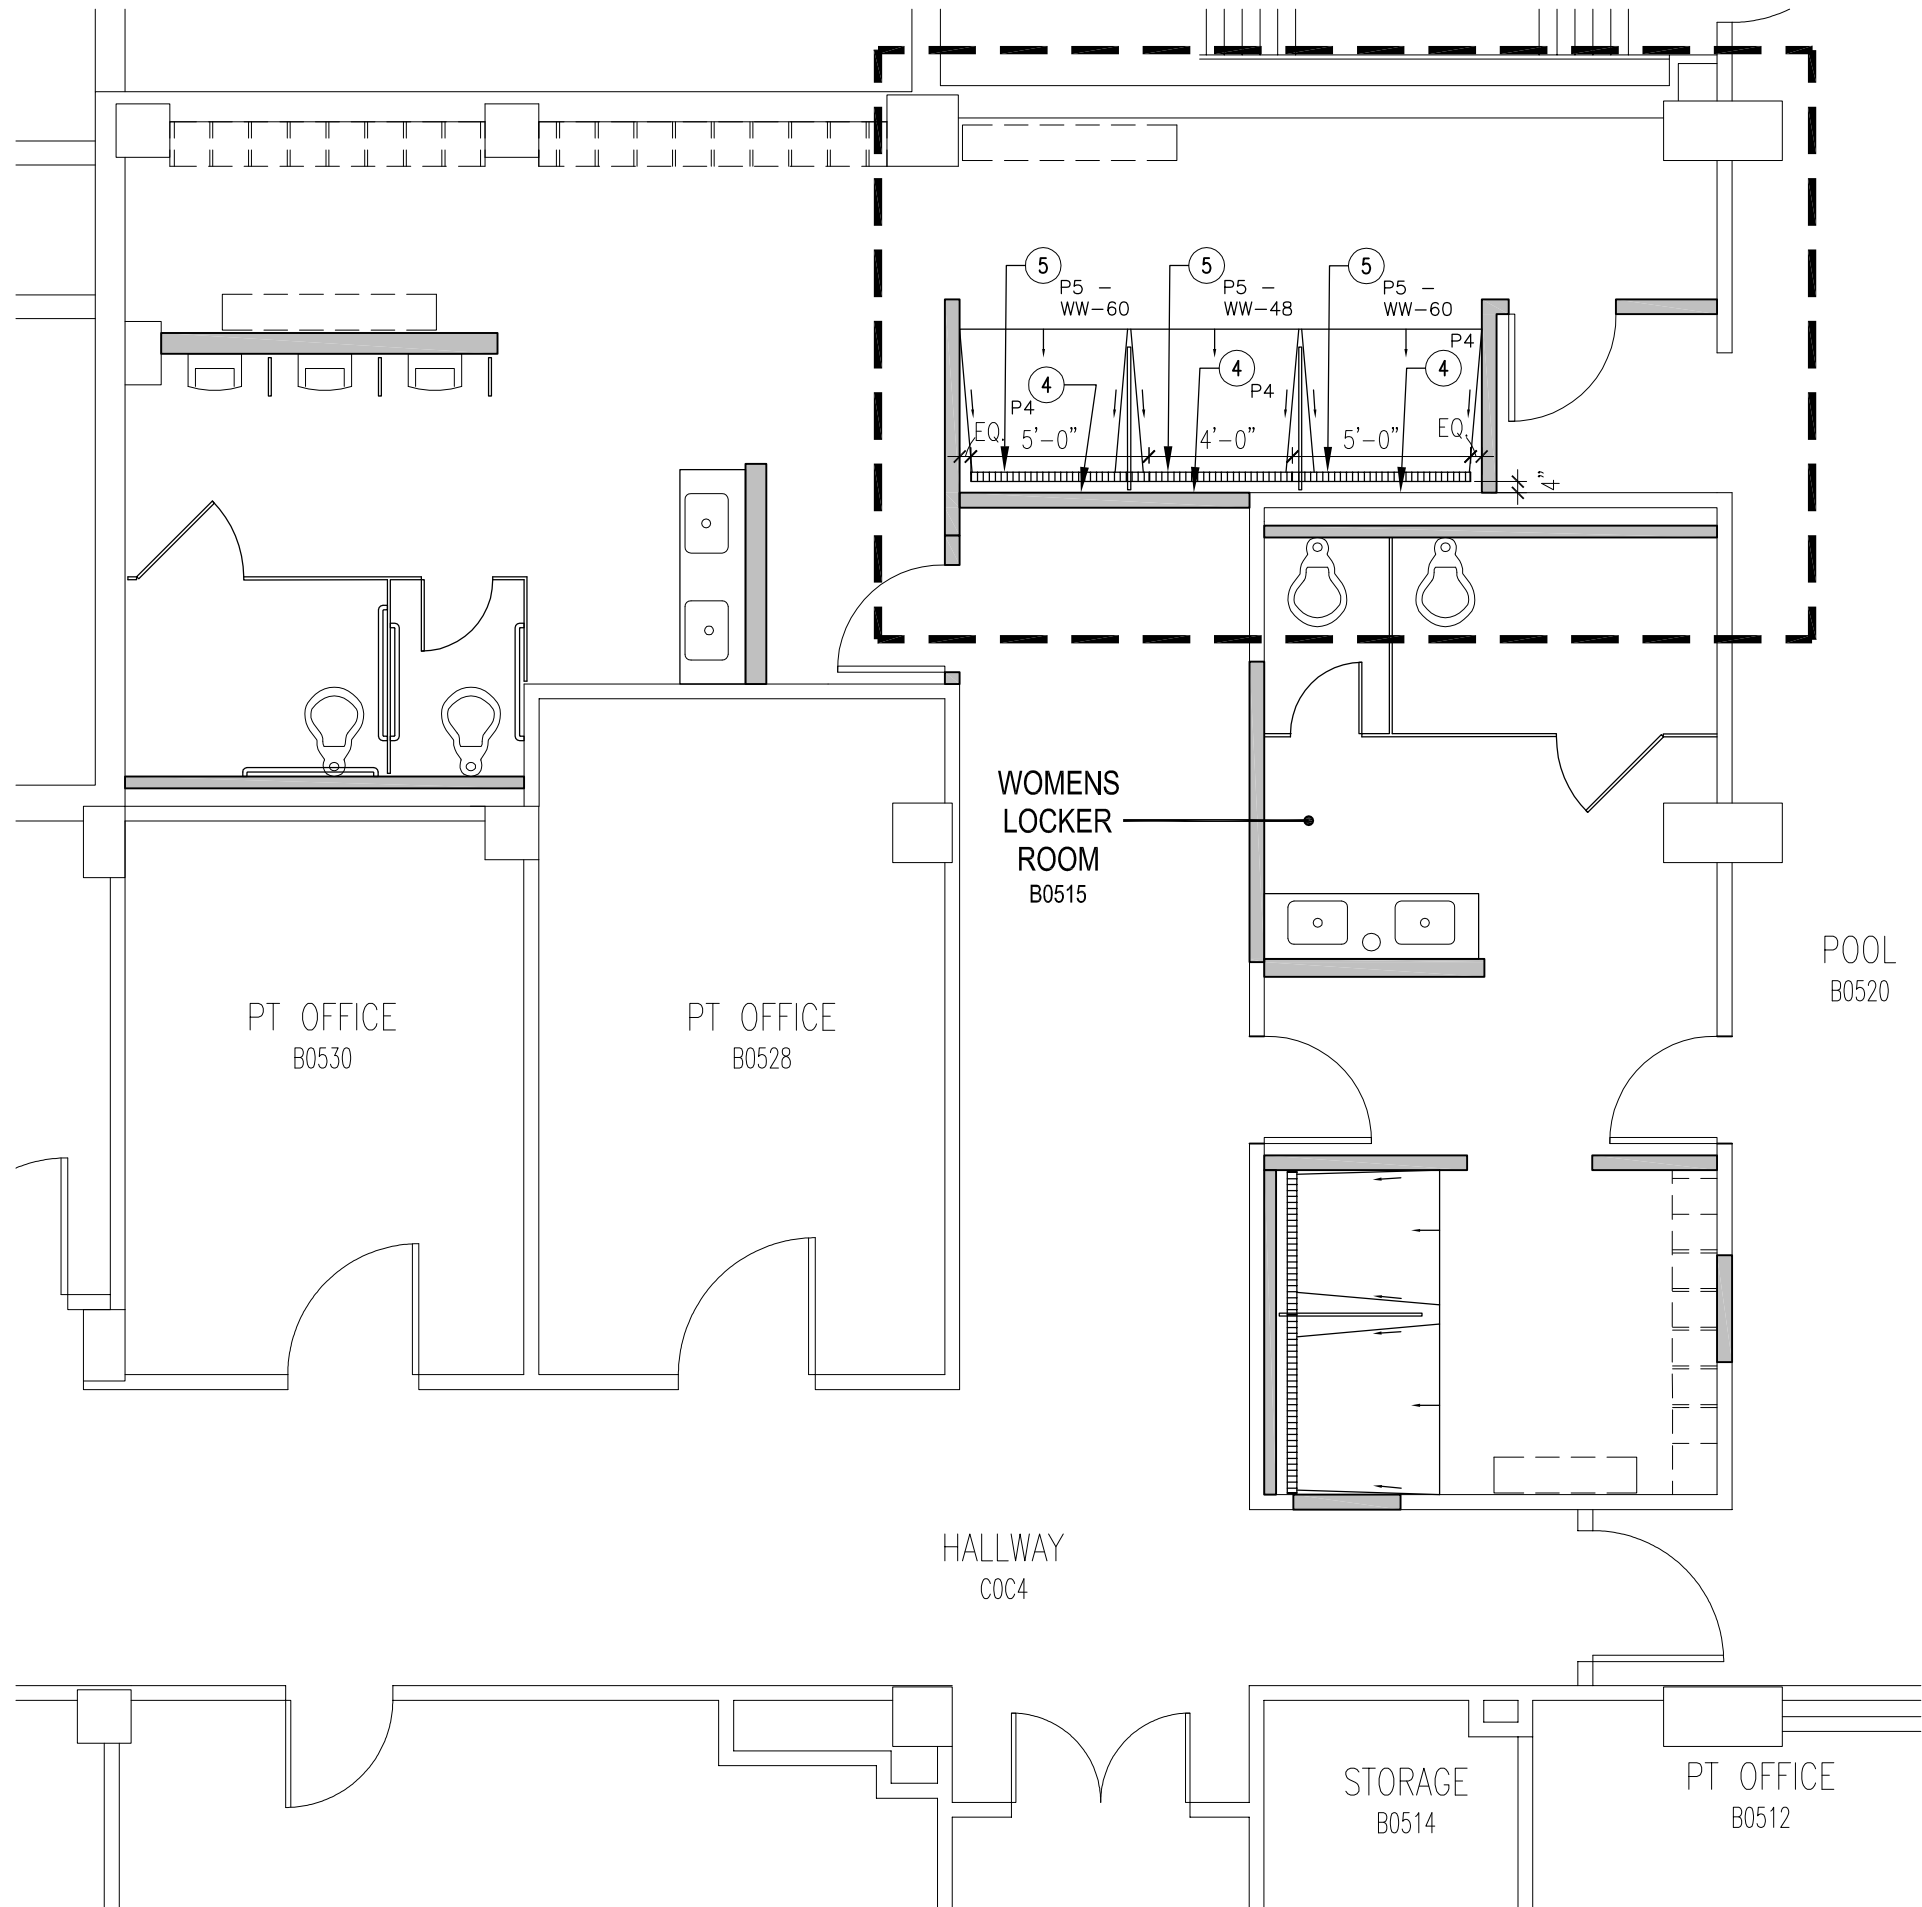

1 PLAN - PHASE 1
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2 PLAN - PHASE 2
3/16" = 1'-0"
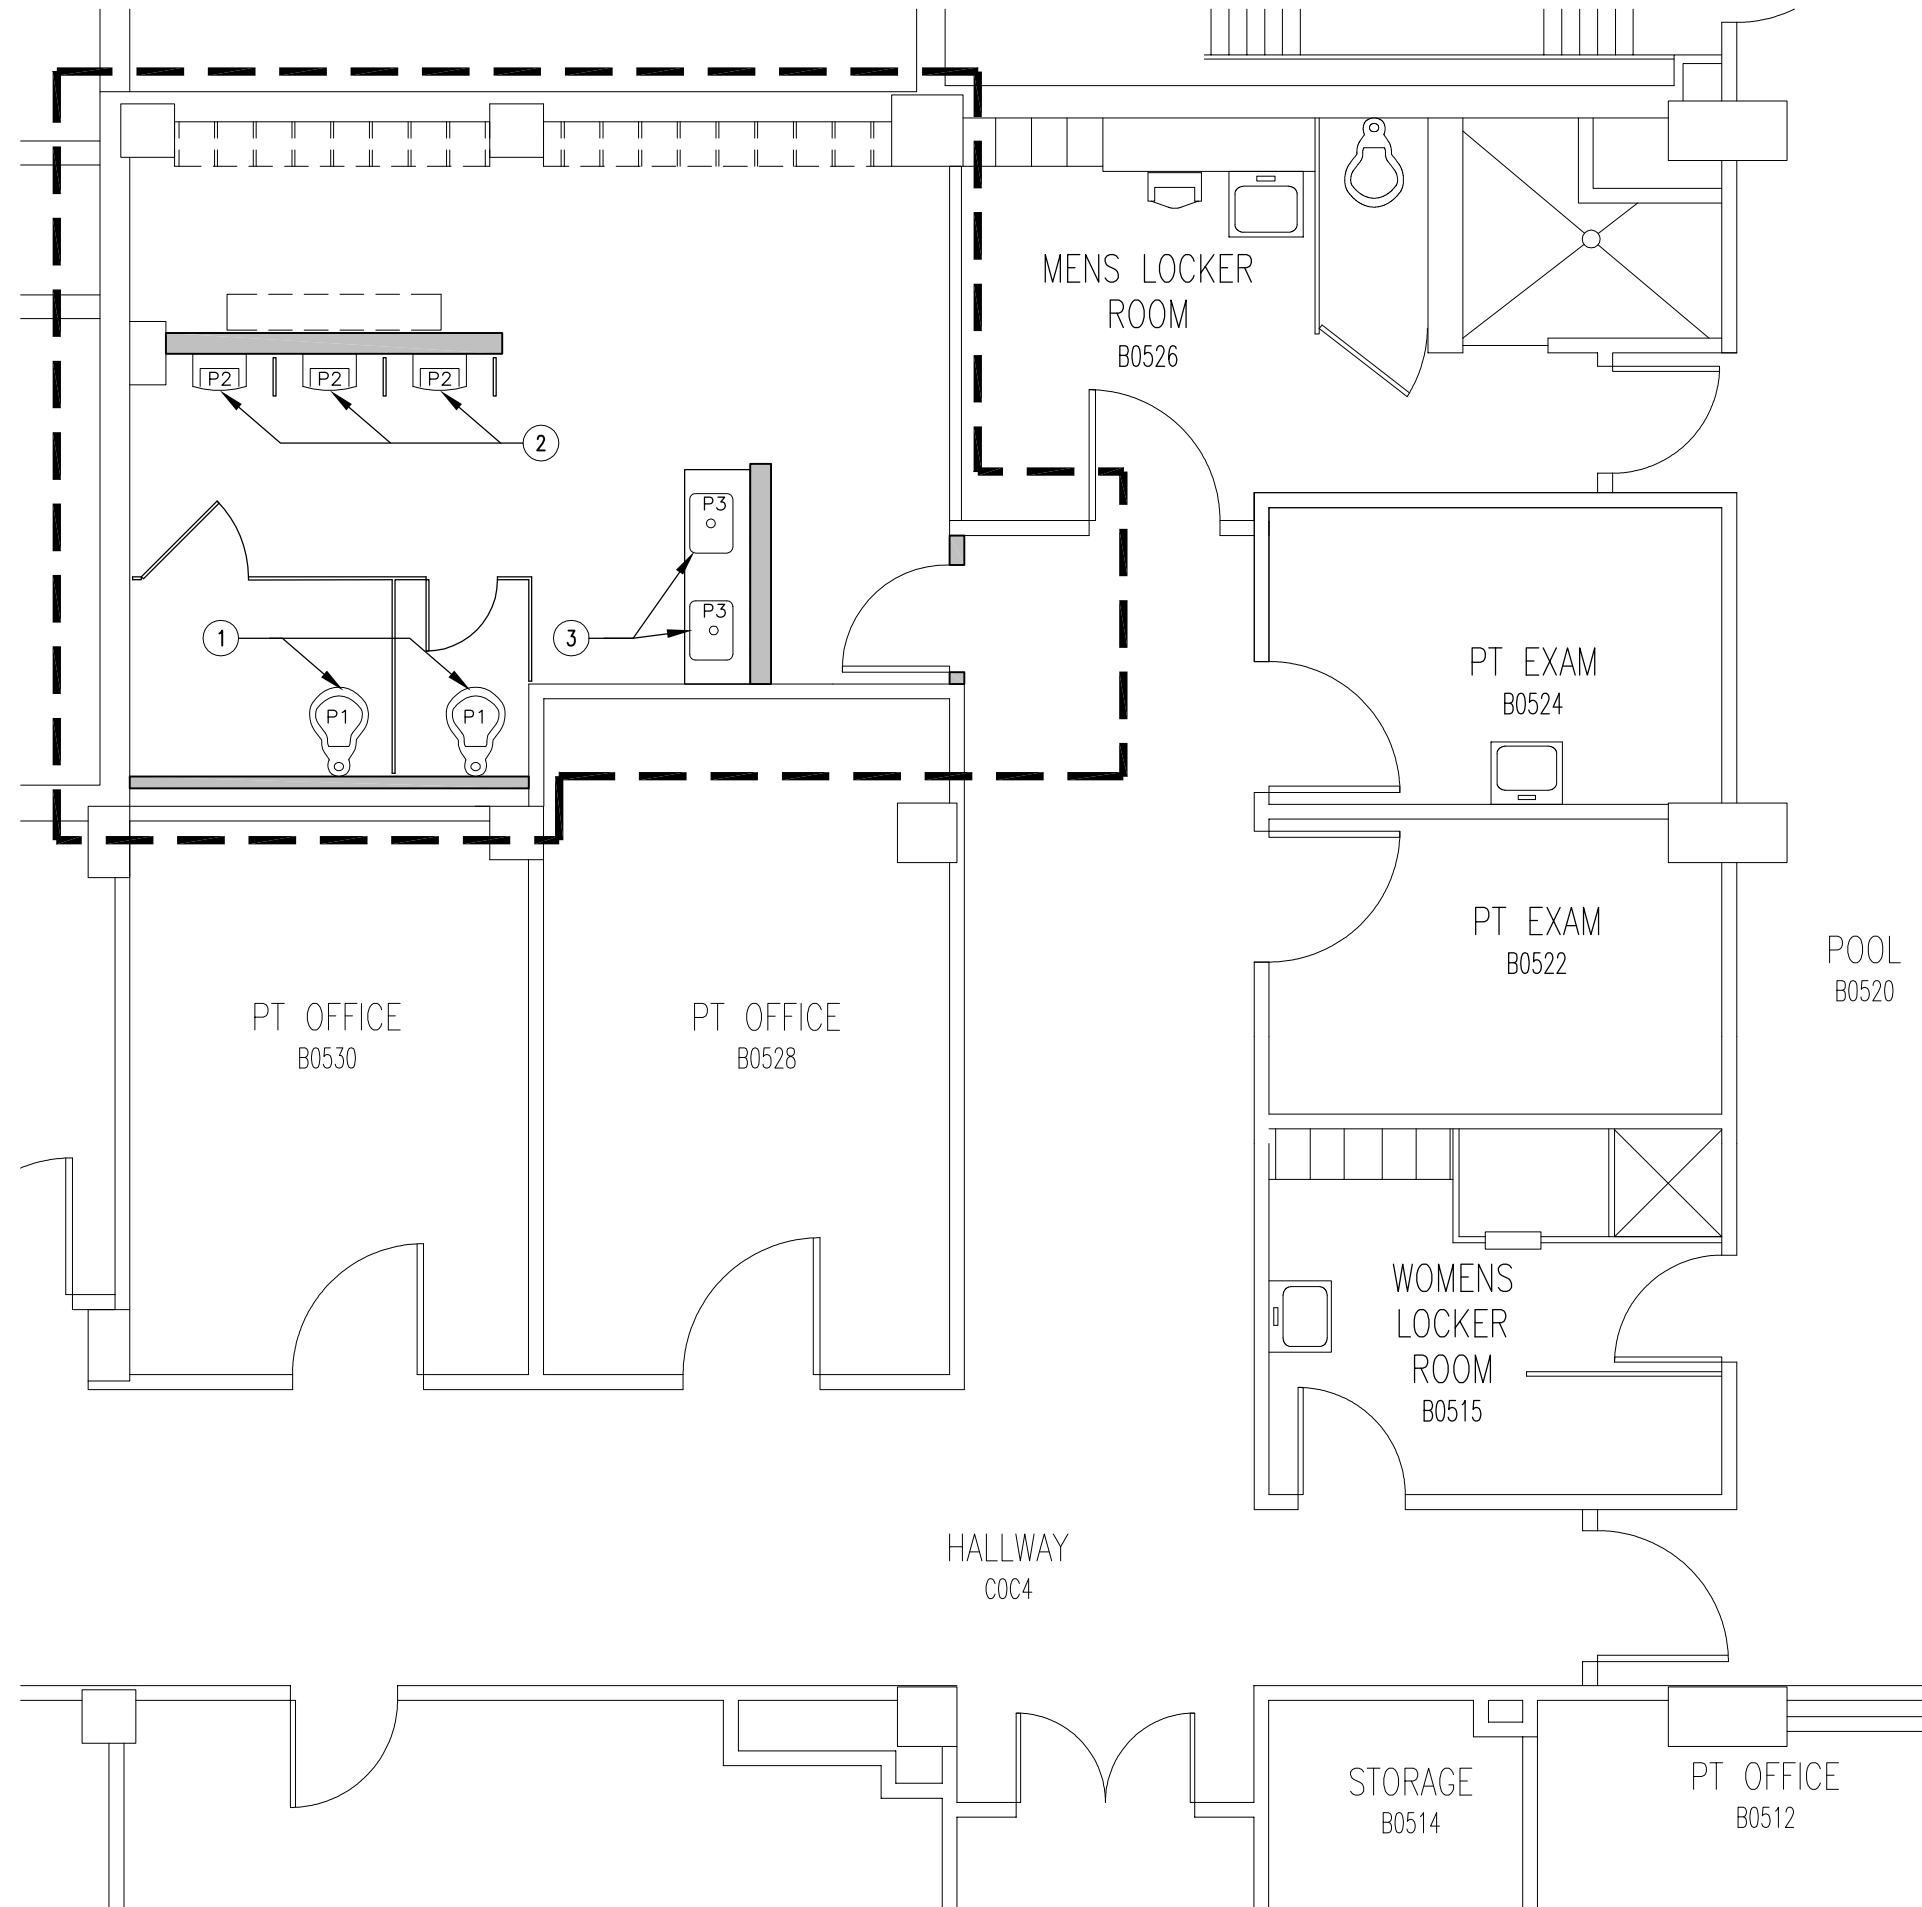
| PLUMBING FIXTURE SCHEDULE | | | | |
|---------------------------|---------------|--------------------|--|---|
| ID | TYPE | MANUFACTURER | MODEL NUMBER | DESCRIPTION |
| P1 | WATER CLOSET | AMERICAN STANDARD | AFWALL 3351.576 | ADA COMPLIANT, VITREOUS CHINA, WALL HUNG, ELONGATED BOWL, TOP SPUD, 1.6 GPF, COLOR: WHITE. |
| | SEAT | BIOMS | 1955 SSC | ELONGATED WHITE, OPEN FRONT/LESS COVER, WITH STAINLESS STEEL SELF-SUSTAINING CHECK HINGE. |
| | FLUSH VALVE | SLOAN | ROYAL 111 | ADA EXPOSED FLUSH VALVE, 1.6 GPF. |
| | CARRIER | ZURN | Z1203-N | COMMERCIAL GRADE, ADJUSTABLE, FLOOR MOUNTED WITH SHORT FEET. |
| P2 | URINAL | AMERICAN STANDARD | WASHBROOK 6590.001EC | ADA COMPLIANT, VITREOUS CHINA, WALL HUNG, TOP SPUD, 1.0 GPF WASH DOWN FLUSHING ACTION, COLOR: WHITE. |
| | FLUSH VALVE | SLOAN | ROYAL 186 - 1.0 GPF | BATTERY POWERED, SENSOR OPERATED, EXPOSED FLUSH VALVE, 1.0 GPF. |
| | CARRIER | ZURN | Z1222 | COMMERCIAL GRADE, FLOOR MOUNTED WITH SHORT FEET. |
| P3 | LAVATORY | CORIAN | INTEGRAL WITH COUNTERTOP | 300 SERIES VANITY TOP - 22" DOUBLE BOWL, WITH INTEGRAL BACK-SPLASH AND OPTIONAL SIDE-SPLASH WHERE OCCURS. REFER TO FINISH SCHEDULE AND ELEVATIONS. INTEGRAL BOWL COLOR: ANTARCTIC/CLACIER WHITE. |
| | FAUCET | SLOAN | EAF-100-ISM | DECK MOUNTED BATTERY SENSOR OPERATED FAUCET, FOR HOT & COLD WATER SUPPLY, MODULAR ONE-PIECE CONSTRUCTION WITH ALL CONCEALED COMPONENTS ABOVE DECK, 6 VOLT PLUG-IN ADAPTER, INTEGRAL SPOUT TEMPERATURE MIXER AND 1.5 GPM VANDAL-RESISTANT AERATOR AND 4" DECK PLATE. |
| | DRAIN | McGUIRE | 155A | PERFORATED GRID STRAINER AND TAIL PIECE. |
| | TRAP W/DRAINS | McGUIRE | PW 2150 INC | PRE-WRAPPED OFFSET DRAIN AND 1" A-TRAP WITH REDUCING SLIP NUT, TAIL-PIECE COVER, (2) SUPPLY COVERS & CHROME ESCUTCHEONS |
| | SUPPLIES | McGUIRE | H2165CC | 1" X 3/8" HEAVY SUPPLIES WITH HANDLE STOPS. |
| P4 | VALVE | KOHLER | RIGHT TEMP PRESSURE -BALANCING VALVE K-304-KS-NA | ADA COMPLIANT COMBINATION THERMOSTATIC AND PRESSURE BALANCING MIXING VALVE WITH INTEGRAL SERVICE STOPS AND ADJUSTABLE HOT WATER LIMIT STOP, AND CERAMIC VOLUME CONTROL. |
| | TRIM | KOHLER | DEVONSHIRE RITE-TEMP K-7397-4-CP | VALVE TRIM |
| | | KOHLER | AWAKEN K-88351-CP | WALL MOUNTED SUPPLY ELBOW WITH CHECK VALVE. |
| | | KOHLER | AWAKEN G80 KIT K-99381 | SLIDE BAR KIT - HAND SPRAY UNIT WITH 5' HOSE, SPRAY HEAD, 30" VERTICAL SLIDE BAR, IN-LINE VACUUM BREAKER, WALL CONNECTION AND FLANGE. |
| | SAFING | - | - | PROVIDE SAFING PER CODE UNLESS SPECIFICALLY DETAILED OR SPECIFIED IN OTHER CONTRACT DIVISIONS. |
| P5 | DRAIN | LUXE LINEAR DRAINS | WEDGEWIRE - WW-48 & WW-60 | FLUSH LINEAR TILE INSERT FLOOR/SHOWER DRAIN. SEE SPECIFICATIONS FOR PRODUCT DESCRIPTION AND INSTALLATION REQUIREMENTS. |
| | DRAIN | OATEY | 42246 | 2" PVC ROUND DRAIN, SOLVENT WELDED DRAIN BODY AND CLAMPING COLLAR ONLY TO BE INSTALLED WITH LUXE LINEAR DRAIN. |

4 PLUMBING SCHEDULE
N.T.S.

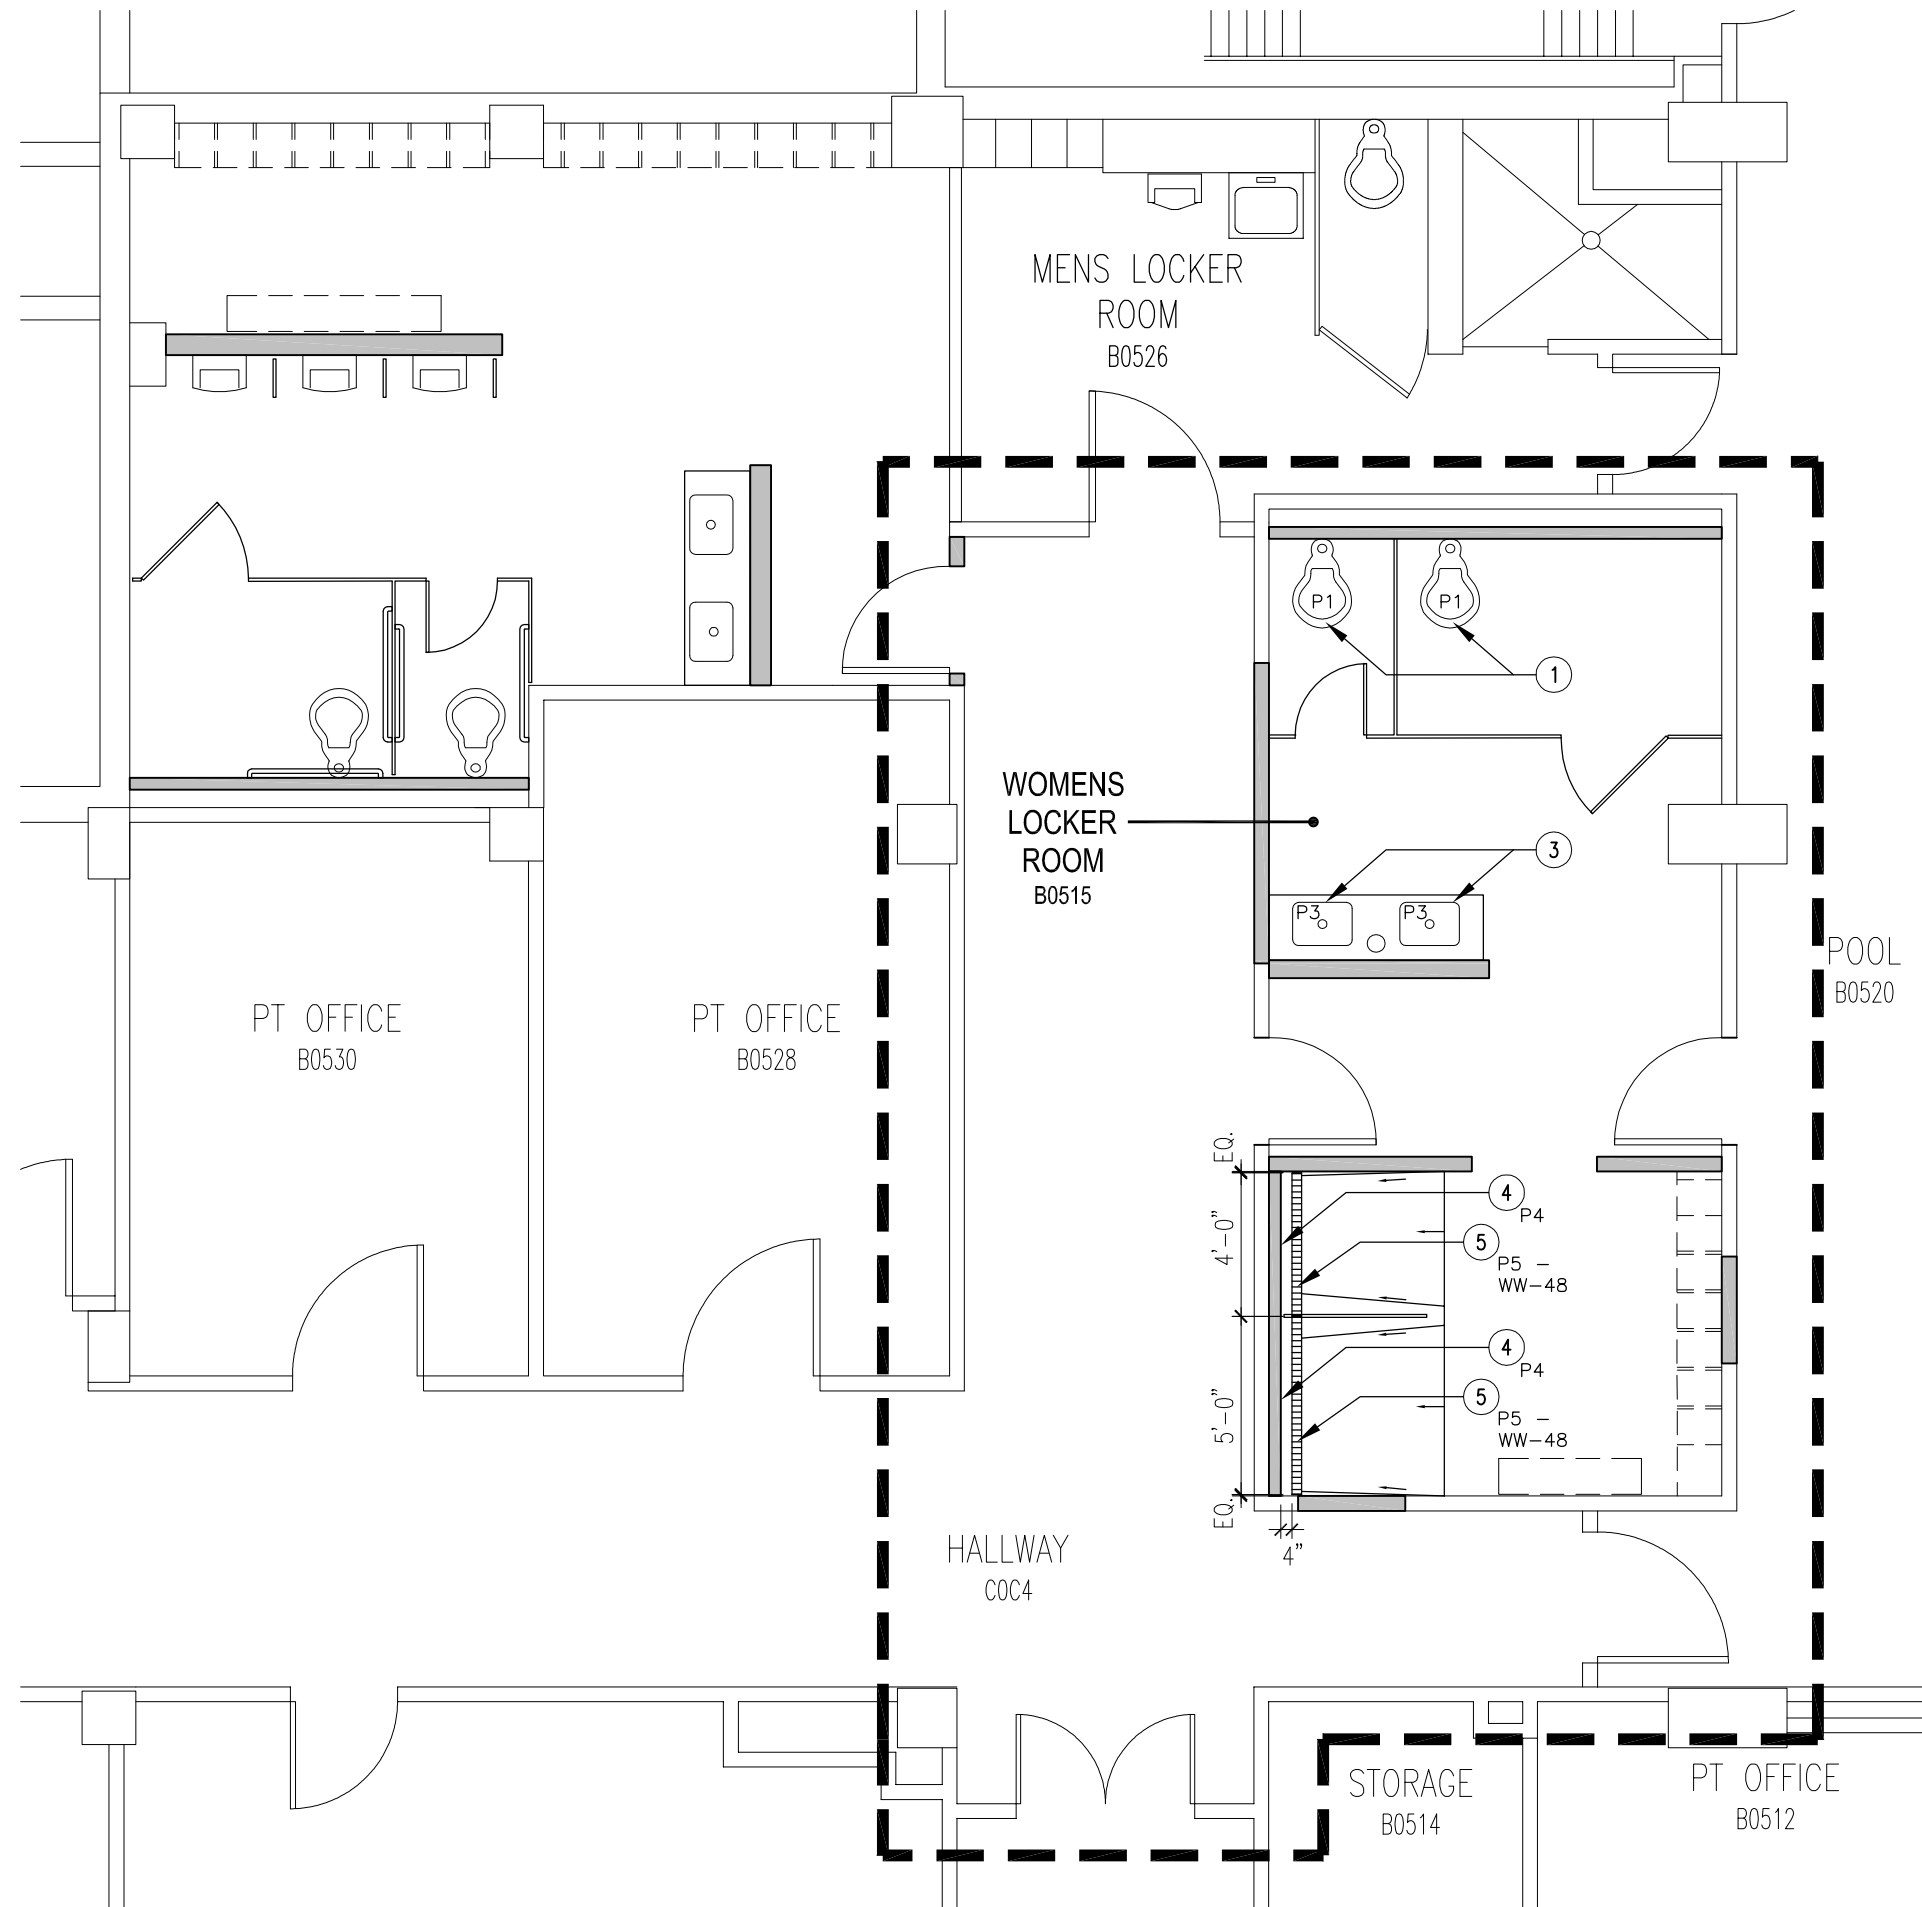PLAN KEY NOTES

1. INSTALL NEW WATER CLOSET (P1) AND ALL PLUMBING CONNECTIONS, P-TRAPS, VENT LINES, AND ALL CODE REQUIRED ASSOCIATED PIPING CONNECTIONS FOR NEW PLUMBING FIXTURES TO EXISTING FACILITY PLUMBING SYSTEMS BELOW FLOOR. CONTRACTOR TO VERIFY ALL CONNECTIONS REQUIRED IN SUB-BASEMENT. SEE PLUMBING SCHEDULE THIS SHEET AND SHEET ID-102 FOR ELEVATIONS AND DIMENSIONS.
2. INSTALL NEW URINAL (P2) AND ALL PLUMBING CONNECTIONS, P-TRAPS, VENT LINES, AND ALL CODE REQUIRED ASSOCIATED PIPING CONNECTIONS FOR NEW PLUMBING FIXTURES TO EXISTING FACILITY PLUMBING SYSTEMS BELOW FLOOR. CONTRACTOR TO VERIFY ALL CONNECTIONS REQUIRED IN SUB-BASEMENT. SEE PLUMBING SCHEDULE THIS SHEET AND SHEET ID-102 FOR ELEVATIONS AND DIMENSIONS.
3. INSTALL NEW LAVATORY (P3) AND ALL PLUMBING CONNECTIONS, P-TRAPS, VENT LINES, AND ALL CODE REQUIRED ASSOCIATED PIPING CONNECTIONS FOR NEW PLUMBING FIXTURES TO EXISTING FACILITY PLUMBING SYSTEMS BELOW FLOOR. CONTRACTOR TO VERIFY ALL CONNECTIONS REQUIRED IN SUB-BASEMENT. SEE PLUMBING SCHEDULE THIS SHEET AND SHEET ID-102 FOR ELEVATIONS AND DIMENSIONS.
4. INSTALL NEW SHOWER ASSEMBLY (P4) AND ALL PLUMBING CONNECTIONS, P-TRAPS, VENT LINES, AND ALL CODE REQUIRED ASSOCIATED PIPING CONNECTIONS FOR NEW PLUMBING FIXTURES TO EXISTING FACILITY PLUMBING SYSTEMS BELOW FLOOR. CONTRACTOR TO VERIFY ALL CONNECTIONS REQUIRED IN SUB-BASEMENT. SEE PLUMBING SCHEDULE THIS SHEET AND SHEET ID-102 FOR ELEVATIONS AND DIMENSIONS.
5. INSTALL NEW LUXE LINEAR FLOOR DRAIN (P5) AND ALL PLUMBING CONNECTIONS, P-TRAPS, VENT LINES, AND ALL CODE REQUIRED ASSOCIATED PIPING CONNECTIONS FOR NEW PLUMBING FIXTURES TO EXISTING FACILITY PLUMBING SYSTEMS BELOW FLOOR. CONTRACTOR TO VERIFY ALL CONNECTIONS REQUIRED IN SUB-BASEMENT. SEE PLUMBING SCHEDULE THIS SHEET.
6. NEW LUXE LINEAR FLOOR DRAIN SHALL BE INSTALLED FLUSH WITH FINISHED FLOOR. PLUMBING CONTRACTOR TO COORDINATE INSTALLATION WITH FLOORING CONTRACTOR AND REFER TO SHEET A-101 FOR DIMENSIONAL LOCATION.


PLUMBING GENERAL NOTES

1. FIELD VERIFY EXISTING CONDITIONS PRIOR TO BEGINNING WORK.
2. REFER TO PROJECT MANUAL FOR SPECIFICATIONS AND OTHER CONTRACT REQUIREMENTS.
3. THE CONTRACTOR IS RESPONSIBLE FOR CONFIRMING AND CORRELATING ALL QUANTITIES, SIZES, CAPACITIES, ACCESSORIES, SEQUENCES, MATERIALS, MEANS AND METHODS, PERFORMANCE, FABRICATION PROCESSES, AND TECHNIQUES OF FABRICATION PROCESSES, AND TECHNIQUES OF CONSTRUCTION. THE CONTRACTOR SHALL COORDINATE ALL WORK WITH THAT OF OTHER TRADES. THE CONTRACTOR IS SOLELY RESPONSIBLE FOR DESIGN/BUILD CHANGES, EQUIPMENT SUBSTITUTIONS, AND VALUE ENGINEERING CHANGES PERFORMED BY THE CONTRACTOR.
4. DO NOT SCALE DRAWINGS FOR DRAIN LOCATIONS NEAR OR SERVING EQUIPMENT. OBTAIN EQUIPMENT PAD LOCATIONS AND EQUIPMENT CONNECTION REQUIREMENTS FROM OTHER CONTRACT DIVISIONS PRIOR TO LOCATING DRAINS.
5. SEAL ALL PIPING PENETRATIONS AIR TIGHT THRU WALLS, FLOORS, OR PARTITIONS IDENTIFIED AS SOUND WALLS, SMOKE TIGHT WALLS, FIRE BARRIERS, SMOKE BARRIERS, SHAFTS OR FIRE RATED CONSTRUCTION INDICATED ON THE ARCHITECTURAL LIFE SAFETY DRAWINGS. MAINTAIN ALL DESIGNATED FIRE RATINGS, SMOKE AND UL LISTINGS.
6. REFER TO ARCHITECTURAL REFLECTED CEILING PLAN FOR FINAL LOCATIONS OF CEILING MOUNTED EQUIPMENT.
7. COORDINATE ALL PIPE CONNECTIONS REQUIRED FOR OWNER FURNISHED EQUIPMENT. PROVIDE SHUT-OFF VALVES, WATER FILTERS, ETC. AS REQUIRED FOR COMPLETE INSTALLATION AND RECOMMENDED BY EQUIPMENT MANUFACTURER. VERIFY EXACT REQUIREMENTS WITH EQUIPMENT MANUFACTURER.
8. INSTALL SHUT-OFF VALVES, CONTROL VALVES, DRAIN VALVE, AIR VENTS, AND ACCESSORIES IN ACCESSIBLE LOCATIONS, DEVICES LOCATED ABOVE CEILING TO MAINTAIN ACCESSIBILITY.
9. PROVIDE VALVE HANDLE EXTENSIONS FOR ALL VALVES SERVING INSULATED PIPING. ALL VALVE HANDLES MUST BE AT LEAST 1" ABOVE THE TOP OF THE SURFACE OF THE INSULATION.
10. EXPOSED PIPING IN OCCUPIED ROOMS WITH SUSPENDED CEILINGS IS PROHIBITED.
11. PRIOR TO MAKING ANY NEW PLUMBING FLOOR PENETRATIONS IN EXISTING BUILDINGS, X-RAY THE EXISTING CONSTRUCTION TO AVOID INTERFERENCES WITH STEEL REINFORCEMENT. COORDINATE WITH THE GENERAL CONTRACTOR.
12. AREAS OF THE BUILDING UTILIZING THE SPACE ABOVE SUSPENDED CEILINGS AND MECHANICAL EQUIPMENT ROOMS AS RETURN AIR PLENUMS SHALL COMPLY WITH NFPA 90A FOR ALLOWABLE MATERIALS WITHIN PLENUMS.
13. DESIGN OF ALL PLUMBING EQUIPMENT SUPPORTS SHALL BE THE RESPONSIBILITY OF THE PLUMBING CONTRACTOR.
14. REFER TO THE SITE UTILITY DRAWINGS FOR CONTINUATION OF THE BUILDING WATER AND SEWER LATERALS EXTENDING BEYOND 5 FEET FROM THE BUILDING.
15. POWDER-ACTUATED ANCHORS ARE PROHIBITED.
16. RING AND CLEVIS PIPE HANGERS SHALL BE OVERSIZED TO ACCOMMODATE THE OUTSIDE DIAMETER OF THE PIPE INSULATION.
17. ALL PIPE INSULATION ENDS SHALL BE SEALED AT THRU-WALL AND IN-WALL STUD FRAMING PENETRATIONS.
18. ALL NON-INSULATED PIPING WITHIN WALLS SHALL HAVE GROMMETS INSTALLED AT PENETRATIONS THRU WALL FRAMING.
19. ALL LOW VOLTAGE WIRING SHALL BE INSTALLED WITHIN LABELED CONDUIT AND COMPLY WITH ELECTRICAL SPECIFICATION REQUIREMENTS.
20. PROVIDE MINIMUM 3 FEET OF CLEARANCE FOR ALL FLOOR MOUNTED PLUMBING EQUIPMENT REQUIRING REGULAR MAINTENANCE.
21. LOCATE PLUMBING ROOF VENTS AND VACUUM EXHAUST PIPING A MINIMUM OF 25 FEET FROM OUTSIDE AIR INTAKE LOUVERS AND MEDICAL AIR INLET PIPING.
22. PROVIDE SWING CHECK VALVES ON HOT AND COLD WATER BRANCH PIPING SERVING JANITOR CLOSET MOP SINKS.
23. ALL ROUGH-IN PIPING, VALVES, DEVICES, AND ACCESSORIES FOR ICE MAKERS AND COFFEE MAKERS SHALL BE LOCATED BELOW COUNTERTOPS.
24. CONTRACTOR SHALL VERIFY THE PRESENCE OF ALL EXISTING PIPING IN THE SLAB PRIOR TO BEGINNING ANY WORK.
25. CONTRACTOR TO VERIFY ALL FIELD DIMENSIONS, COORDINATE ACTUAL DIMENSIONS WITH CONSTRUCTION DOCUMENTS.
26. CONTRACTOR TO SUBMIT CONCRETE AND STEEL SHOP DRAWINGS INDICATING ACTUAL FIELD DIMENSIONS. CONTRACTOR IS RESPONSIBLE TO ENSURE CONCRETE AND STEEL TO FIT EXISTING CONDITIONS.
27. CONTRACTOR TO LOCATE AND IDENTIFY EXISTING DOMESTIC COLD AND HOT WATER SUPPLY AND RETURN, SANITARY SEWER AND VENT, DRAWINGS MERELY REPRESENTS INTENT OF PLUMBING SYSTEM. REFER TO AVAILABLE DRAWINGS FOR EXISTING CONDITIONS NOT INCLUDED IN THIS SET OF DRAWINGS.
28. CONTRACTOR TO COORDINATE WITH PLUMBING CONTRACTOR FOR DESIGN AND IMPLEMENTATION OF PROPER PLUMBING SYSTEM TO THE INTO EXISTING SYSTEMS.
29. IDENTIFICATION OF SUB-BASEMENT PLUMBING WORK WILL BE COORDINATED THRU A PRE-CONSTRUCTION WALK-THRU.
30. CONTRACTOR TO SCAN FLOOR PRIOR TO ANY CORING.
31. ALL MEP IS DESIGN BUILD.

GRAPHIC LEGEND

- EXISTING WALL TO REMAIN
- EXISTING DOOR TO REMAIN
- INFECTION CONTROL/CONSTRUCTION BARRIER WALL (IFC/CB)
- NEW WALL/PARTITION
- PLAN KEY NOTE
- NEW DOOR
- LUXE LINEAR SHOWER DRAIN

KEY PLAN

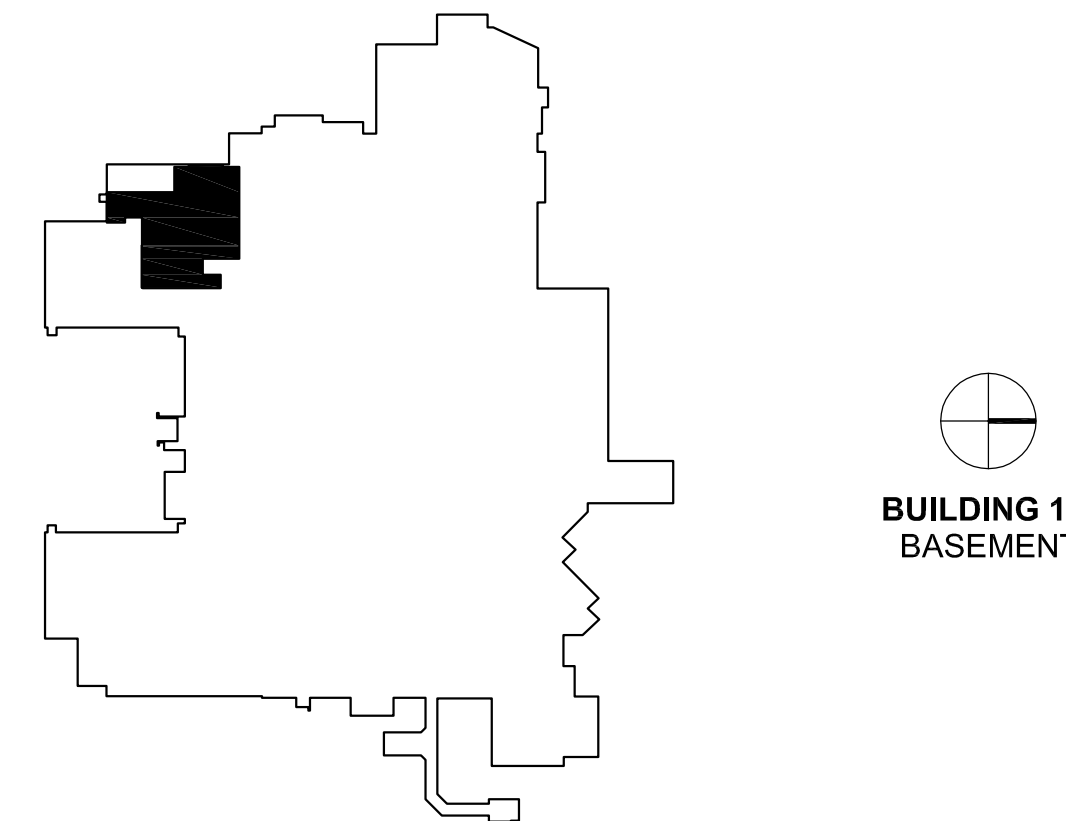

ARCHITECT:

CLEMENT J. ZABLOCKI VA MEDICAL CENTER
OFFICE OF CONSTRUCTION AND FACILITIES MANAGEMENT

Drawing Title
PHASE 1 - 3: PLUMBING FLOOR
PLANS AND SCHEDULE

Approved: Project Director

Troy Martinson, PE

Project Title
111 Upgrade Pool Locker
Rooms

Location
VA Medical Center, Milwaukee, WI

Date
August 28, 2015

Checked

Drawn
AJ

Project Number
695-14-114
Building Number
Building 111

Drawing Number
P-101

Office of
Construction
and Facilities
Management

Department of
Veterans Affairs